SITE PLAN SET FOR



PLAT MAP 319, LOTS 2, 4 & 502 ZONING DISTRICT GENERAL BUSINESS (GB)

35 WEST SHORE ROAD WARWICK, RHODE ISLAND

OWNER

319-02 RJB REALTY, LLC 75 TIPPING ROCK DRIVE EAST GREENWICH, RI 02818

319- 04& 502 E&J WEST SHORE REALTY, LLC 75 TIPPING ROCK DRIVE EAST GREENWICH, RI 02818

APPLICANT

E&J WEST SHORE REALTY, LLC 75 TIPPING ROCK DRIVE EAST GREENWICH, RI 02818

ENGINEERS



- CivilTransportationEnvironmental
- Site PlanningSurveyingPermitting
- Landscape Architecture

CROSSMAN ENGINEERING

Rhode Island
151 Centerville Road
Warwick, RI 02886
Phone: (401) 738-5660

Massachusetts
103 Commonwealth Avenue
North Attleboro, MA 02763
Phone: (508) 695-1700


Email: cei@crossmaneng.com


APRIL 2021 SHEET 1 of 18

ARCHITECT

AHARONIAN & ASSOCIATES INC. - ARCHITECTS

310 George Washington Highway - Suite 100 Smithfield, Rhode Island 02917 T 401-232-5010 F 401-232-5080

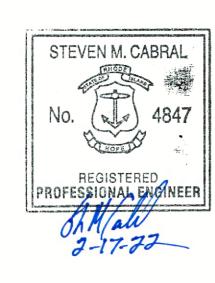

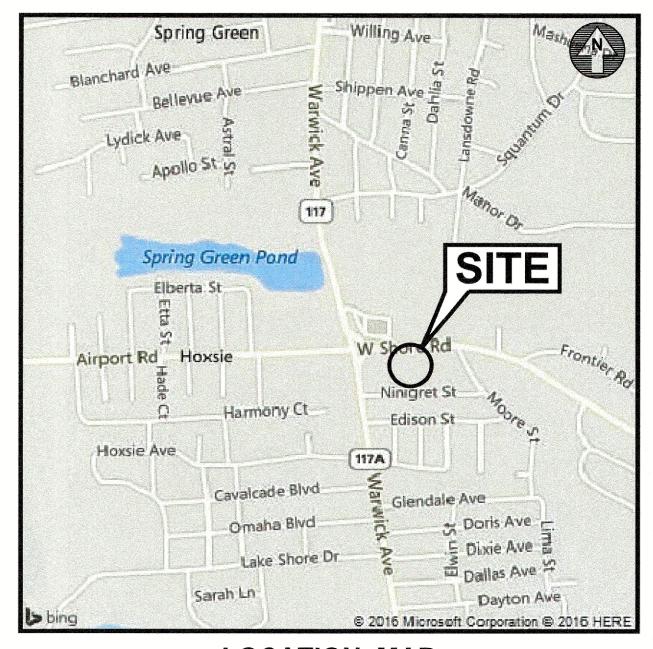

LOCATION MAP

INDEX OF DRAWINGS

DRAWING No.	PLAN
C1	GENERAL NOTES and LEGEND
C2	EXISTING AERIAL MAP
C3	200' RADIUS MAP
C4	VICINITY MAP
C5	PROPOSED AERIAL MAP
C6	SITE LAYOUT PLAN
C7	GRADING PLAN
C8	UTILITY PLAN
C9	SOIL EROSION and SEDIMENT CONTROL PLAN
C10.1	MISCELLANEOUS DETAILS PLAN No. 1
C10.2	MISCELLANEOUS DETAILS PLAN No. 2
C10.3	MISCELLANEOUS DETAILS PLAN No. 3
C10.4	MISCELLANEOUS DETAILS PLAN No. 4
C10.5	MISCELLANEOUS DETAILS PLAN No. 5
C10.6	MISCELLANEOUS DETAILS PLAN No. 6
C10.7	MISCELLANEOUS DETAILS PLAN No. 7
L1	LANDSCAPE PLAN

REFERENCE PLAN RJB REALTY PLAT, ADMINISTRATIVE SUBDIVISION PLAN PREPARED BY ALPHA ASSOCIATES, LTD., MAY 2020

 No.:
 DATE:
 DESCRIPTION:

 1
 10/1/21
 PRELIMINARY PLAN

 2
 12/1/21
 RIDEM COMMENTS

 3
 12/28/21
 RIDOT COMMENTS

 4
 2/14/22
 RIDOT COMMENTS

GENERAL NOTES

- 1. THE CONTRACTOR SHALL VERIFY THE LOCATIONS OF ALL EXISTING DRAINAGE AND UTILITIES, BOTH UNDERGROUND AND OVERHEAD, BEFORE EXCAVATION BEGINS IN ACCORDANCE WITH "DIG SAFE PROGRAM LAW" ENACTED BY THE R.I. LEGISLATURE AND BY CONTACTING THE INDIVIDUAL UTILITY COMPANIES. EXCAVATION SHALL BE IN ACCORDANCE WITH ALL STATUTES, ORDINANCES, RULES AND REGULATIONS OF ANY MUNICIPALITY, STATE OR FEDERAL AGENCY THAT MAY APPLY. ANY DAMAGE TO EXISTING UTILITIES SHALL BE THE CONTRACTOR'S
- 2. SPECIFICATIONS TO GOVERN THIS PROJECT ARE R.I.D.O.T. STANDARD SPECIFICATIONS AND DETAILS. FOR ALL EXCAVATION, PLACEMENT OF FILL, PIPE BITUMINOUS PAVEMENT, CUTTING INTO CATCHBASIN/MANHOLES, CONCRETE AND SAWCUTTING, THE CONTRACTOR SHALL PERFORM THE WORK IN FULL COMPLIANCE WITH THE RHODE ISLAND DEPARTMENT OF TRANSPORTATION STANDARD SPECIFICATIONS FOR ROAD AND BRIDGE CONSTRUCTION, MARCH 2018 EDITION, WITH LATEST REVISIONS UNLESS OTHERWISE SHOWN ON PLANS. THE "METHOD OF MEASUREMENT" AND "BASIS OF PAYMENT" ARE NOT APPLICABLE. THESE SPECIFICATIONS CAN BE OBTAINED ON-LINE AT:

http://www.dot.ri.gov/business/bluebook.php

- 3. UNLESS SPECIFICALLY REFERENCED ON THE PLANS, ALL WORK ON SITE AND WITHIN THE STATE'S RIGHT OF WAY SHALL USE THE RHODE ISLAND STANDARD DETAILS, JUNE 21, 2019, WITH ALL REVISIONS AS PREPARED BY THE DEPARTMENT OF TRANSPORTATION.
- 4. THE CONTRACTOR MUST VERIFY PRIOR TO CONSTRUCTION THAT ALL REQUIRED AUTHORIZATION TO PERFORM WORK HAS BEEN OBTAINED. THE CONTRACTOR SHALL BE SOLELY RESPONSIBLE FOR CONSTRUCTION OPERATIONS INCLUDING ALL ACTIONS OR OMISSIONS OF ANY SUBCONTRACTORS, AGENTS OR EMPLOYEES. THE CONTRACTOR MUST ENSURE THAT THE CONDITIONS OF ALL PERMITS, SPECIFICATIONS AND FEDERAL, STATE AND LOCAL REGULATIONS ARE STRICTLY ENFORCED. THE CONTRACTOR IS ALSO RESPONSIBLE FOR ASPECTS OF ON-SITE SAFETY INCLUDING ANY DAMAGE TO EXISTING STRUCTURES.
- 5. WORK SHOWN ON THE PLANS FOR WHICH THERE ARE NO PARTICULAR DETAILS OR SPECIFICATIONS DOES NOT RELIEVE THE CONTRACTOR FROM FURNISHING AND INSTALLING THE WORK. THE CONTRACTOR SHALL THOROUGHLY EXAMINE THE CONTRACT DOCUMENTS AND PLANS AND INSPECT THE SITE, AND THE BID PRICE SHALL INCLUDE ALL SERVICES AND MATERIALS NECESSARY TO COMPLETE THE PROJECT. ANY CHANGES TO THE PROJECT OR THE INSTALLATION OF AN ITEM FOR WHICH NO PARTICULAR DETAIL OR SPECIFICATION WAS PROVIDED MUST BE REVIEWED BY AND MUST BE ACCEPTABLE TO THE ENGINEER.
- 6. CONTRACTOR IS RESPONSIBLE TO VERIFY ALL EXISTING CONDITIONS AND DIMENSIONS PRIOR TO CONSTRUCTION. THE CONTRACTOR SHALL NOTIFY THE ENGINEER OF ANY DISCREPANCIES PRIOR TO ANY WORK. THE CONTRACTOR SHALL PERFORM TEST PITS TO LOCATE EXISTING UTILITY STUBS AT CONNECTION POINTS.
- 7. ALL DISTURBED AREAS SHALL BE REPLACED IN KIND UNLESS OTHERWISE SHOWN.
- 8. "APPROVED EQUAL" PRODUCTS MAY BE USED BY THE CONTRACTOR ONLY UPON APPROVAL BY THE DESIGN ENGINEER. THE CONTRACTOR IS RESPONSIBLE TO PROVIDE SUBMITTALS TO THE DESIGN ENGINEER FOR REVIEW.
- 9. THIS PROPOSED USE DOES NOT MEET THE RIDEM DEFINITION OF A LAND USE WITH HIGHER POTENTIAL POLLUTANT LOAD.
- 10. THE DETECTABLE WARNING DEVICE FOR ADA RAMPS SHALL NOT BE USED WITHIN THE STATE R.O.W. AREAS.

LAYOUT NOTE

THE LAYOUT SHOWN REPRESENTS A GRAPHICAL DESIGN, AND PRIOR TO THE CONSTRUCTION, THE CONTRACTOR SHALL ENGAGE A PROFESSIONAL LAND SURVEYOR (PLS) REGISTERED IN THE STATE OF RHODE ISLAND TO SET AND VERIFY ALL LINES AND GRADES. ALL EXISTING UTILITY LOCATIONS AND ELEVATIONS ARE TO BE CONFIRMED BY THE CONTRACTOR PRIOR TO CONSTRUCTION. ANY ITEM FOUND WHICH DOES NOT MATCH THE PLANS MUST BE BROUGHT TO THE ENGINEER'S ATTENTION PRIOR TO CONSTRUCTION FOR REVIEW. NO WORK SHALL PROCEED UNTIL AUTHORIZED BY THE ENGINEER.

MAINTENANCE AND PROTECTION OF TRAFFIC NOTES

- 1. THE CONTRACTOR SHALL BE RESPONSIBLE FOR ALL MAINTENANCE AND PROTECTION OF PEDESTRIAN AND VEHICULAR TRAFFIC INCLUDING POLICE PROTECTION. ALL TEMPORARY CONSTRUCTION SIGNS, BARRICADES AND LANE CLOSURES SHALL BE IN CONFORMANCE WITH THE LATEST REVISIONS OF MANUAL OF UNIFORM TRAFFIC CONTROL DEVICES (M.U.T.C.D.)
- 2. TEMPORARY CONSTRUCTION SIGNS AND ALL APPLICABLE TRAFFIC CONTROL DEVICES SHALL BE IN PLACE PRIOR TO THE START OF WORK IN ANY AREA OPEN TO TRAFFIC.
- 3. THE PRIVATE VEHICLES OF CONSTRUCTION WORKERS WILL NOT BE PARKED IN THE ROADWAY RIGHT-OF-WAY.
- 4. ALL MAINTENANCE AND PROTECTION OF TRAFFIC CONTROL SETUPS, SIGNS, CHANNELING DEVICES, ETC., SHALL BE IN ACCORDANCE WITH THE MANUAL ON UNIFORM TRAFFIC CONTROL DEVICES, 2009 EDITION, LATEST REVISIONS.
- 5. SIGN MOUNTINGS SHALL BE IN ACCORDANCE WITH THE STATE D.O.T. SPECIFICATIONS FOR TEMPORARY CONSTRUCTION SIGNS.

CONSTRUCTION NOTES

- 1. THE CONTRACTOR IS REQUIRED TO OBTAIN AND REVIEW ALL ENGINEERING AND PERMIT DOCUMENTS COMPLETED FOR FINAL DESIGN.
- 2. THE CONTRACTOR SHALL NOTIFY THE ENGINEER PRIOR TO INSTALLATION OF UTILITIES ON SITE. THE COORDINATION IS NECESSARY FOR THE ENGINEER TO SCHEDULE SITE INSPECTIONS AS
- 3. THE CONTRACTOR IS REQUIRED TO MAINTAIN DETAILED AS-BUILT INFORMATION FOR ALL UTILITY INSTALLATION. AS-BUILT INFORMATION INCLUDES MATERIAL LIST, PIPE DEPTH NOTATIONS AND SWING TIE LOCATIONS (2 MINIMUM) FROM NEW PIPE TO PERMANENT STRUCTURES. ALL PIPE BEND/ELBOW LOCATIONS SHALL BE DIMENSIONED.

FLOOD ZONE NOTE

THE SITE IS WITHIN FLOOD ZONE X, AREAS OF MINIMAL FLOODING, ACCORDING TO THE FEMA NATIONAL FLOOD HAZARD LAYER FIRMETTE, CITY OF WARWICK 445409,, MAP NUMBER 44003C0132H, EFFECTIVE DATE 9/18/2013.

PERMITTING NOTES

- 1. THERE ARE NO WETLANDS WITHIN 200' OF THE SITE. A RIDEM WETLAND PERMIT IS NOT
- 2. WEST SHORE ROAD IS A RIDOT MAINTAINED ROADWAY. A RIDOT PAP IS REQUIRED.
- THE PROPOSED IMPROVEMENTS WILL RESULT IN MORE THAN 1 ACRE OF SOIL DISTURBANCE. A RIDEM RIPDES PERMIT IS REQUIRED.
- 4. A RIDEM PERMIT FOR THE PROPOSED UNDERGROUND STORMWATER INFILTRATION SYSTEM IS REQUIRED (GROUNDWATER DISCHARGE SYSTEM APPROVAL).
- 5. THE SITE IS NOT WITHIN A RIDEM NATURAL HERITAGE AREA.
- 6. A SEPERATE UTILITY PERMIT APPLICATION WILL BE REQUIRED FROM RIDOT FOR EACH UTILITY. THE CONTRACTOR SHALL SUBMIT FOR THESE UTILITY PERMIT APPLICATIONS PRIOR TO CONSTRUCTION.

PROPOSED PAVEMENT STRUCTURE

1 1/2" BITUMINOUS CONCRETE SURFACE COURSE, CLASS 12.5 HMA 2 1/2" BITUMINOUS CONCRETE BASE COURSE, CLASS 19.5 HMA

NOTE: THE PAVEMENT THICKNESS WITHIN THE WEST SHORE ROAD RIGHT OF WAY SHALL MATCH THE CURRENT PAVEMENT THICKNESS OF WEST SHORE ROAD

STORMWATER MANAGEMENT SYSTEM - MAINTENANCE OPERATION

UPON PROJECT COMPLETION. THE SITE OWNER SHALL ADHERE TO THE FOLLOWING MAINTENANCE RECOMMENDATIONS.

1. CATCHBASINS, MANHOLES, AND CLEAN-OUTS:

INSPECTION SHALL OCCUR ON AN ANNUAL BASIS BY QUALIFIED PERSONNEL TO ENSURE PROPER OPERATION. THE INSPECTION SHOULD, AS A MINIMUM, CONCENTRATE ON THE FOLLOWING:

- - DAMAGE TO GRATE/COVER - EVIDENCE OF STANDING WATER
- DEBRIS REMOVAL STRUCTURAL ALIGNMENT/INTEGRITY
- 2. WATER QUALITY CHAMBER:

12" GRAVEL BORROW SUBBASE

ANNUAL INSPECTIONS AND MAINTENANCE OF THE STORMCEPTOR DEVICE IS REQUIRED TO MINIMIZE STORMWATER POLLUTION AND FLOODING. THE CONTRACTOR SHALL ENSURE THE STRUCTURE IS CLEAN UPON CONSTRUCTION COMPLETION. FOLLOWING CONSTRUCTION. ANNUAL INSPECTIONS SHALL BE CONDUCTED AND RECORD OF FINDINGS OF THE INSPECTIONS SHALL BE MAINTAINED BY THE OWNER. THE STORMCEPTOR DEVICE IS REQUIRED TO BE CLEANED WHENEVER SEDIMENT DEPTHS REACH 15% OF THE UNIT'S TOTAL STORAGE CAPACITY

3. SEDIMENT REMOVAL:


FOLLOWING CONSTRUCTION. SEDIMENT REMOVAL SHALL BE CONDUCTED AS DEEMED NECESSARY BY THE SYSTEM INSPECTIONS. ALL REMOVED SEDIMENT IS TO BE TESTED TO DETERMINE POLLUTANT CONTENT. THE SEDIMENT IS TO BE PROPERLY DISPOSED IN UPLAND AREAS BASED UPON THE TEST RESULTS AND LOCAL, STATE, AND FEDERAL REGULATIONS.

4. UNDERGROUND INFILTRATION SYSTEM:

THE UNDERGROUND INFILTRATION SYSTEM SHALL BE INSPECTED ANNUALLY AFTER CONSTRUCTION. INSPECT THE INLET PIPES AND OUTLET PIPES FOR CLOGGING. REMOVE ACCUMULATED SEDIMENT. TRASH AND DEBRIS. INSPECT SYSTEM AND OUTLET STRUCTURE FOR STRUCTURAL INTEGRITY AND STANDING WATER. INSPECT PAVEMENT AREA OVER SYSTEM FOR SETTLEMENT.

5. ANNUAL SWEEPING:

ANNUAL PARKING LOT AND DRIVEWAY SWEEPING SHALL BE CONDUCTED DURING THE SPRING OF EVERY YEAR.

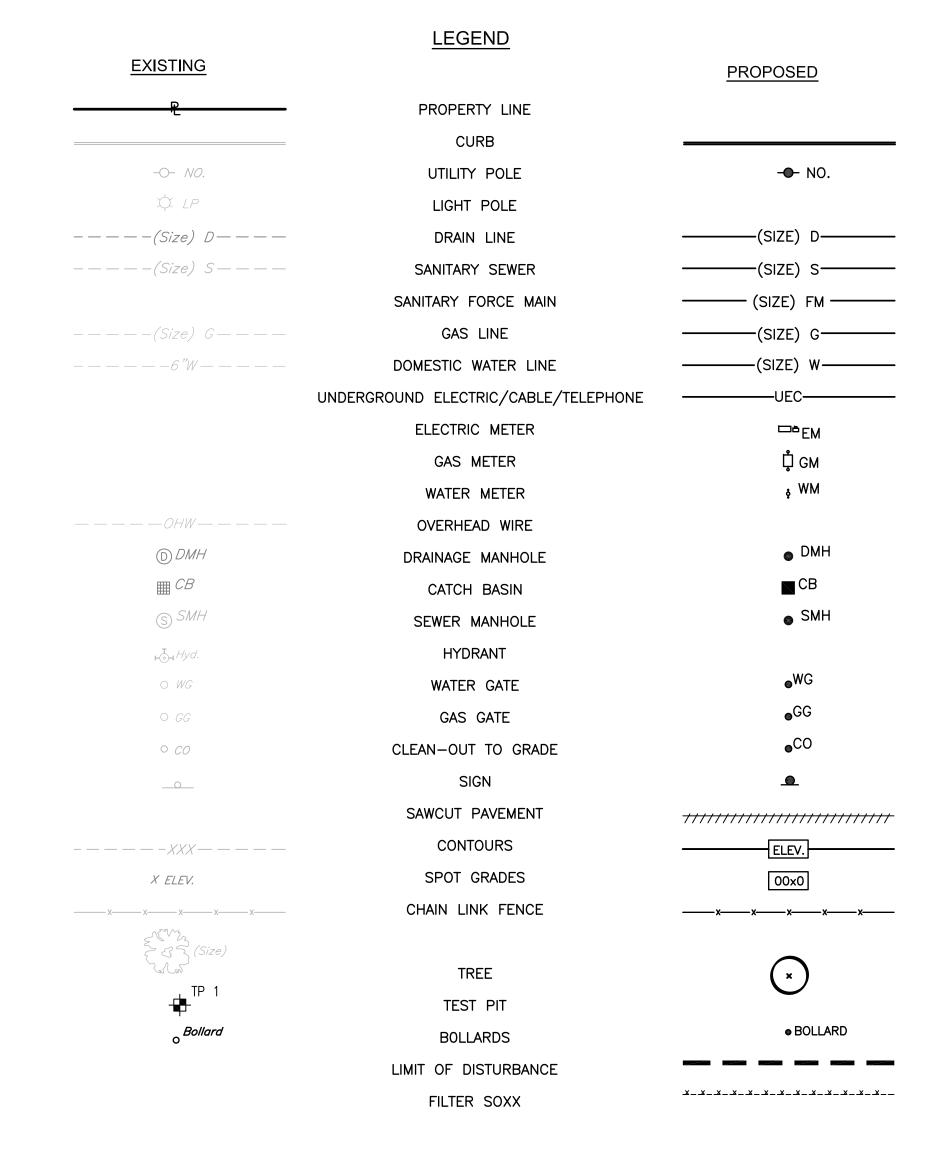



 Environmental Site Planning Surveying Permitting

Landscape Architectur

Crossman Engineering

151 Centerville Road 103 Commonwealth Avenue Warwick, RI 02886 North Attleboro, MA 02763 Phone (401) 738-5660 Phone (508) 695-1700

Email: cei@crossmaneng.com

THESE DRAWINGS ARE THE PROPERTY OF CROSSMAN FNGINFFRING AND HAVE RFFN PRFPARFD FOR THFIR CLIFNT FOR A SPECIFIC SITE AND PROJECT, THESE DRAWINGS ARI NOT TO BE COPIED OR USED FOR ANY OTHER PURPOSE WITHOUT THE WRITTEN CONSENT OF CROSSMAN ENGINEERING

KEY PLAN

PROJECT TITLE:

PROPOSED

PLAT MAP 319, LOTS 2, 4 & 502 ZONING DISTRICT **GENERAL BUSINESS 35 WEST SHORE ROAD** WARWICK, RHODE ISLAND

PREPARED FOR:

E&J WEST SHORE REALTY, LLC

75 TIPPING ROCK DRIVE **EAST GREENWICH, RI** 02818

DRAWING TITLE:

GENERAL NOTES and LEGEND

APRIL 2021 NO SCALE DWG. NAME:

2416-02-NOTE.dwg

REVISIONS

NUMBERREMARKSDATEPRELIMINARY PLAN | 10/1/21 | RIDEM COMMENTS | 12/1/21 RIDOT COMMENTS | 12/28/21 RIDOT COMMENTS | 2/14/22

DRAWING NUMBER

SHEET: 2 OF: 18





Landscape Architecture Crossman Engineering

Site Planning

Rhode Island
151 Centerville Road
Warwick, RI 02886
Phone (401) 738-5660

Massachusetts
103 Commonwealth Avenue
North Attleboro, MA 02763
Phone (508) 695-1700

Email: cei@crossmaneng.com

THESE DRAWINGS ARE THE PROPERTY OF CROSSMAN ENGINEERING AND HAVE BEEN PREPARED FOR THEIR CLIENT FOR A SPECIFIC SITE AND PROJECT. THESE DRAWINGS ARE NOT TO BE COPIED OR USED FOR ANY OTHER PURPOSE WITHOUT THE WRITTEN CONSENT OF CROSSMAN ENGINEERING.

KEY PLAN

PROJECT TITLE:

PROPOSED

DUNKIN!

PLAT MAP 319, LOTS 2, 4 & 502 **ZONING DISTRICT GENERAL BUSINESS** 35 WEST SHORE ROAD WARWICK, RHODE ISLAND

PREPARED FOR:

E&J WEST SHORE REALTY, LLC


75 TIPPING ROCK DRIVE EAST GREENWICH, RI 02818

DRAWING TITLE:

EXISTING AERIAL MAP

DATE:		SCALE:	
APRIL 2021		1"=30'	
DWG. NAME:	440 07		
2	416-03-	EX-AERIAL	dwg
<i>REVISIONS</i>			
\triangle			
NUMBER	REMA	4 <i>RK</i> S	DATE
1	PRELIMINA	ARY PLAN	10/1/21
2	RIDEM C	OMMENTS	12/1/21
3	RIDOT CO	OMMENTS	12/28/21
4	RIDOT CO	OMMENTS	2/14/22

DRAWING NUMBER

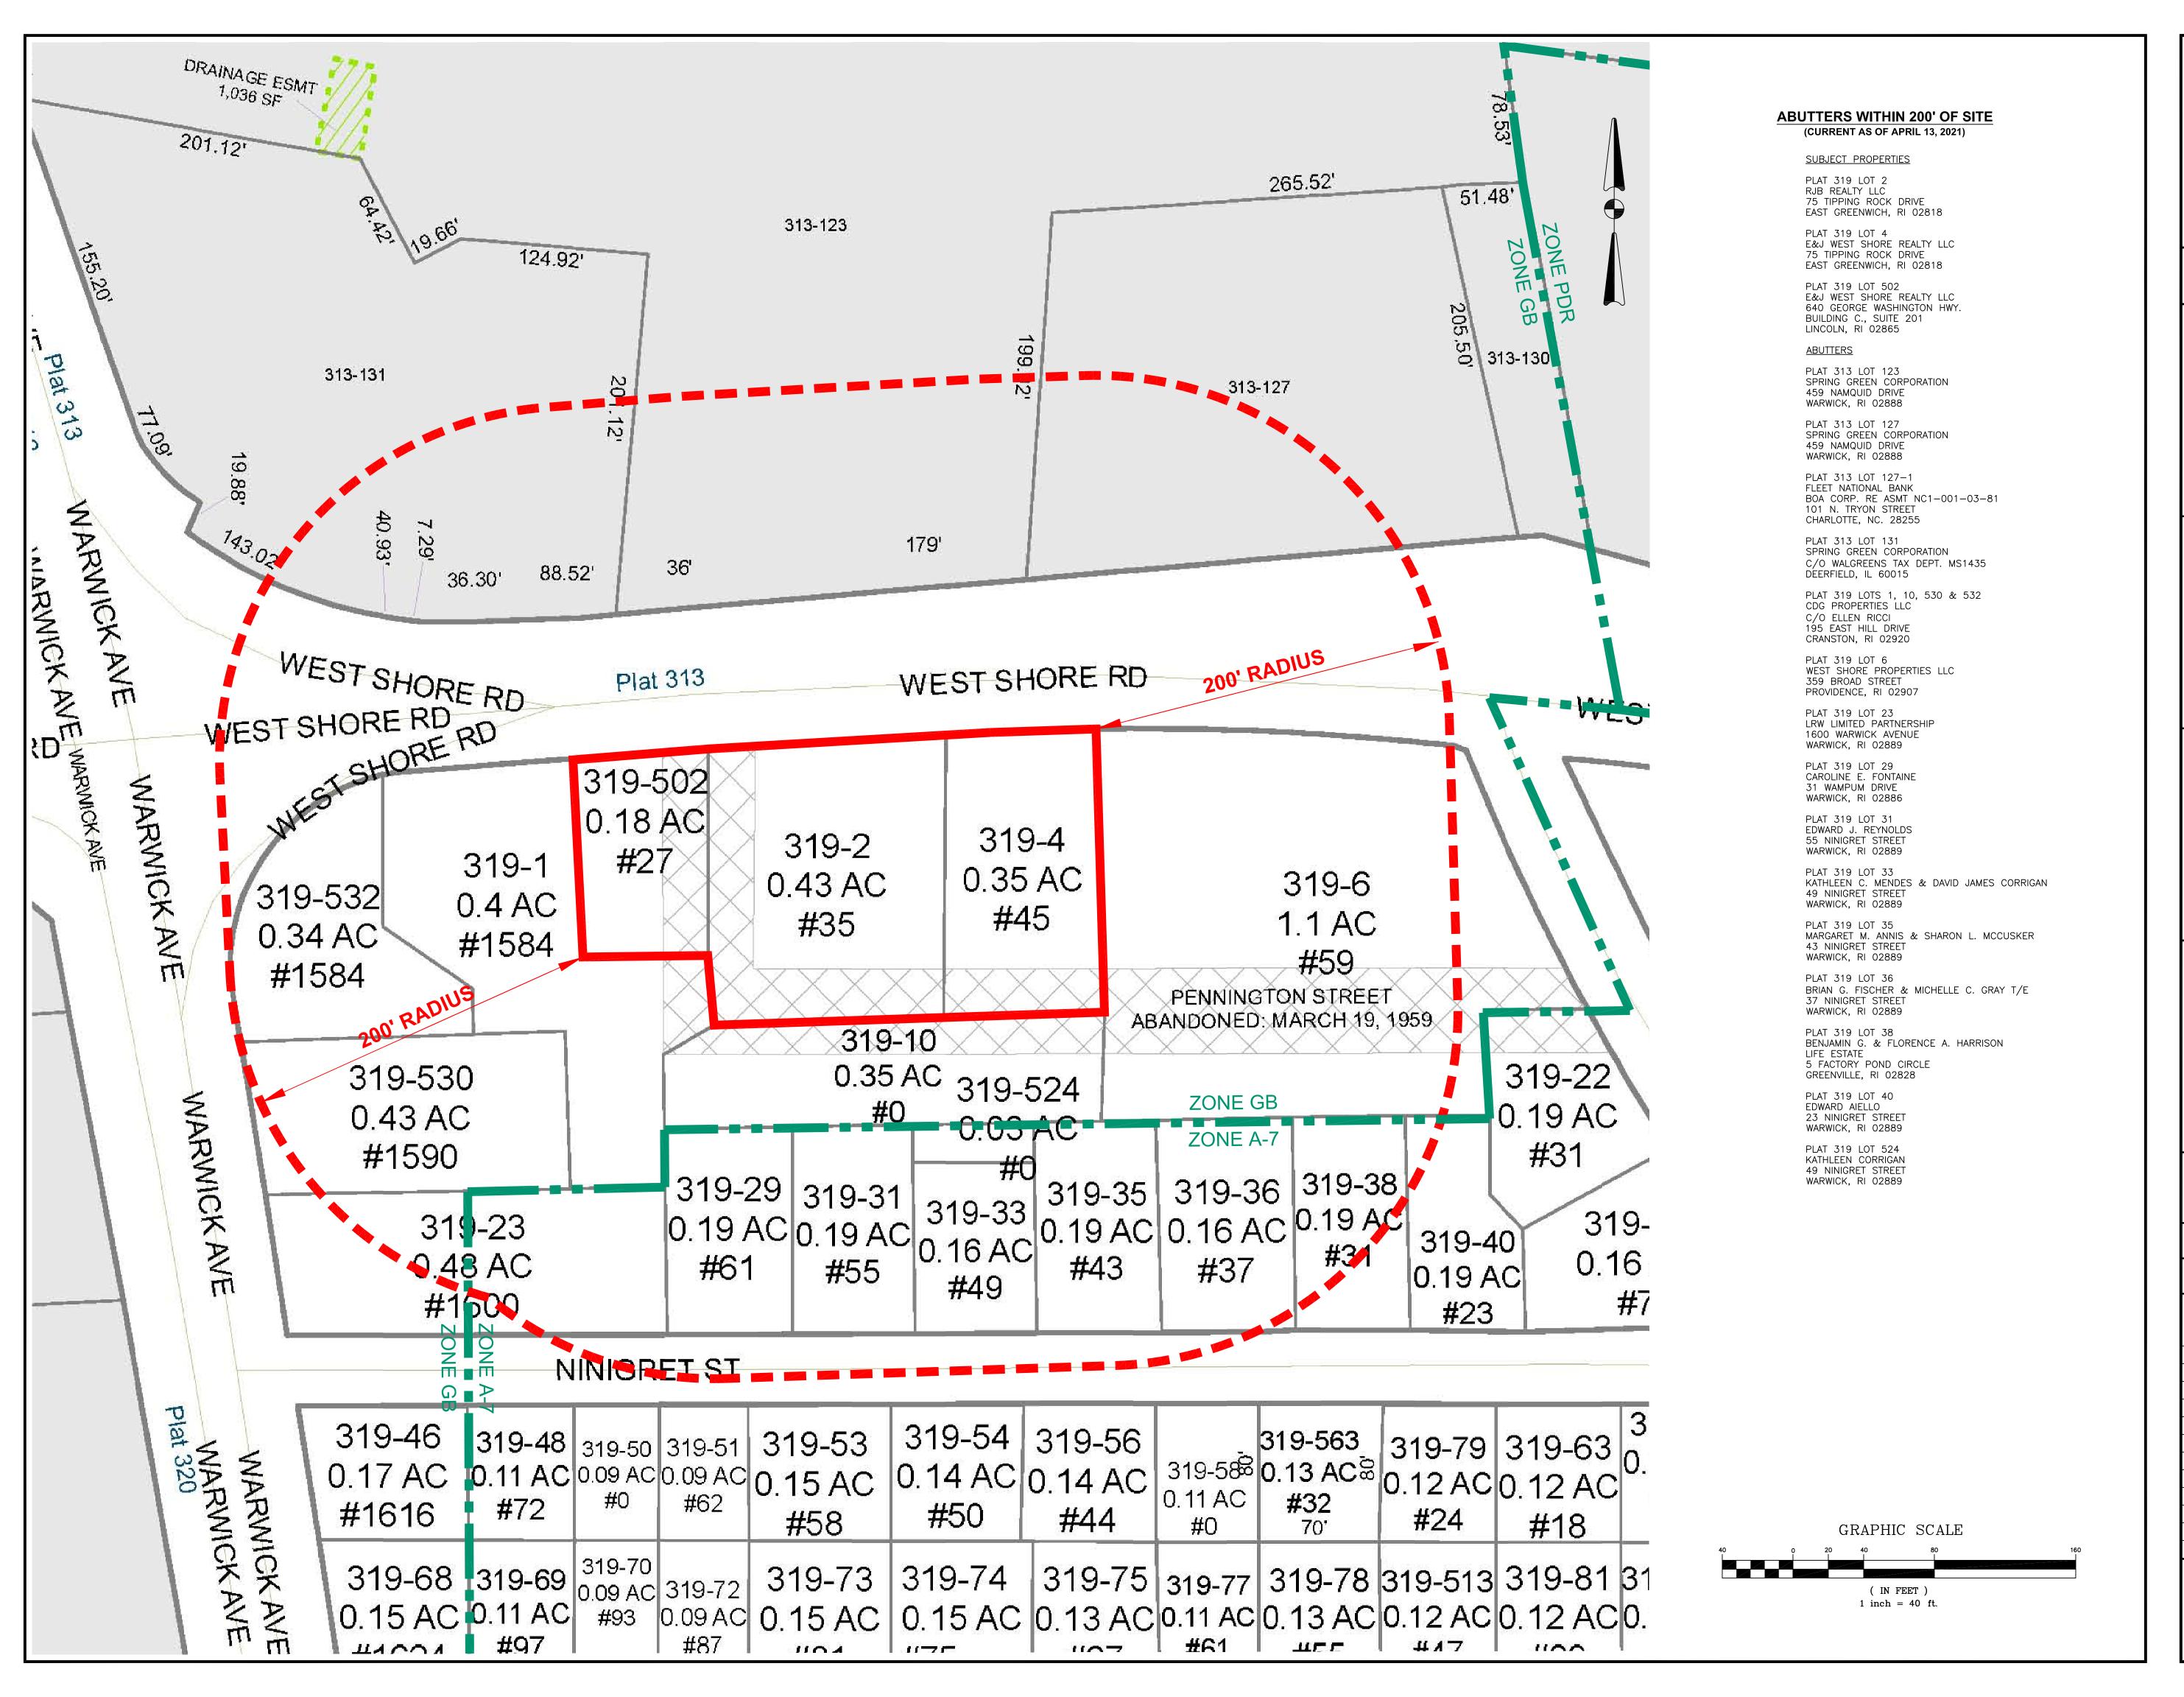



 Permitting Landscape Architectu

Site Planning Surveying

Crossman Engineering

151 Centerville Road 103 Commonwealth Avenue Warwick, RI 02886 North Attleboro, MA 02763 Phone (401) 738-5660 Phone (508) 695-1700

Email: cei@crossmaneng.com

THESE DRAWINGS ARE THE PROPERTY OF CROSSMAN NGINEERING AND HAVE BEEN PREPARED FOR THEIR CLIEN FOR A SPECIFIC SITE AND PROJECT. THESE DRAWINGS ARI NOT TO BE COPIED OR USED FOR ANY OTHER PURPOSE

WITHOUT THE WRITTEN CONSENT OF CROSSMAN ENGINEERIN

KEY PLAN

PROJECT TITLE:

PROPOSED

DUNKIN!

PLAT MAP 319, LOTS 2, 4 & 502 **ZONING DISTRICT GENERAL BUSINESS WARWICK, RHODE ISLAND**

PREPARED FOR:

E&J WEST SHORE REALTY, LLC

75 TIPPING ROCK DRIVE EAST GREENWICH, RI 02818

DRAWING TITLE:

APRIL 2021


200' RADIUS MAP

1"=40'

DWG. NAME:				
2	416-04-RADIUS.dw	g		
REVISIONS				
\triangle				
NUMBER	REMARKS	DATE		
1	PRELIMINARY PLAN	10/1/21		
2	RIDEM COMMENTS	12/1/21		
3	RIDOT COMMENTS	12/28/21		
4	RIDOT COMMENTS	2/14/22		

DRAWING NUMBER

SHEET: 4 OF: 19

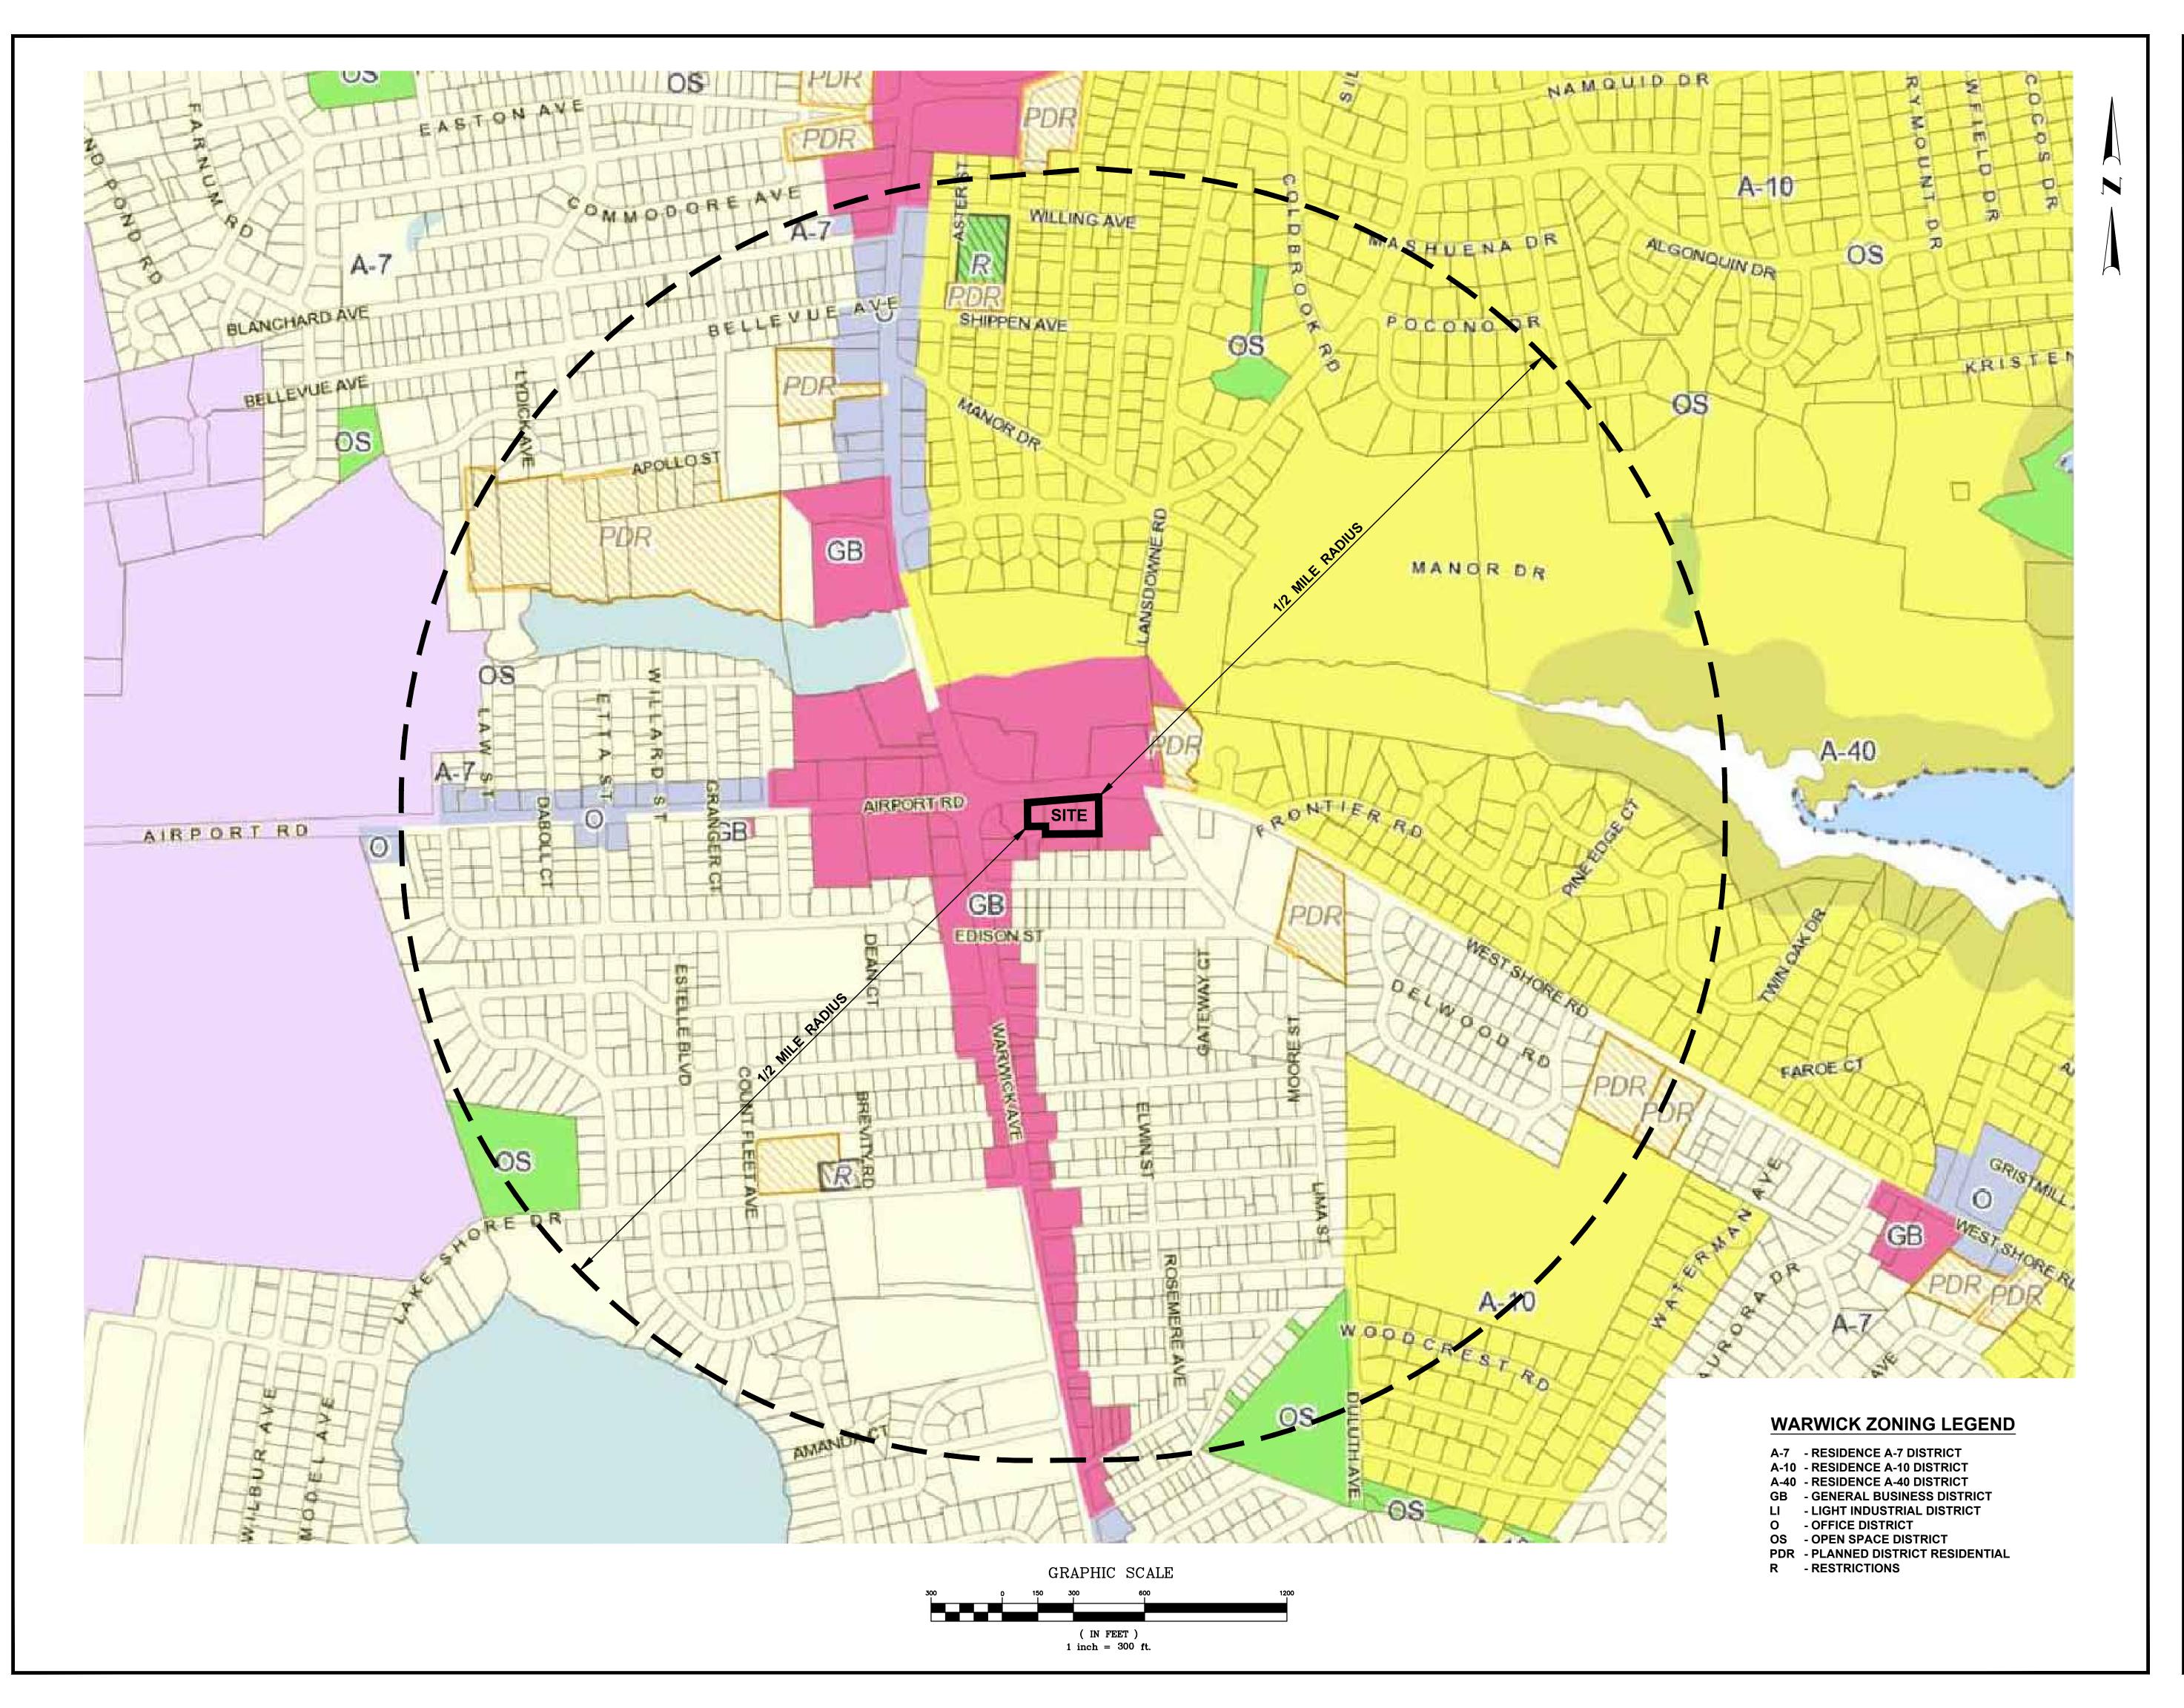



TransportationEnvironmental Site Planning SurveyingPermitting Landscape Architecture

Civil

Crossman Engineering

Rhode Island
151 Centerville Road
Warwick, RI 02886
Phone (401) 738-5660

Massachusetts
103 Commonwealth Avenue
North Attleboro, MA 02763
Phone (508) 695-1700

Email: cei@crossmaneng.com

THESE DRAWINGS ARE THE PROPERTY OF CROSSMAN ENGINEERING AND HAVE BEEN PREPARED FOR THEIR CLIENT FOR A SPECIFIC SITE AND PROJECT. THESE DRAWINGS ARE NOT TO BE COPIED OR USED FOR ANY OTHER PURPOSE WITHOUT THE WRITTEN CONSENT OF CROSSMAN ENGINEERING.

KEY PLAN

PROJECT TITLE:

PROPOSED

DUNKIN!

PLAT MAP 319, LOTS 2, 4 & 502 **ZONING DISTRICT GENERAL BUSINESS 35 WEST SHORE ROAD WARWICK, RHODE ISLAND**

PREPARED FOR:

E&J WEST SHORE REALTY, LLC

75 TIPPING ROCK DRIVE EAST GREENWICH, RI 02818

DRAWING TITLE:

VICINITY MAP

1"=300' APRIL 2021 DWG. NAME:


REVISIONS ∧

2416-05-VICINITY.dwg

\triangle		
NUMBER	REMARKS	DATE
1	PRELIMINARY PLAN	10/1/21
2	RIDEM COMMENTS	12/1/21
3	RIDOT COMMENTS	12/28/21
4	RIDOT COMMENTS	2/14/22

DRAWING NUMBER

SHEET: 5 OF: 18

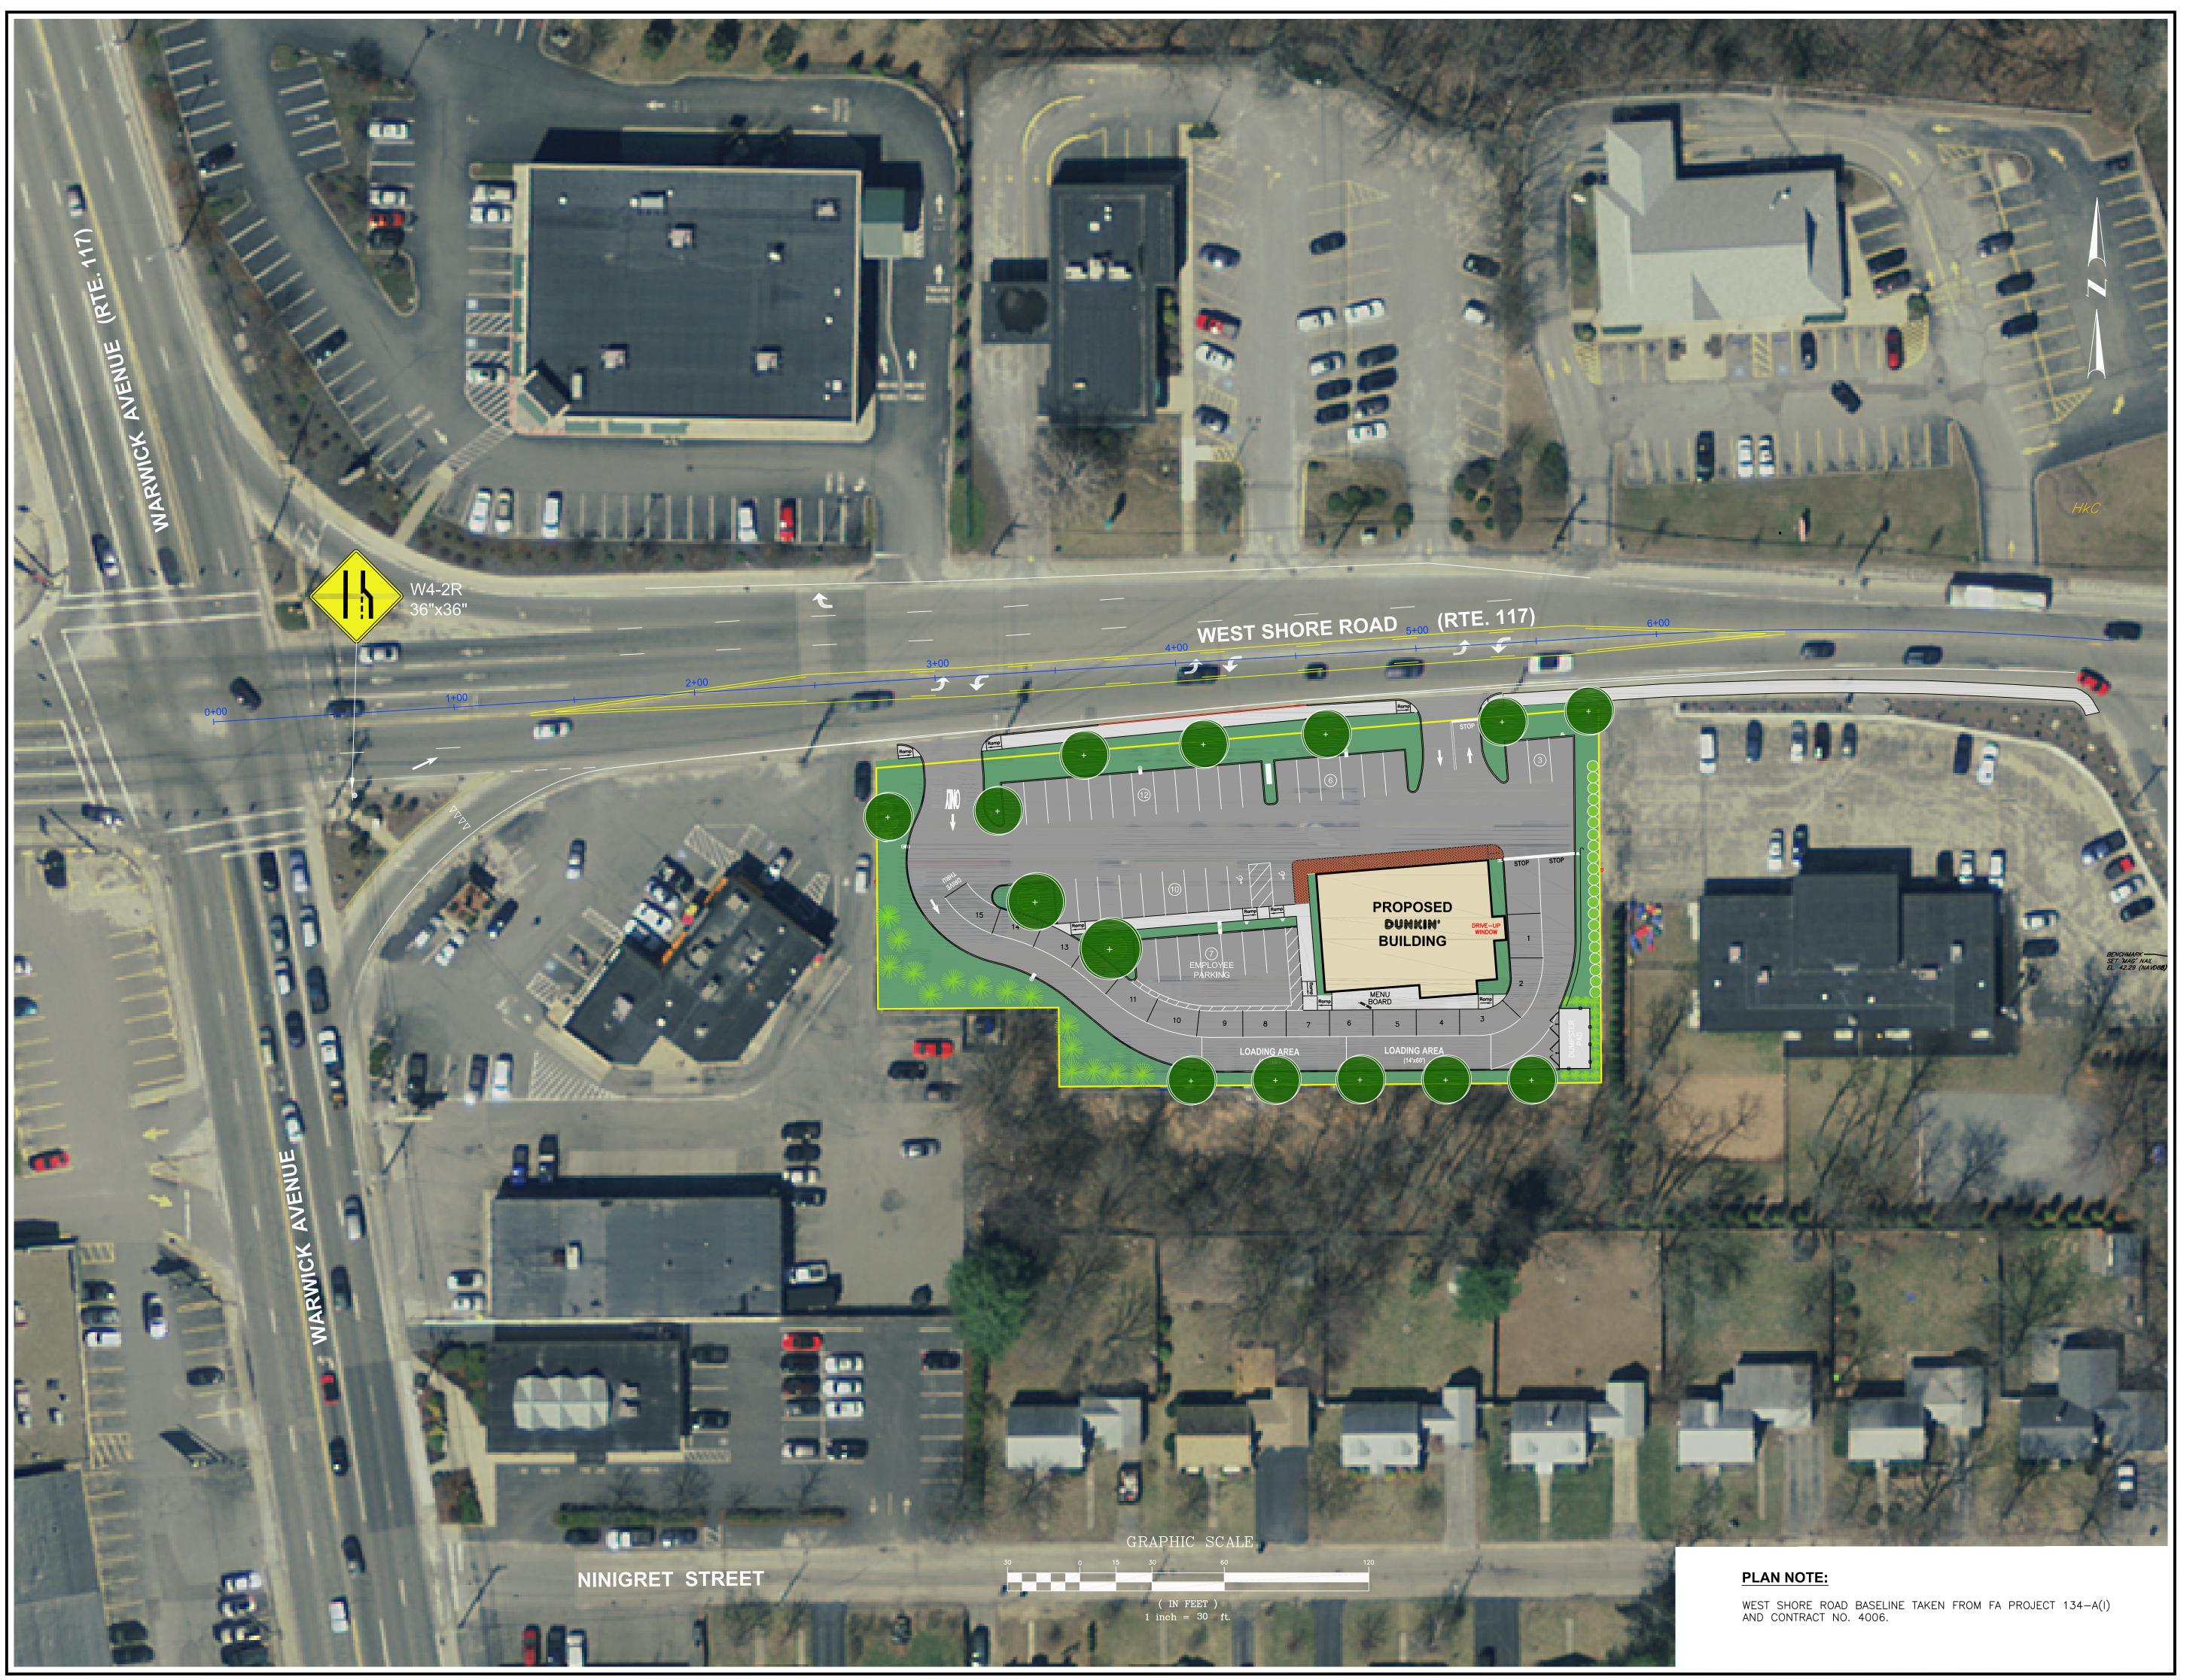



CivilTransportationEnvironmental Site Planning SurveyingPermitting

Crossman Engineering

Rhode Island
151 Centerville Road
Warwick, RI 02886
Phone (401) 738-5660

Massachusetts
103 Commonwealth Avenue
North Attleboro, MA 02763
Phone (508) 695-1700

Email: cei@crossmaneng.com

THESE DRAWINGS ARE THE PROPERTY OF CROSSMAN ENGINEERING AND HAVE BEEN PREPARED FOR THEIR CLIENT FOR A SPECIFIC SITE AND PROJECT. THESE DRAWINGS ARE NOT TO BE COPIED OR USED FOR ANY OTHER PURPOSE WITHOUT THE WRITTEN CONSENT OF CROSSMAN ENGINEERING.

PROJECT TITLE:

PROPOSED DUNKIN!

PLAT MAP 319, LOTS 2, 4 & 502 **ZONING DISTRICT GENERAL BUSINESS** 35 WEST SHORE ROAD WARWICK, RHODE ISLAND

PREPARED FOR:

E&J WEST SHORE REALTY, LLC

75 TIPPING ROCK DRIVE EAST GREENWICH, RI 02818


DRAWING TITLE:

PROPOSED AERIAL MAP

<i>date:</i> April 2021		SCALE: 1"=30'	
7 (T (T)		!	_50
DWG. NAME:			
2	416-06-1	PR-AERIAL	dwg
REVISIONS			
\triangle			
NUMBER	REMA	4 <i>RK</i> S	DATE
1	PRELIMINA	ARY PLAN	10/1/21
2	RIDEM CO	OMMENTS	12/1/21
3	RIDOT CO	OMMENTS	12/28/21
4	RIDOT CO	OMMENTS	2/14/22

DRAWING NUMBER

SHEET: 6 OF: 18

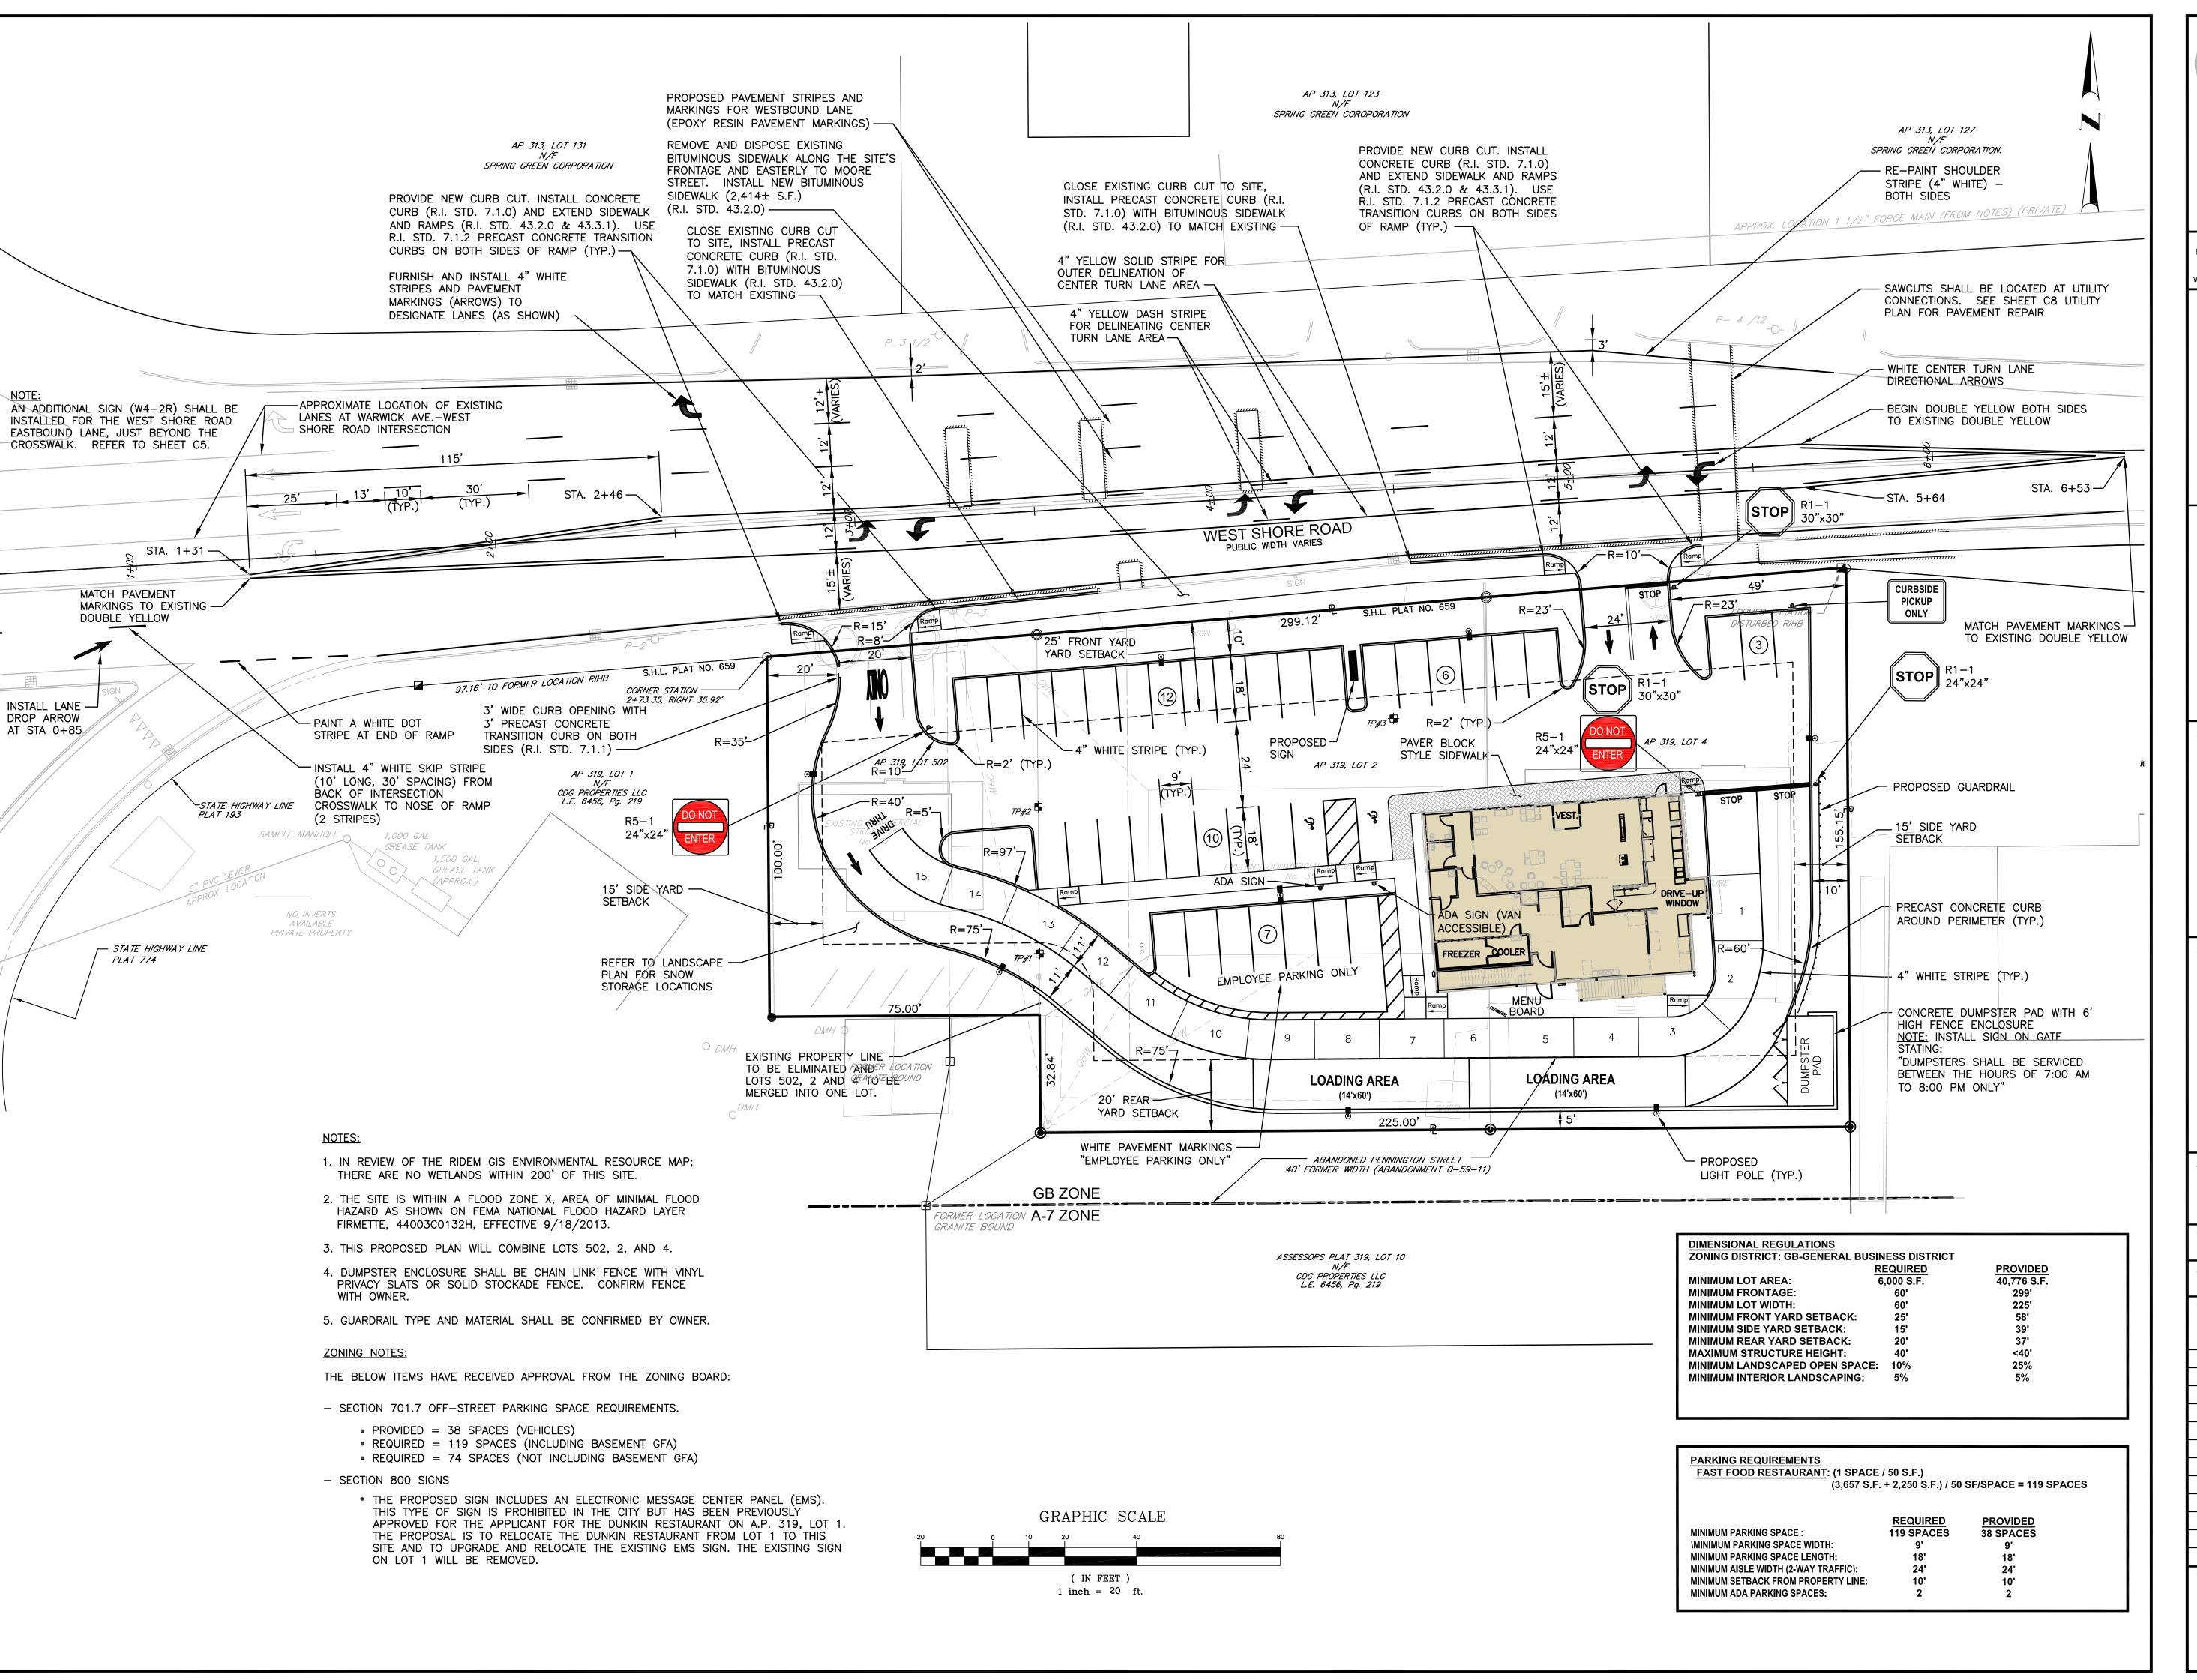



 Surveying Permitting Landscape Architecture

Crossman Engineering

151 Centerville Road 103 Commonwealth Avenue Warwick, RI 02886 North Attleboro, MA 02763 Phone (401) 738-5660 Phone (508) 695-1700

Email: cei@crossmaneng.com

THESE DRAWINGS ARE THE PROPERTY OF CROSSMAN ENGINEERING AND HAVE BEEN PREPARED FOR THEIR CLIENT FOR A SPECIFIC SITE AND PROJECT. THESE DRAWINGS ARE NOT TO BE COPIED OR USED FOR ANY OTHER PURPOSE WITHOUT THE WRITTEN CONSENT OF CROSSMAN ENGINEERING

PROJECT TITLE:

PROPOSED

PLAT MAP 319, LOTS 2, 4 & 502 ZONING DISTRICT **GENERAL BUSINESS 35 WEST SHORE ROAD** WARWICK, RHODE ISLAND

PREPARED FOR:

E&J WEST SHORE REALTY, LLC

75 TIPPING ROCK DRIVE EAST GREENWICH, RI 02818

DRAWING TITLE:


APRIL 2021

SITE LAYOUT PLAN

1"=20'

WG. NAME: 2416-07-SITE.dwg				
EVISIONS				
\triangle				
NUMBER	REMARKS	DATE		
1	PRELIMINARY PLAN	10/1/21		
2	RIDEM COMMENTS	12/1/21		
3	RIDOT COMMENTS	12/28/21		
4	RIDOT COMMENTS	2/14/22		
<u> </u>	·			

DRAWING NUMBER

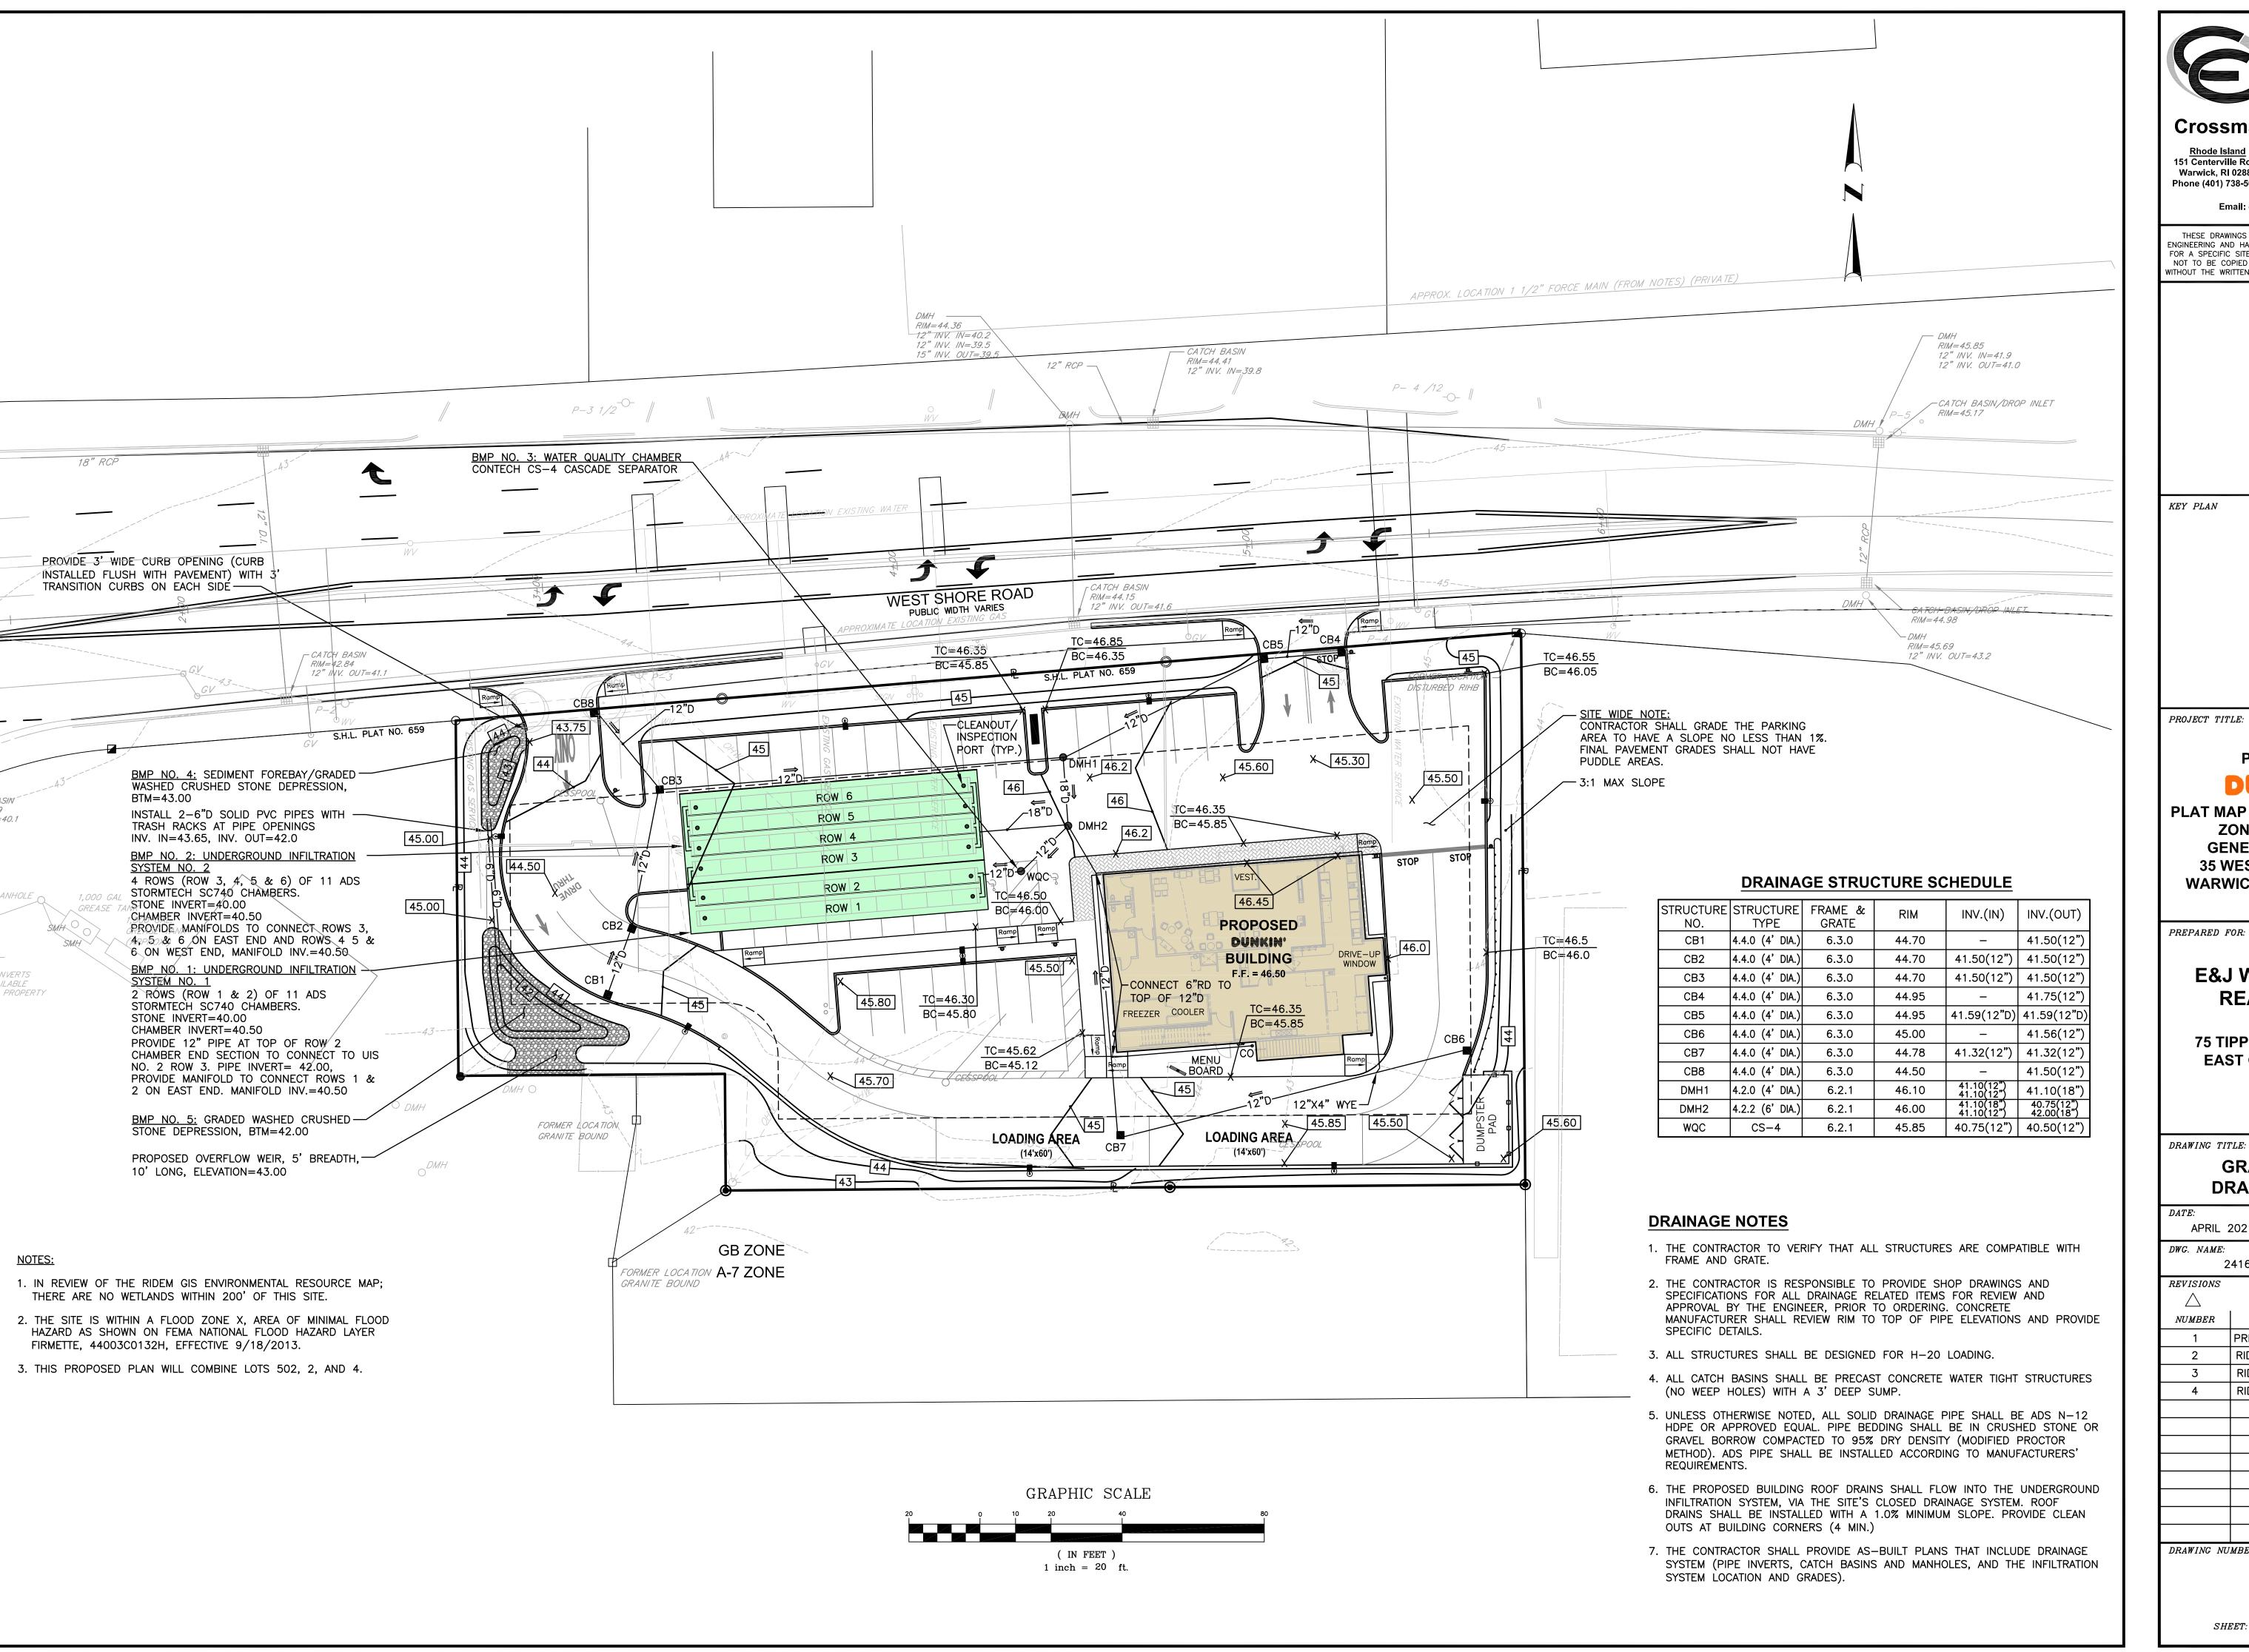



 Environmental Site Planning Surveying Permitting

Transportation

 Landscape Architectur **Crossman Engineering**

Civil

151 Centerville Road 103 Commonwealth Avenue Warwick, RI 02886 North Attleboro, MA 02763 Phone (401) 738-5660 Phone (508) 695-1700

Email: cei@crossmaneng.com

THESE DRAWINGS ARE THE PROPERTY OF CROSSMAN ENGINEERING AND HAVE BEEN PREPARED FOR THEIR CLIENT FOR A SPECIFIC SITE AND PROJECT. THESE DRAWINGS ARE NOT TO BE COPIED OR USED FOR ANY OTHER PURPOSE WITHOUT THE WRITTEN CONSENT OF CROSSMAN ENGINEERING

KEY PLAN

PROPOSED

PLAT MAP 319, LOTS 2, 4 & 502 ZONING DISTRICT **GENERAL BUSINESS 35 WEST SHORE ROAD** WARWICK, RHODE ISLAND

PREPARED FOR:

E&J WEST SHORE REALTY, LLC

75 TIPPING ROCK DRIVE EAST GREENWICH, RI 02818

DRAWING TITLE:

GRADING AND DRAINAGE PLAN

APRIL 2021 1"=20' DWG. NAME:


2416-08-GRADE.dwg

REVISIONS

NUMBER	REMARKS	DATE
1	PRELIMINARY PLAN	10/1/21
2	RIDEM COMMENTS	12/1/21
3	RIDOT COMMENTS	12/28/21
4	RIDOT COMMENTS	2/14/22

DRAWING NUMBER

SHEET: 8 OF: 18

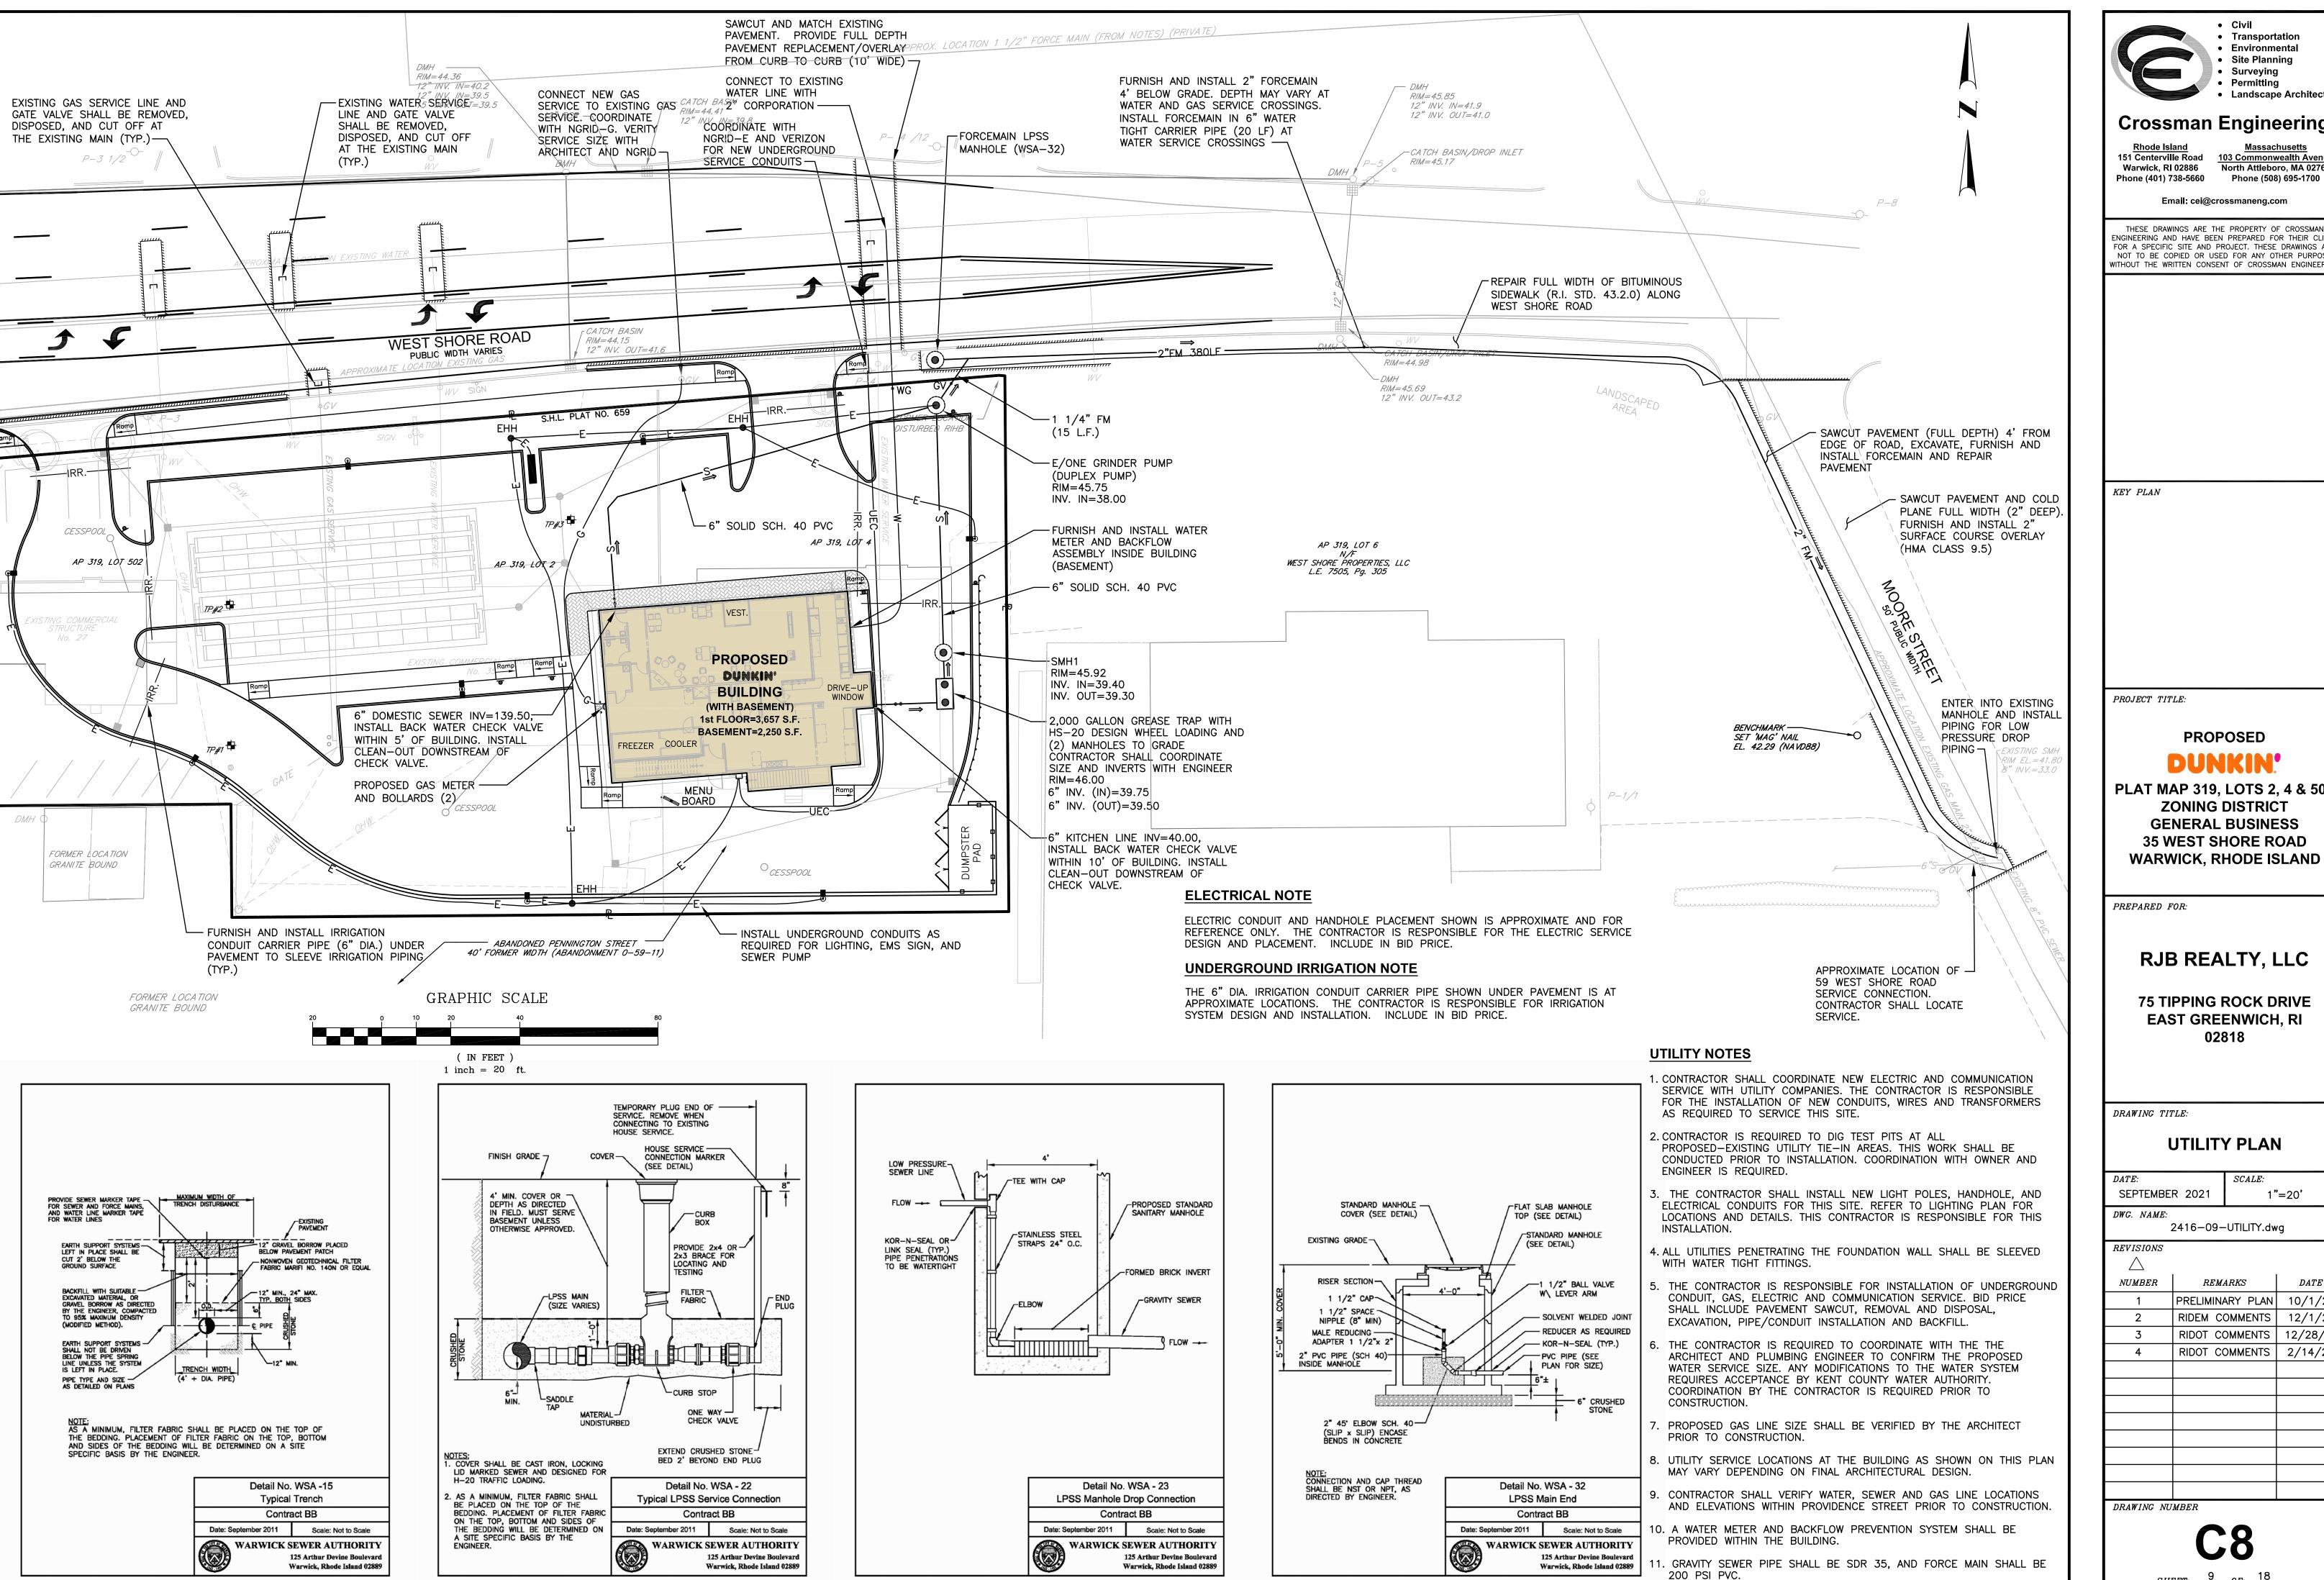



 Environmental Site Planning Surveying Permitting

 Landscape Architectur **Crossman Engineering**

151 Centerville Road 103 Commonwealth Avenue

Warwick, RI 02886 North Attleboro, MA 02763

Email: cei@crossmaneng.com

THESE DRAWINGS ARE THE PROPERTY OF CROSSMAN ENGINEERING AND HAVE BEEN PREPARED FOR THEIR CLIFNT

FOR A SPECIFIC SITE AND PROJECT. THESE DRAWINGS ARE NOT TO BE COPIED OR USED FOR ANY OTHER PURPOSE WITHOUT THE WRITTEN CONSENT OF CROSSMAN ENGINEERING

KEY PLAN

PROJECT TITLE:

PROPOSED

PLAT MAP 319, LOTS 2, 4 & 502 ZONING DISTRICT **GENERAL BUSINESS** 35 WEST SHORE ROAD WARWICK, RHODE ISLAND

PREPARED FOR:

RJB REALTY, LLC

75 TIPPING ROCK DRIVE EAST GREENWICH, RI 02818

DRAWING TITLE:

UTILITY PLAN


SEPTEMBER 2021 1"=20' DWG. NAME: 2416-09-UTILITY.dwg

REVISIONS	
\triangle	
NUMBER	

NUMBER	REMARNS	DAIL
1	PRELIMINARY PLAN	10/1/21
2	RIDEM COMMENTS	12/1/21
3	RIDOT COMMENTS	12/28/21
4	RIDOT COMMENTS	2/14/22
_		

DRAWING NUMBER

SHEET: 9 OF: 18

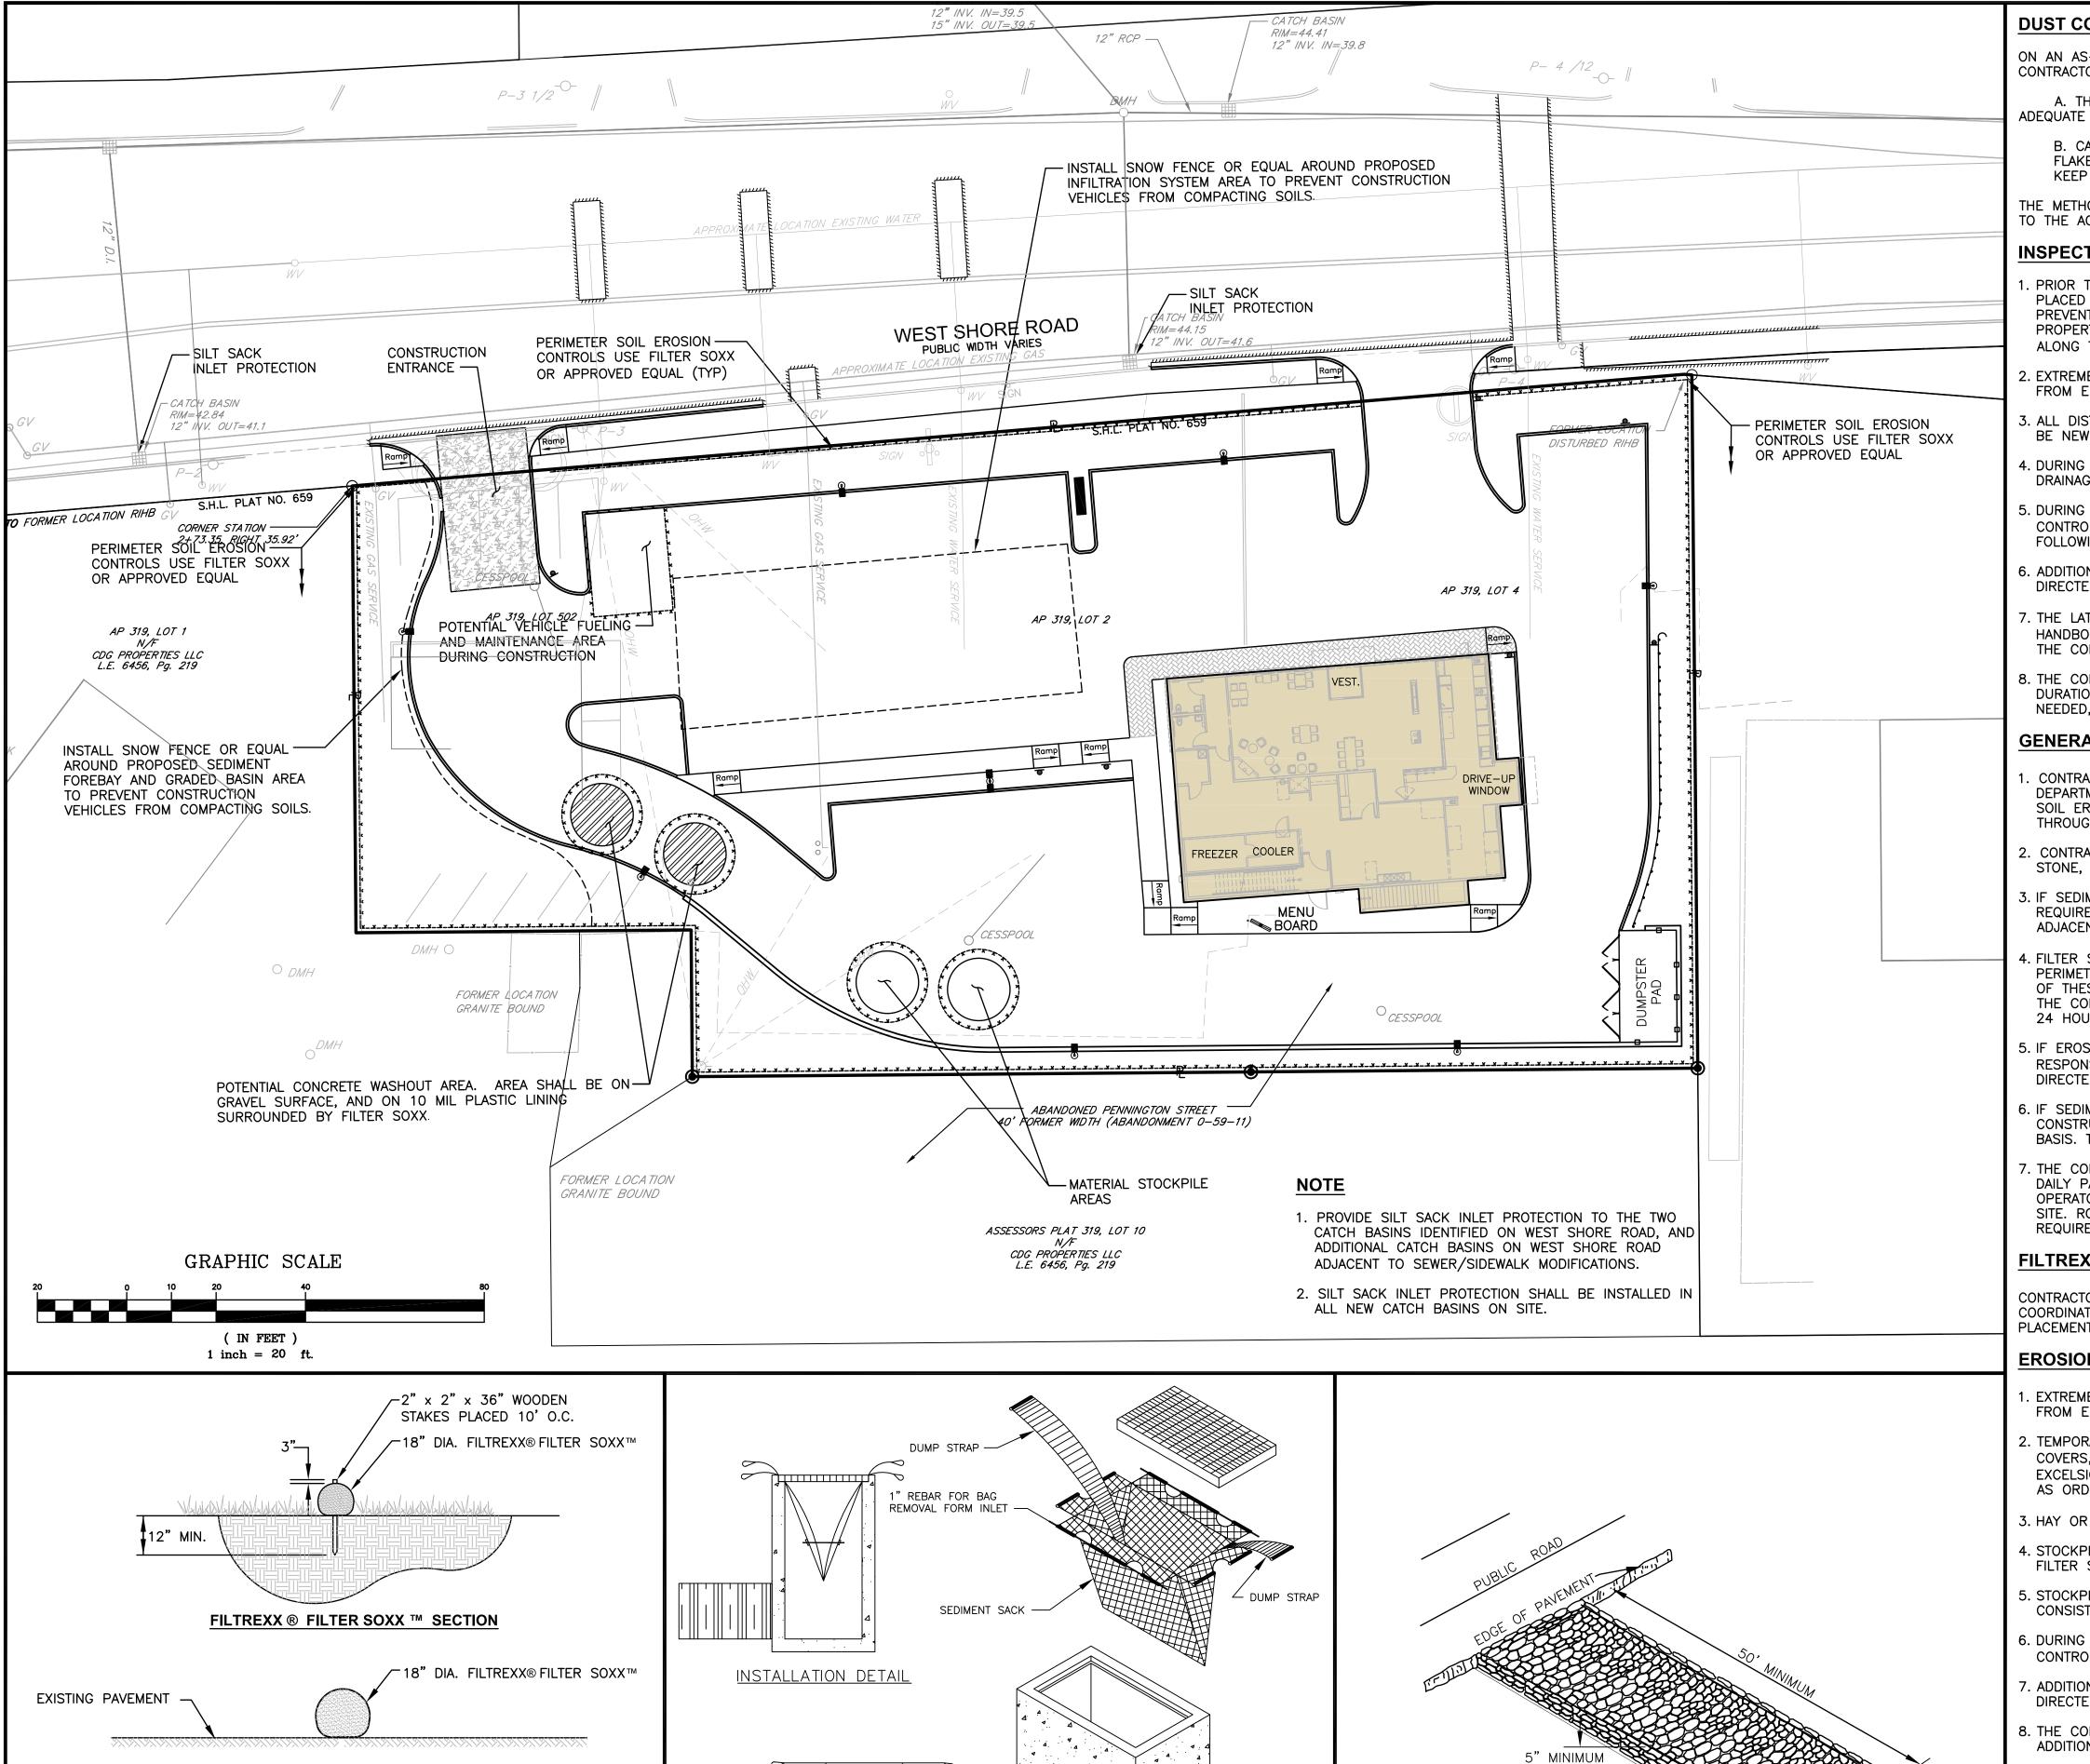

FILTREXX ® FILTER SOXX ™ PAVEMENT OPTION

2. CONTRACTOR IS RESPONSIBLE TO BECOME FAMILIAR WITH THE FILTREXX PRODUCTS

4. COMPOST MATERIAL TO BE DISPERSED ON SITE AS DETERMINED BY ENGINEER.

AND COORDINATE INSTALLATION SCHEDULES AND METHODS WITH THE ENGINEER PRIOR

FILTREXX® FILTER SOXX ™ DETAIL

NOT TO SCALE

1. FILTREXX FILTER SOXX MAY BE USED IN LIEU OF SILT FENCE.

3. ALL MATERIAL SHALL MEET FILTREXX SPECIFICATIONS.

NOTE

TO PLACEMENT.

EXPANSION RESTRAINT (1/4" NYLON ROPE,

2" FLAT WASHERS)

2 EACH

1. INSTALL SILT SACK AT CATCH BASINS IN VICINITY OF CONSTRUCTION.

2. CONTRACTOR SHALL SUBMIT SILT SACK PRODUCT TO ENGINEER FOR APPROVAL.

TYPICAL SILT SACK DETAIL

NOT TO SCALE

BAG DETAIL

DUST CONTROL NOTES

ON AN AS-NEEDED BASIS OR AS DIRECTED BY THE CITY, RIDEM OR OWNER, THE CONTRACTOR SHALL UTILIZE ONE OF THE FOLLOWING METHODS TO CONTROL DUST:

A. THE EXPOSED SOIL SURFACE SHOULD BE MOISTENED PERIODICALLY WITH ADEQUATE WATER TO CONTROL DUST.

B. CALCIUM CHLORIDE SHOULD BE EITHER LOOSE DRY GRANULES OR FLAKE FINE ENOUGH TO FEED THROUGH A SPREADER AT A RATE THAT WILL KEEP SURFACE MOIST BUT NOT CAUSE POLLUTION OR PLANT DAMAGE.

THE METHODS SHOULD BE REPEATED AS NEEDED, AND SPECIAL ATTENTION MUST BE GIVEN TO THE ACCESS DRIVES.

INSPECTION/MAINTENANCE NOTES

- . PRIOR TO COMMENCING GRUBBING OPERATIONS AND EARTHWORK, FILTERSOXX SHALL BE PLACED INSIDE SAWCUT EDGE AND ALONG THE DOWNGRADIENT LIMIT OF DISTURBANCE TO PREVENT SEDIMENT FROM ENTERING EXISTING ROADWAY DRAINAGE SYSTEM, AND ABUTTING PROPERTIES AND THE CONTRACTOR SHALL INSTALL DRIPLINE TREE PROTECTION DEVICES ALONG THE PROPOSED TREELINE/EXISTING TREES TO REMAIN.
- 2. EXTREME CARE SHALL BE EXERCISED SO AS TO PREVENT ANY UNSUITABLE MATERIAL FROM ENTERING THE DRAINAGE SYSTEM.
- 3. ALL DISTURBED AREAS WHICH BECOME SUBJECT TO EROSIVE TENDENCIES WHETHER THEY BE NEWLY FILLED OR EXCAVATED SHALL RECEIVE SLOPE PROTECTION - SUCH AS RIP-RAP.
- 4. DURING CONSTRUCTION, THE CONTRACTOR SHALL BE RESPONSIBLE FOR MAINTAINING DRAINAGE AND RUNOFF FLOW DURING PERIODS OF RAINFALL.
- 5. DURING CONSTRUCTION, THE CONTRACTOR SHALL BE RESPONSIBLE FOR ALL EROSION CONTROL MAINTENANCE AND SHALL INSPECT / REPLACE DAILY DURING CONSTRUCTION, FOLLOWING RAINFALL AND WEEKLY DURING NON CONSTRUCTION PERIODS.
- 6. ADDITIONAL FILTERSOXX OR SANDBAGS SHALL BE LOCATED AS CONDITIONS WARRANT OR AS DIRECTED BY THE ENGINEER.
- 7. THE LATEST VERSION OF THE "RHODE ISLAND SOIL EROSION AND SEDIMENT CONTROL HANDBOOK" PREPARED BY THE R.I. STATE CONSERVATION COMMITTEE, MUST BE UTILIZED BY THE CONTRACTOR AS A GUIDE.
- 8. THE CONTRACTOR IS RESPONSIBLE FOR ALL DUST CONTROL AND FOR THE ENTIRE PROJECT DURATION, INCLUDING TEMPORARY SHUT-DOWN PERIODS, MUST MONITOR AND REPAIR, AS NEEDED, ALL SLOPES TO ENSURE A STABLE PRODUCT.

GENERAL PROJECT WIDE NOTES

- CONTRACTOR SHALL OBTAIN A SOIL EROSION AND SEDIMENT CONTROL PERMIT FROM THE DEPARTMENT OF PUBLIC WORKS PRIOR TO THE COMMENCEMENT OF ANY WORK ONSITE; SOIL EROSION AND SEDIMENT CONTROL MEASURES MUST BE PROPERLY MAINTAINED THROUGHOUT CONSTRUCTION.
- 2. CONTRACTOR SHALL INSTALL TEMPORARY MEASURES SUCH AS; FIBER MATTING, CRUSHED STONE, HAY OR STRAW IN AREAS WHERE SLOPES OR STABILIZATION HAS FAILED.
- 3. IF SEDIMENT IS TRACKED OR ERODED INTO THE ROADWAY, THE CONTRACTOR WILL BE REQUIRED TO SWEEP DAILY AND TO INSTALL SILT SACK OR APPROVED EQUAL UNDER ADJACENT EXISTING CATCH BASIN GRATES. REMOVE AFTER CONSTRUCTION.
- 4. FILTER SOXX (OR SILT FENCE OR STAKED HAYBALES) SHALL BE INSTALLED AROUND THE PERIMETER OF THE AREA TO BE DISTURBED BY CONSTRUCTION. ADDITIONAL APPLICATIONS OF THESE CONTROLS MEASURES MAY BE REQUIRED DURING THE CONSTRUCTION PROCESS THE CONTRACTOR SHALL INSPECT THE SITE AT A MINIMUM OF ONCE PER WEEK OR WITHIN 24 HOURS AFTER A STORM EVENT.
- 5. IF EROSION OR EROSIVE TENDENCIES ARE APPARENT ON THE SITE, THE CONTRACTOR IS RESPONSIBLE TO INSTALL ADDITIONAL CONSTRUCTION BMP'S SUCH AS SAND BAGS AS DIRECTED BY THE CITY OR ENGINEER DURING CONSTRUCTION.
- 6. IF SEDIMENT OR DEBRIS IS TRACKED ONTO EXISTING PAVED AREAS ADJACENT TO THE CONSTRUCTION AREA, THE CONTRACTOR IS REQUIRED TO SWEEP THE PAVEMENT ON A DAILY BASIS. THE AREA SHALL BE INSPECTED DAILY.
- . THE CONTRACTOR IS RESPONSIBLE TO KEEP THE SITE CLEAN OF TRASH. RECOMMENDED DAILY PATROL OF THE CONSTRUCTION SHOULD BE CONDUCTED TO PICK-UP TRASH. THE OPERATOR SHALL REQUIRE THE CONTRACTOR TO HAVE PORTABLE SANITARY FACILITIES ON SITE. ROUTINE CLEANING AND WASTE DISPOSAL OF THESE PORTABLE SANITARY FACILITIES IS

FILTREXX SOXX NOTE

R.I.D.O.T.

FILTER FABRI

CONSTRUCTION ENTRANCE DETAIL

NOT TO SCALE

CONTRACTOR IS RESPONSIBLE TO BECOME FAMILIAR WITH THE FILTREXX PRODUCTS AND COORDINATE INSTALLATION SCHEDULES AND METHODS WITH THE ENGINEER PRIOR TO

EROSION CONTROL AND SOIL STABILIZATION PROGRAM

- . EXTREME CARE SHALL BE EXERCISED SO AS TO PREVENT ANY UNSUITABLE MATERIAL FROM ENTERING THE DRAINAGE SYSTEM, ADJACENT PROPERTY, AND ROADWAYS.
- 2. TEMPORARY TREATMENTS SHALL CONSIST OF A HAY, STRAW, OR FIBER MULCH PROTECTIVE COVERS, SUCH AS A MAT OR FIBER LINING (BURLAP, JUTE, FIBERGLASS NETTING, EXCELSIOR BLANKETS). THEY SHALL BE INCORPORATED INTO THE WORK AS WARRANTED OR AS ORDERED BY THE OWNER.
- 3. HAY OR STRAW APPLICATIONS SHALL BE IN THE AMOUNT OF 3,000-4,000 LBS/ACRE.
- 4. STOCKPILES SHALL HAVE NO SLOPE STEEPER THAN 2:1 AND SHALL BE SURROUNDED BY FILTER SOXX, STAKED HAY BALES OR SILT FENCING.
- 5. STOCKPILES EXPOSED FOR EXCESSIVE PERIODS SHALL RECEIVE TEMPORARY TREATMENT CONSISTING OF HAY, STRAW OR FIBER MATTING.
- 6. DURING CONSTRUCTION, THE CONTRACTOR SHALL BE RESPONSIBLE FOR ALL EROSION CONTROL MAINTENANCE AND SHALL INSPECT/REPLACE AS NEEDED.
- ADDITIONAL HAY BALES OR SANDBAGS SHALL BE LOCATED AS CONDITIONS WARRANT OR AS DIRECTED BY THE ENGINEER, OWNER, MUNICIPAL REPRESENTATIVES OR LOCAL D.O.T.
- 8. THE CONTRACTOR SHALL BE RESPONSIBLE FOR PROVIDING DUST CONTROL AT NO ADDITIONAL COST TO THE OWNER.
- 9. ALL CATCH BASINS ADJACENT TO THE CONSTRUCTION AREA SHALL BE PROTECTED BY SILT
- 10. ALL PROPOSED CATCH BASINS SHALL BE PROTECTED BY STAKED HAY BALES, SILT FENCING OR SILT SACKS.
- 11. THE FILTREXX FILTER SOXX MAY BE INSTALLED ON THE EXISTING PAVEMENT /IMPERVIOUS AREAS WITH OUT STAKES. CONTRACTOR SHALL INSPECT DAILY, IF SOIL EROSION OR SEDIMENT IS OBSERVED IN THESE AREAS, THE CONTRACTOR SHALL RELOCATE OR INSTALL ADDITIONAL FILTREXX FILTER SOXX IN LOCATIONS THAT CAN BE STAKED. THIS WORK IS INCLUDED IN THE PROJECT SCOPE.
- 12. SILT FENCE OR STAKED HAYBALES MAY BE USED IN LIEU OF FILTREXX FILTER SOXX.
- 13. AN ALTERNATE COMPOST SOCK OR STRAW WATTLE PRODUCT MAY BE USED IN LIEU OF FILTREXX FILTER SOCK UPON APPROVAL OF THE ENGINEER.



Landscape Architectur **Crossman Engineering**

Civil

Environmental

Site Planning

 Surveying Permitting

103 Commonwealth Avenue 151 Centerville Road Warwick, RI 02886 North Attleboro, MA 02763 Phone (401) 738-5660 Phone (508) 695-1700

Email: cei@crossmaneng.com

THESE DRAWINGS ARE THE PROPERTY OF CROSSMAN ENGINEERING AND HAVE BEEN PREPARED FOR THEIR CLIENT FOR A SPECIFIC SITE AND PROJECT. THESE DRAWINGS AR NOT TO BE COPIED OR USED FOR ANY OTHER PURPOSE WITHOUT THE WRITTEN CONSENT OF CROSSMAN ENGINEERIN

KEY PLAN

PROJECT TITLE:

PROPOSED

PLAT MAP 319, LOTS 2, 4 & 502 ZONING DISTRICT **GENERAL BUSINESS**

35 WEST SHORE ROAD

WARWICK, RHODE ISLAND

PREPARED FOR:

E&J WEST SHORE REALTY, LLC

75 TIPPING ROCK DRIVE EAST GREENWICH, RI 02818

DRAWING TITLE:

SOIL EROSION and SEDIMENT CONTROL PLAN


APRIL 2021 1"=20'


DWG. NAME: 2416-10-SOIL.dwg


REVISIONS


NUMBERREMARKSDATE|PRELIMINARY PLAN| 10/1/21 RIDEM COMMENTS | 12/1/21 RIDOT COMMENTS | 12/28/2 RIDOT COMMENTS | 2/14/22

DRAWING NUMBER

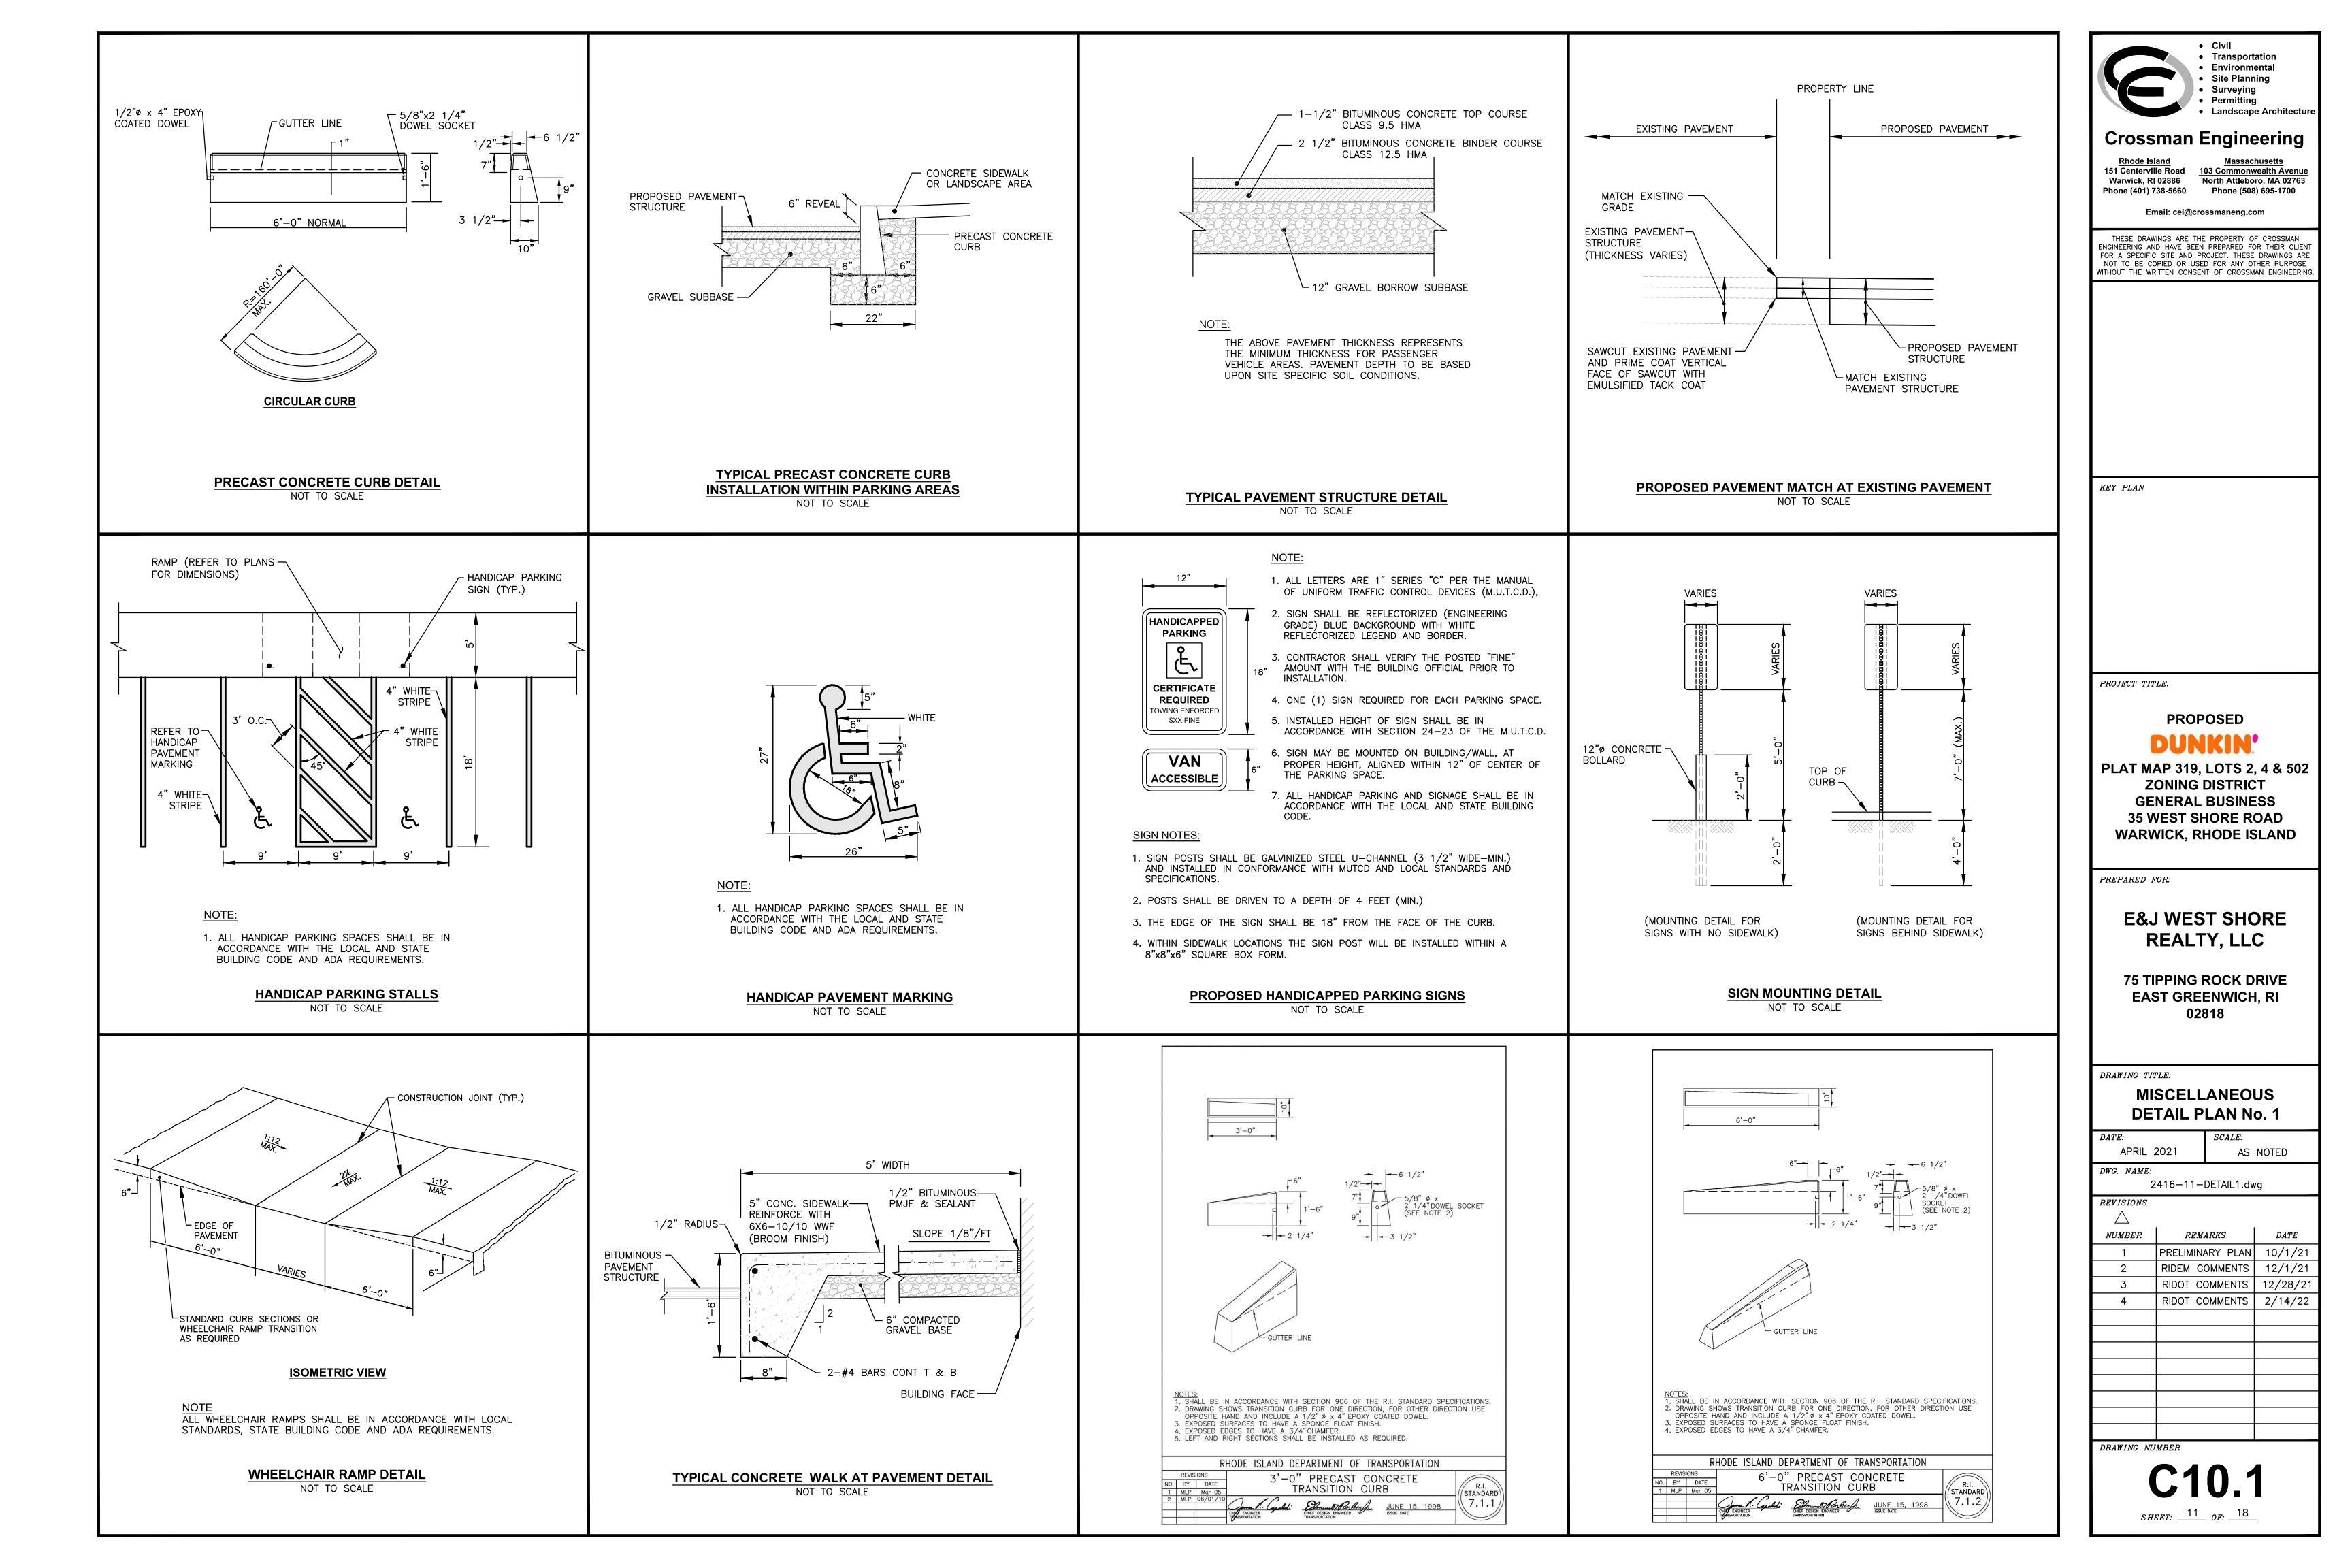

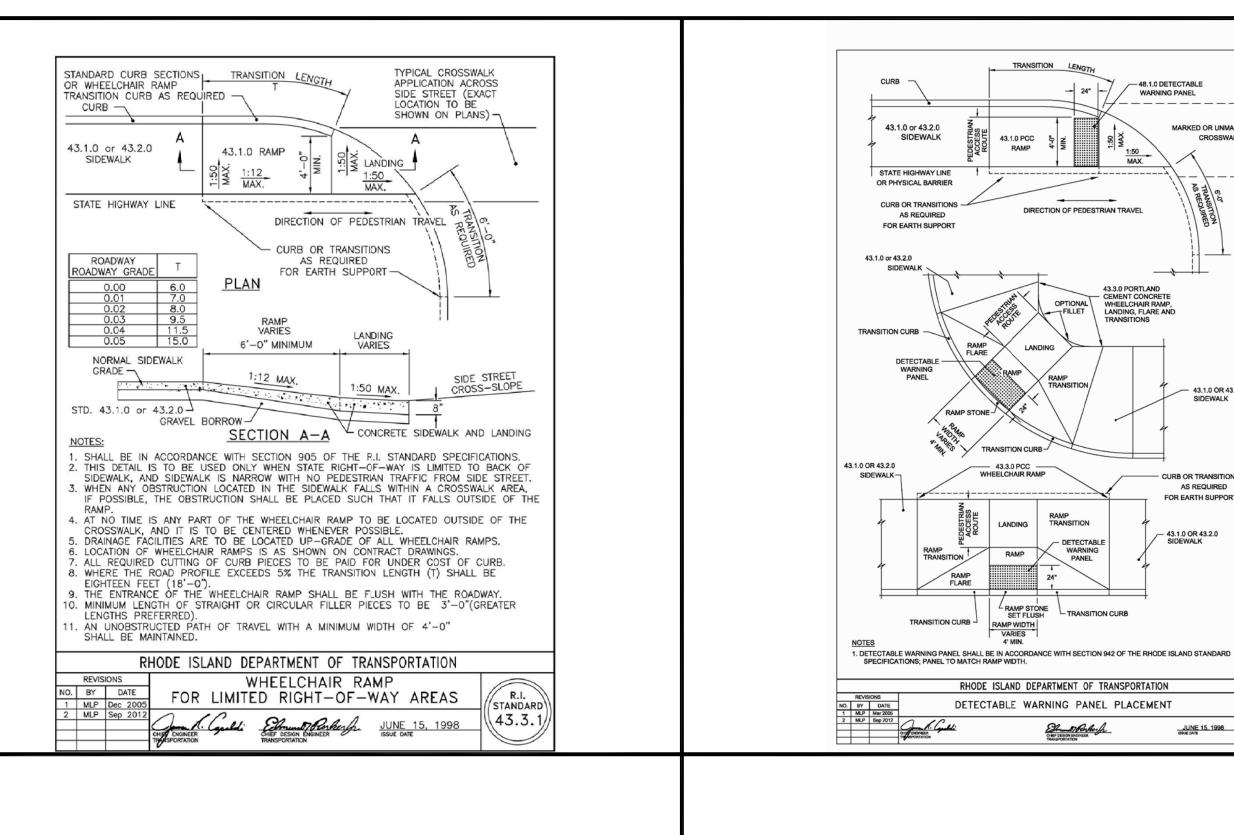


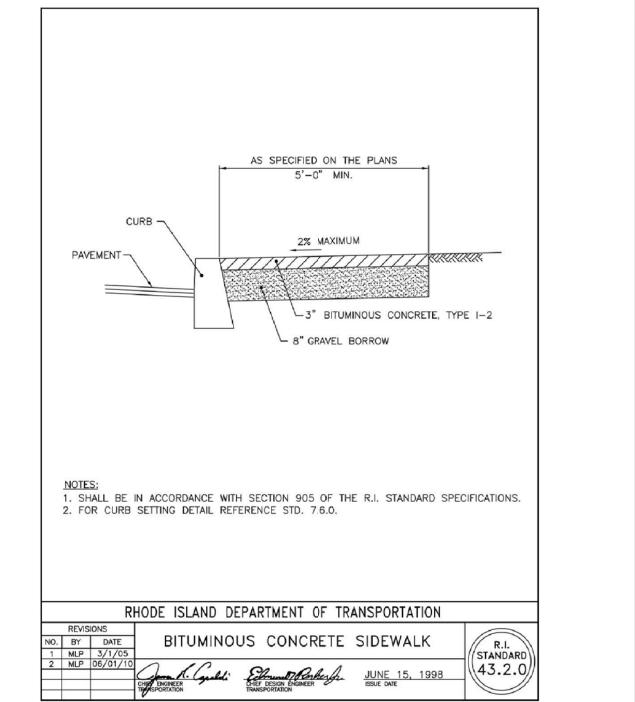

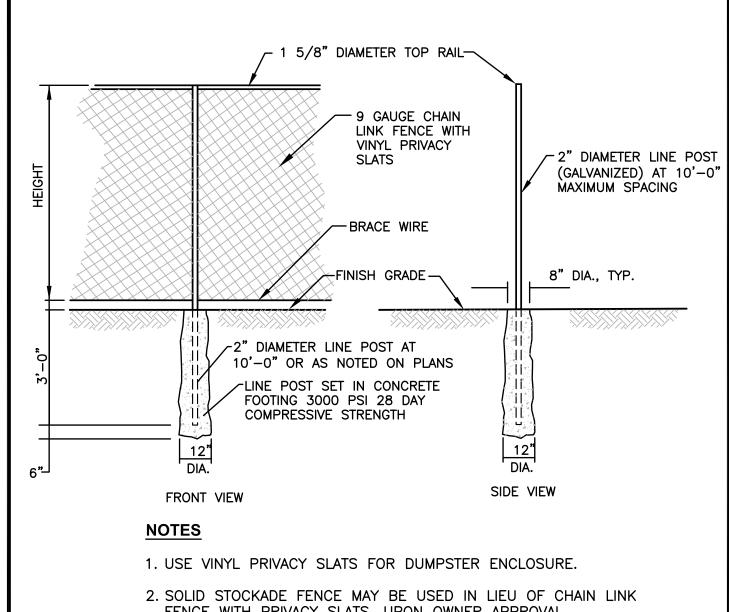



FENCE WITH PRIVACY SLATS, UPON OWNER APPROVAL.

CHAIN LINK FENCE DETAIL NOT TO SCALE

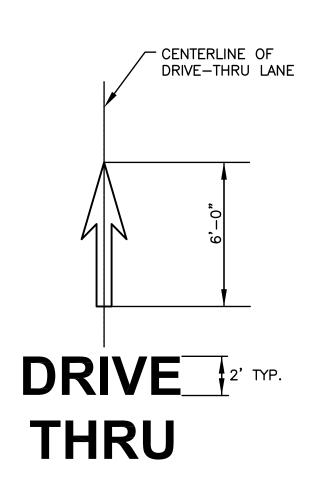

DRIVE THRU ARROW DETAIL NOT TO SCALE

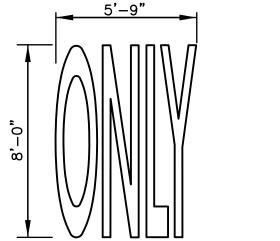

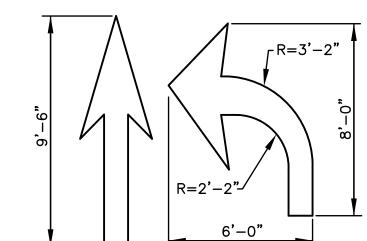

MARKED OR UNMARKED


CURB OR TRANSITIONS AS REQUIRED

JUNE 15, 1998 48.1.0)


NOTES

- 1. THE LONGITUDINAL SPACE BETWEEN LINES OR SYMBOL MESSAGES, INCLUDING ARROWS, SHOULD BE AT LEAST FOUR TIMES THE HEIGHT OF THE CHARACTER FOR LOW SPEED ROADS BUT NOT MORE THAN TEN TIMES THE HEIGHT OF THE CHARACTER UNDER ANY CONDITIONS.
- 2. THE SPACING OF THE PAVEMENT MARKINGS WILL BE AS SHOWN ON THE PLAN AND AS PER THE MUTCD.
- 3. SYMBOLS AND WORDS SHALL MEET THE REQUIREMENTS OF THE FHWA "STANDARD ALPHABET AND SYMBOLS FOR HIGHWAY PAVEMENT

PAVEMENT MARKINGS DETAIL NOT TO SCALE

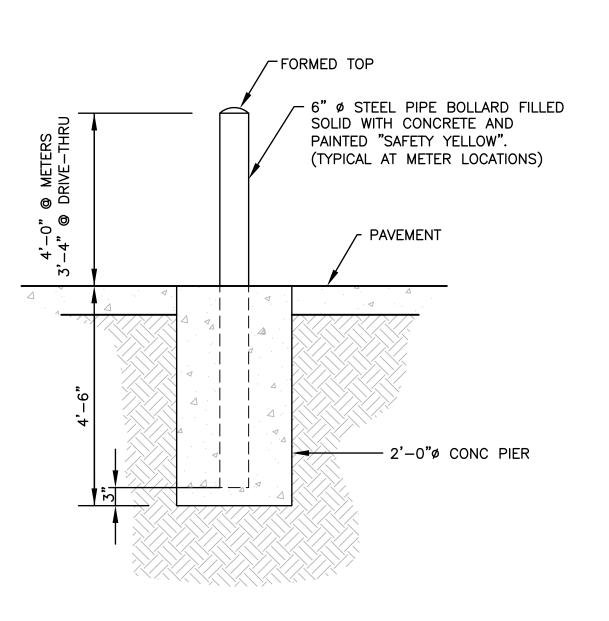



TYPICAL BOLLARD DETAIL NOT TO SCALE

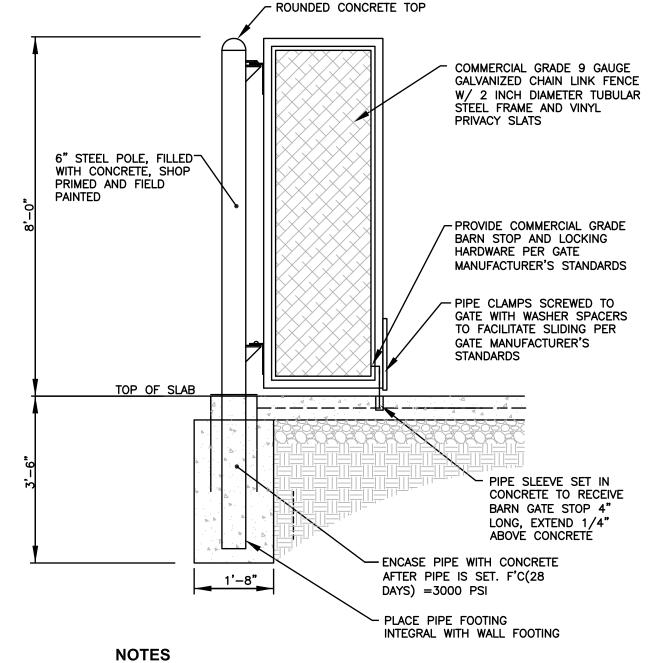



- 1. USE VINYL PRIVACY SLATS FOR DUMPSTER ENCLOSURE.
- 2. SOLID STOCKADE FENCE MAY BE USED IN LIEU OF CHAIN LINK FENCE WITH PRIVACY SLATS, UPON OWNER APPROVAL.


DUMPSTER ENCLOSURE GATE-PARTIAL SECTION NOT TO SCALE

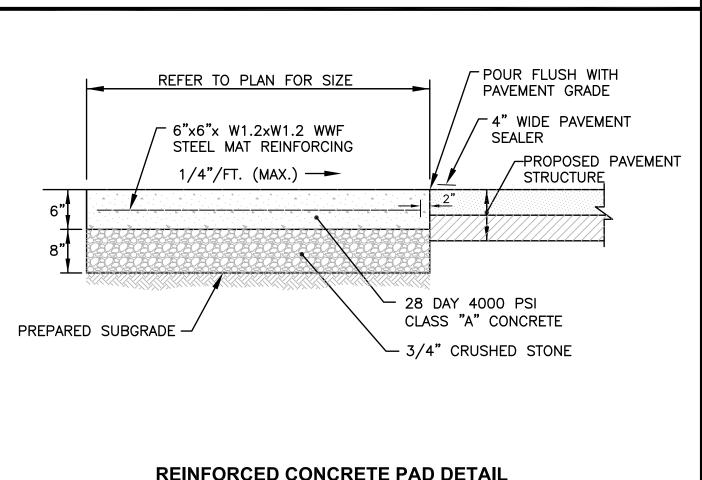


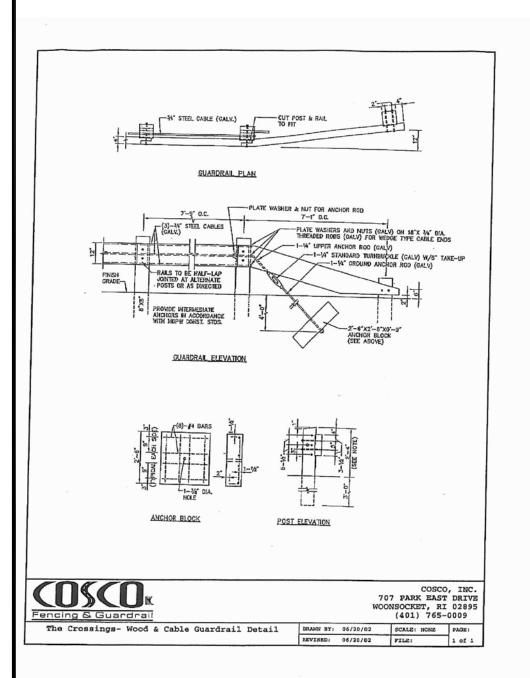

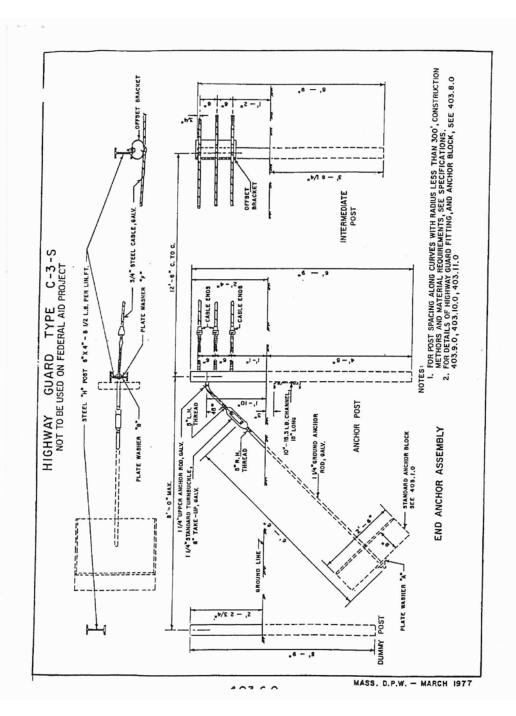

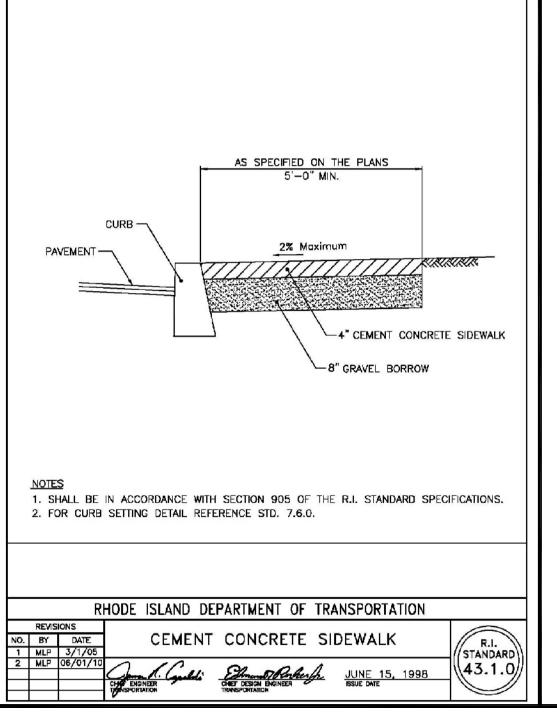

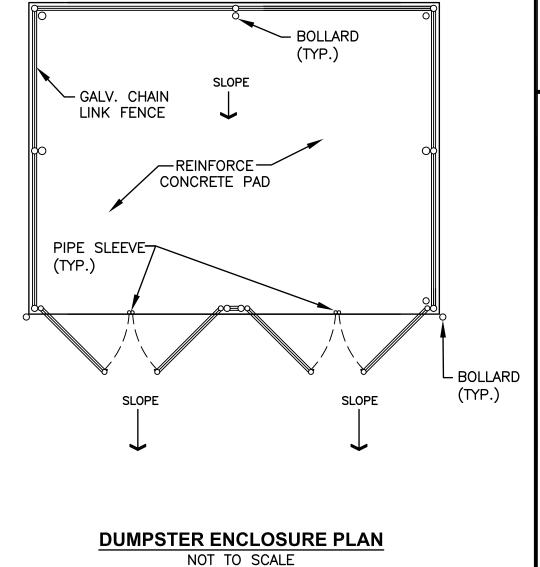

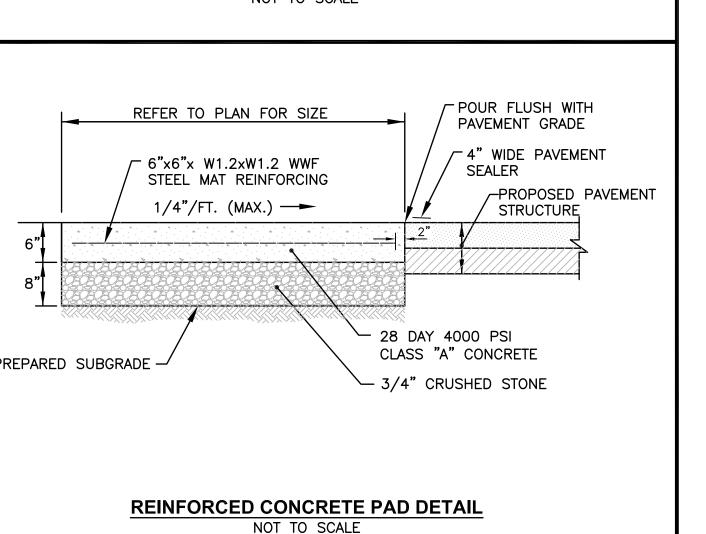

Civil Transportation Environmental Site Planning

 Surveying Permitting Landscape Architectur

Crossman Engineering

151 Centerville Road 103 Commonwealth Avenue Warwick, RI 02886 North Attleboro, MA 02763 Phone (401) 738-5660 Phone (508) 695-1700

Email: cei@crossmaneng.com

THESE DRAWINGS ARE THE PROPERTY OF CROSSMAN ENGINEERING AND HAVE BEEN PREPARED FOR THEIR CLIENT FOR A SPECIFIC SITE AND PROJECT. THESE DRAWINGS ARE NOT TO BE COPIED OR USED FOR ANY OTHER PURPOSE WITHOUT THE WRITTEN CONSENT OF CROSSMAN ENGINEERING

KEY PLAN

PROJECT TITLE:

PROPOSED

PLAT MAP 319, LOTS 2, 4 & 502 ZONING DISTRICT **GENERAL BUSINESS 35 WEST SHORE ROAD WARWICK, RHODE ISLAND**

PREPARED FOR:

E&J WEST SHORE REALTY, LLC

75 TIPPING ROCK DRIVE EAST GREENWICH, RI 02818


DRAWING TITLE: **MISCELLANEOUS DETAIL PLAN No. 2**

SCALE:

APRIL 2021		AS	NOTED		
WG. NAME: 2	<i>TG. NAME:</i> 2416—12—DETAIL2.dwg				
EVISIONS					
NUMBER	REMA	ARKS	DATE		
1	PRELIMINA	ARY PLAN	10/1/21		
2	RIDEM C	OMMENTS	12/1/21		
3	RIDOT CO	OMMENTS	12/28/21		
4	RIDOT CO	OMMENTS	2/14/22		

SHEET: 12 OF: 18

DRAWING NUMBER

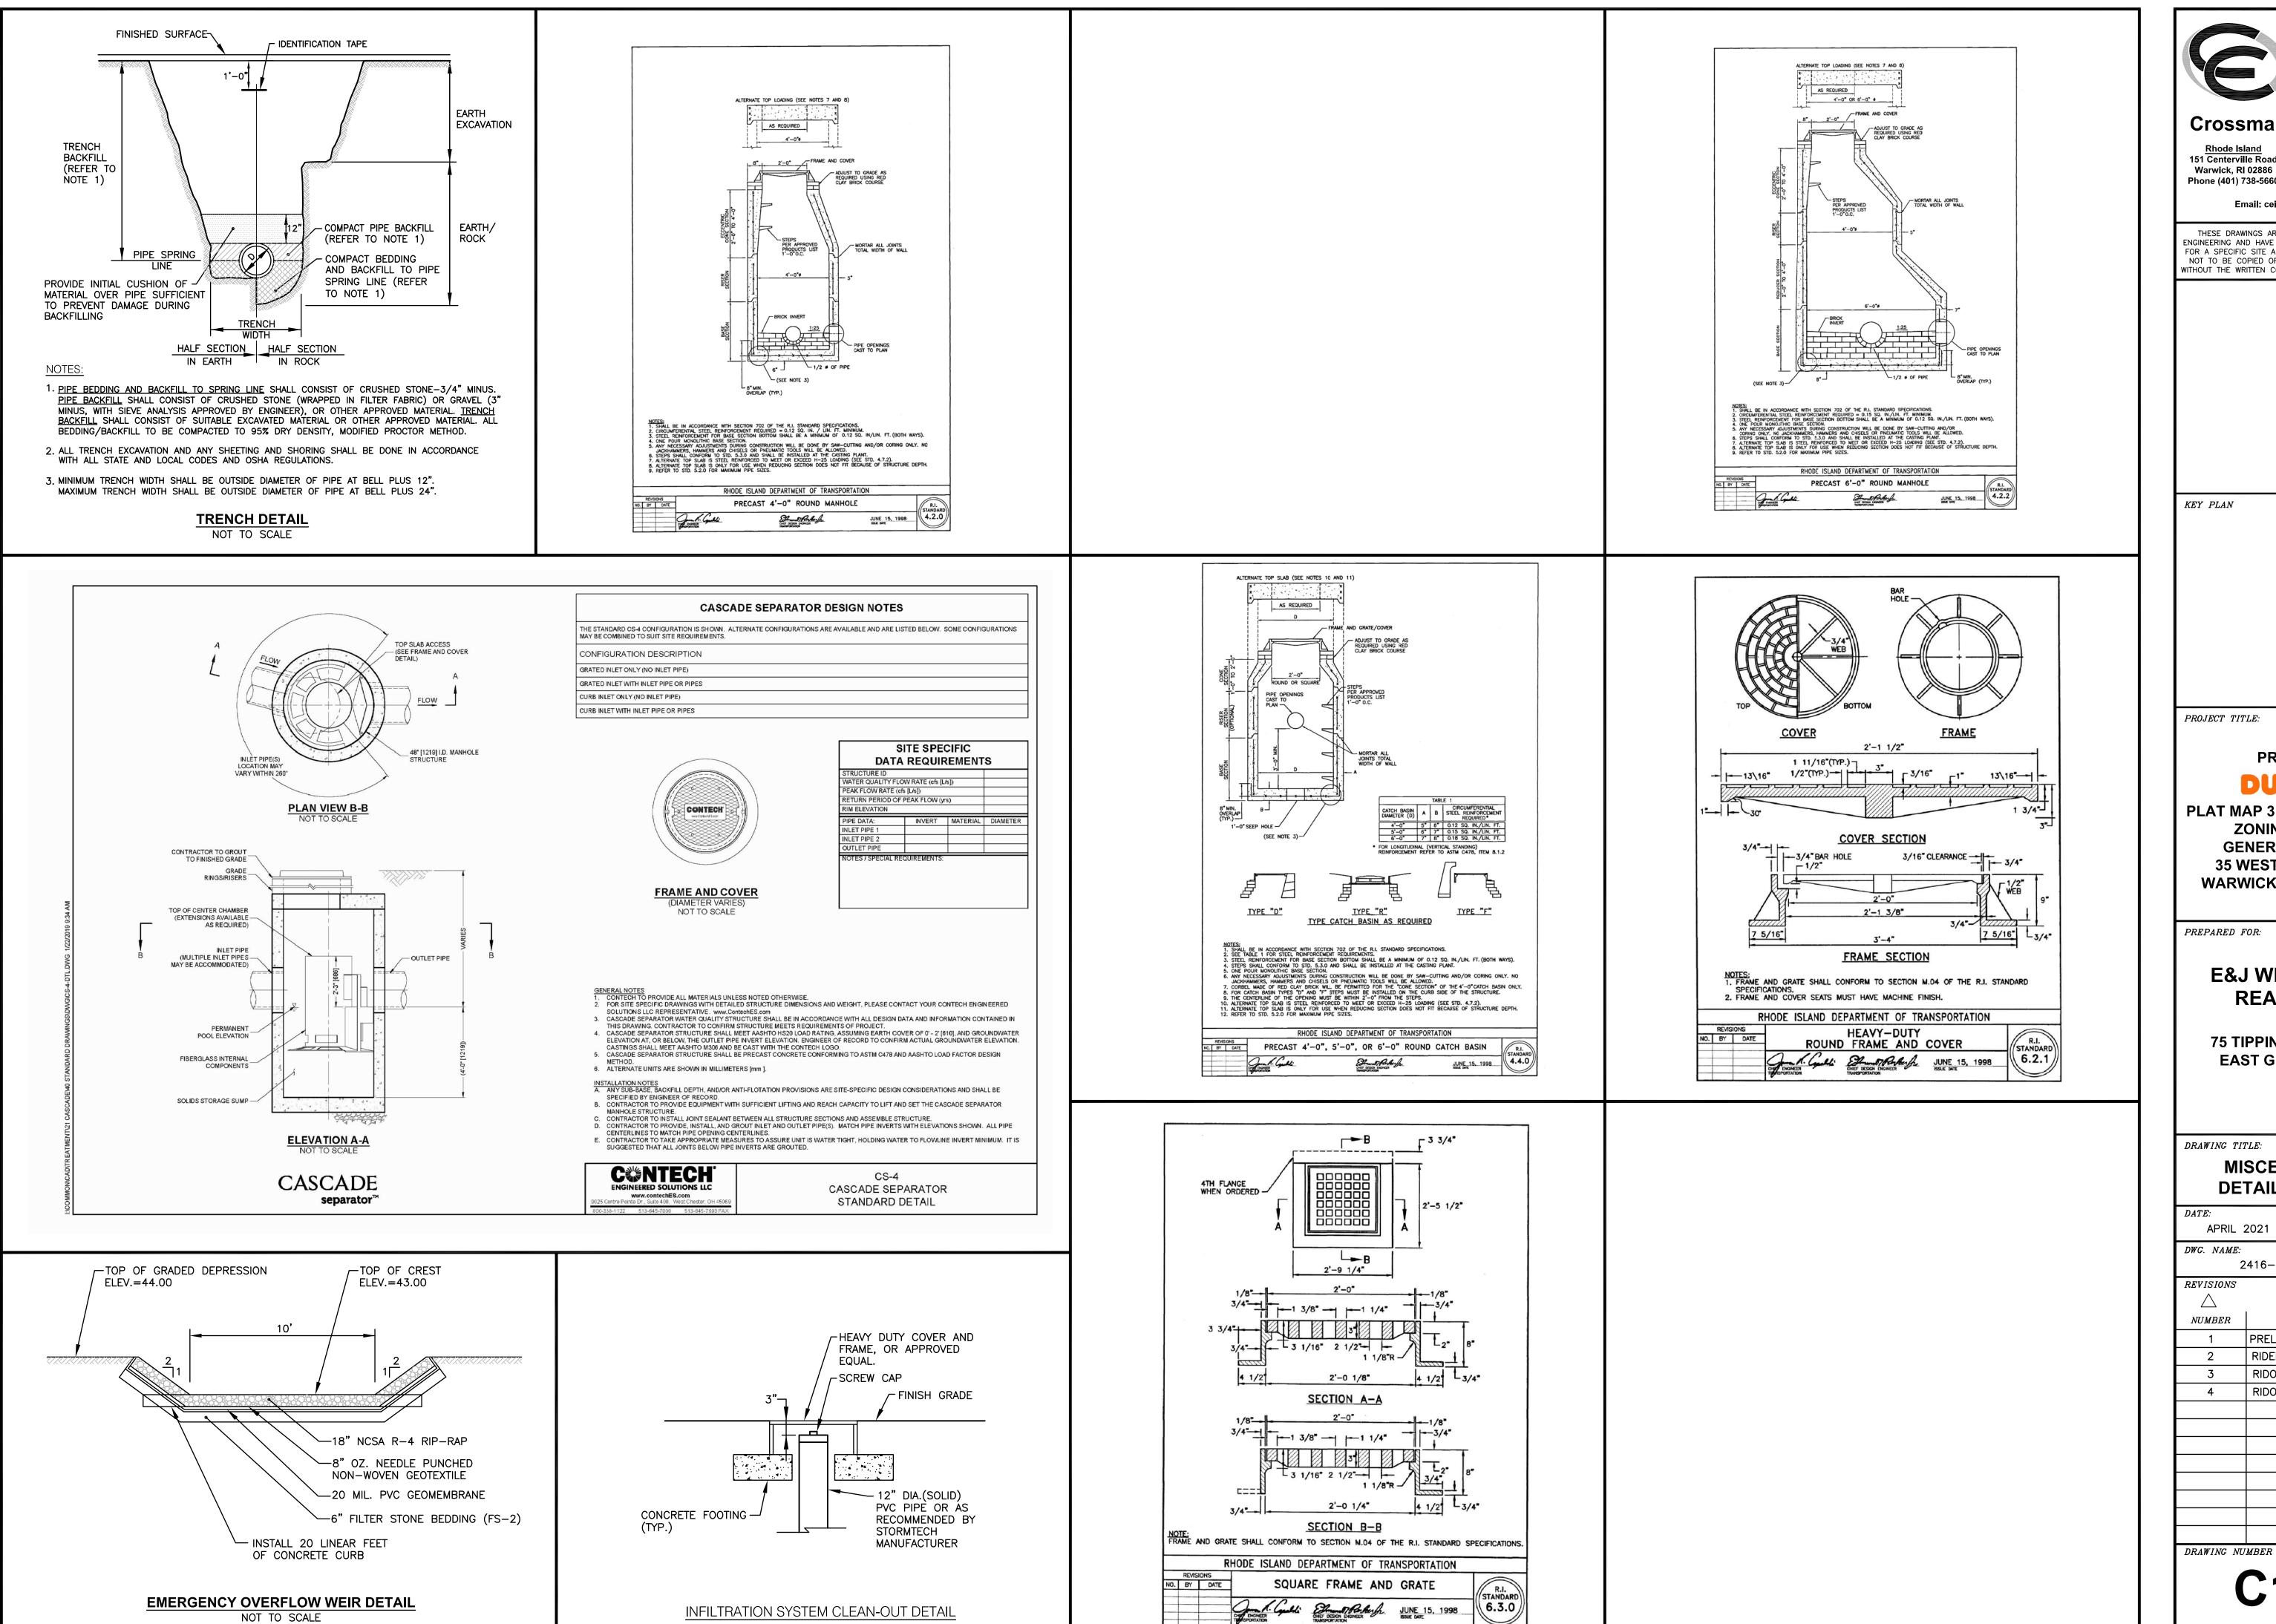

NOT TO SCALE

Civil Transportation Environmental Site Planning Surveying Permitting

 Landscape Architectur Crossman Engineering

151 Centerville Road 103 Commonwealth Avenue Warwick, RI 02886 North Attleboro, MA 02763 Phone (401) 738-5660 Phone (508) 695-1700

Email: cei@crossmaneng.com

THESE DRAWINGS ARE THE PROPERTY OF CROSSMAN ENGINEERING AND HAVE BEEN PREPARED FOR THEIR CLIENT FOR A SPECIFIC SITE AND PROJECT. THESE DRAWINGS ARE NOT TO BE COPIED OR USED FOR ANY OTHER PURPOSE WITHOUT THE WRITTEN CONSENT OF CROSSMAN ENGINEERING

KEY PLAN

PROJECT TITLE:

PROPOSED

PLAT MAP 319, LOTS 2, 4 & 502 ZONING DISTRICT **GENERAL BUSINESS 35 WEST SHORE ROAD WARWICK, RHODE ISLAND**

PREPARED FOR:

E&J WEST SHORE REALTY, LLC

75 TIPPING ROCK DRIVE EAST GREENWICH, RI 02818

DRAWING TITLE:

MISCELLANEOUS DETAIL PLAN No. 3


APRIL 2021		AS	NOTED		
WG. NAME: 2	VG. NAME: 2416—13—DETAIL3.dwg				
EVISIONS					
NUMBER	REM	4 <i>RK</i> S	DATE		
1	PRELIMINA	ARY PLAN	10/1/21		
2	RIDEM COMMENTS		12/1/21		
3	RIDOT COMMENTS		12/28/21		
4	RIDOT CO	OMMENTS	2/14/22		


GENERAL SEWER NOTES


- 1. INSTALLATION OF THE SEWERAGE FACILITIES SHALL BE IN ACCORDANCE WITH THE WARWICK SEWER AUTHORITY SPECIFICATIONS AND REQUIREMENTS.
- 2. PRIOR TO RECEIVING AUTHORIZATION TO CONSTRUCT, ALL MATERIALS SHALL MEET THE STANDARDS AND RECEIVE THE WRITTEN APPROVAL, BASED ON MANUFACTURER'S DRAWINGS AND OTHER DATA, OF THE WARWICK SEWER AUTHORITY.
- 3. ALL SEWERAGE FACILITIES SHALL MEET TESTING AND CLEANING REQUIREMENTS PRIOR TO ACCEPTANCE.
- 4. THE CONTRACTOR IS RESPONSIBLE TO COORDINATE AS-BUILT LOCATIONS PRIOR TO PIPE BACKFILL. AS-BUILT DRAWINGS SHALL BE FURNISHED AS A CONDITION FOR ACCEPTANCE OF THE NEW SEWERAGE FACILITIES. PLANS SHALL INCLUDE LOCATION OF WYES.
- 5. NO FLOW WILL BE ACCEPTED UNTIL ALL ABOVE STEPS ARE COMPLETED AND COMPLETION CERTIFICATE IS ISSUED.
- 6. AFTER THE CONTRACTOR HAS "STAKED OUT" THE FACILITIES TO BE CONSTRUCTED AND HAS THE APPROVED MATERIALS ON THE JOB, THE WARWICK SEWER AUTHORITY SHALL BE NOTIFIED IN ADVANCE OF CONSTRUCTION IN ORDER FOR THEM TO ARRANGE FOR THEIR INSPECTOR. THE NOTIFICATION MUST MEET THE WARWICK SEWER AUTHORITY REQUIREMENTS.
- 7. ALL CONSTRUCTION SHALL BE IN ACCORDANCE WITH THE APPROVED PLANS AND MATERIALS, STANDARDS AND SPECIAL DETAILS, AND STANDARD SPECIFICATIONS, ANY WORK NOT MEETING THE APPROVED STANDARDS SHALL BE IMMEDIATELY REMOVED AND REPLACED AT THE CONTRACTOR'S EXPENSE.
- 8. THE CONTRACTOR SHALL CONFINE HIS OPERATIONS AND ACTIVITIES FOR CONSTRUCTION WITHIN THE LIMITS OF WORK AS SHOWN ON THE DRAWINGS.
- 9. ALL AREAS DISTURBED BY THE CONTRACTOR SHALL BE RESTORED TO THEIR ORIGINAL CONDITION AT NO EXTRA COST TO THE OWNER. ALL GRASSED AREAS DISTURBED BY THE CONTRACTOR'S OPERATIONS SHALL BE LOAMED AND SEEDED
- 10. LOCATION AND DEPTHS OF EXISTING UTILITIES ARE APPROXIMATE AND HAVE BEEN PLOTTED FROM THE BEST AVAILABLE INFORMATION. THE CONTRACTOR SHALL VERIFY LOCATIONS OF ALL EXISTING UTILITIES AND NOTIFY THE APPROPRIATE UTILITY AUTHORITIES INCLUDING "DIG-SAFE" PRIOR TO STARTING WORK. ANY DAMAGE TO UTILITIES CAUSED BY THE CONTRACTOR'S OPERATIONS SHALL BE THE RESPONSIBILITY OF THE CONTRACTOR AND THE COST OF REPAIRS SHALL BE BORNE BY THE CONTRACTOR AT NO ADDITIONAL COST TO THE OWNER.
- 11. RELATION TO WATER LINES:
- A. HORIZONTAL SEPARATION: WHENEVER POSSIBLE, SEWERS SHOULD BE LAID AT A MINIMUM OF 10 FEET (3.0 m), HORIZONTALLY, FROM ANY EXISTING OR PROPOSED WATER LINE. SHOULD LOCAL CONDITIONS PREVENT A LATERAL SEPARATION OF 10 FEET, A SEWER MAY BE LAID CLOSER THAN 10 FEET TO A
- 1. IT IS LAID IN A SEPARATE TRENCH, OR IF
- 2. IT IS LAID IN THE SAME TRENCH WITH THE WATER LINE LOCATED AT ONE SIDE ON A BENCH OF UNDISTURBED EARTH, AND IF
- 3. IN EITHER CASE THE ELEVATION OF THE TOP (CROWN) OF THE SEWER IS AT LEAST 18 INCHES (46 cm) BELOW THE BOTTOM (INVERT) OF THE WATER
- VERTICAL SEPARATION: WHENEVER A SEWER MUST CROSS UNDER WATER LINES, THE SEWER SHALL BE LAID AT SUCH AN ELEVATION THAT THE TOP OF THE SEWER IS AT LEAST 18 INCHES (46 cm) BELOW THE BOTTOM OF THE WATER LINE. WHEN THE ELEVATION OF THE SEWER CANNOT BE VARIED TO MEET THE ABOVE REQUIREMENTS, THE WATER LINE SHALL BE RELOCATED TO PROVIDE THIS SEPARATION OR RECONSTRUCTED WITH MECHANICAL-JOINT PIPE FOR A DISTANCE OF 10 FEET (3.0 m) ON EACH SIDE OF THE SEWER. ONE FULL LENGTH OF WATER LINE SHOULD BE CENTERED OVER THE SEWER SO THAT BOTH JOINTS WILL BE AS FAR FROM THE SEWER AS POSSIBLE.
- C. WHEN IT IS IMPOSSIBLE TO OBTAIN HORIZONTAL AND/OR VERTICAL SEPARATION AS STIPULATED ABOVE, BOTH THE WATER LINE AND SEWER SHALL BE CONSTRUCTED OF MECHANICAL-JOINT CEMENT LINED DUCTILE IRON PIPE OR OTHER EQUIVALENT BASED ON WATER TIGHTNESS AND STRUCTURAL SOUNDNESS. BOTH PIPES SHALL BE PRESSURE TESTED BY AN APPROVED METHOD TO ASSURE
- 12. CONTRACTOR SHALL BE RESPONSIBLE FOR ANY DEWATERING REQUIRED IN THE SEWER INSTALLATION.
- 13. THE PROPOSED GRAVITY SANITARY SEWER PIPE SHALL BE PVC SCHEDULE 40. UNLESS OTHERWISE SHOWN ON PLANS. PIPE SIZE TO MATCH UTILITY PLAN.
- 14. THE CONTRACTOR IS RESPONSIBLE TO VERIFY THE LOCATION AND ELEVATION OF EXISTING SEWER LINE PRIOR TO INSTALLATION. PRIOR TO CONSTRUCTION, THE CONTRACTOR SHALL DIG TEST HOLES AND COORDINATE ALL INFORMATION WITH THE
- 15. THE PENETRATIONS ON THE OIL/WATER SEPARATOR SHALL USE KOR-N-SEAL EPDM RUBBER BOOTS WITH STAINLESS STEEL BANDS AND CLAMPS (OR EQUAL).
- 16. PRIOR TO BACKFILL, THE CONTRACTOR SHALL CONTACT THE WARWICK SEWER AUTHORITY TO COORDINATE INSPECTIONS.
- 17. ALL TANKS SHALL BE WATER TIGHT AND WATER TIGHT TESTING AND/OR CERTIFICATIONS SHALL BE PROVIDED TO THE WARWICK SEWER AUTHORITY AND ENGINEER.
- 18. CONTRACTOR SHALL VENT ALL TANKS AS REQUIRED BY THE MANUFACTURER AND WARWICK SEWER AUTHORITY. VENT LOCATIONS SHALL BE COORDINATED WITH THE ARCHITECT. PROVIDE CHARCOAL FILTERS.


SEWER TRENCH NOTES


- 1. MINIMUM WIDTH (W) OF TRENCH IS EQUAL TO THE INSIDE DIAMETER OF THE PIPE PLUS 12" EACH SIDE.
- 2. SOIL UNDER CRUSHED STONE FOUNDATION SHALL BE UNDISTURBED AND COMPACTED MATERIAL WITH SEVERAL PASSES OF A VIBRATORY PLATE COMPACTOR TO ATTAIN 95% MAX. DENSITY (MOD. METHOD).
- 3. CRUSHED STONE FOUNDATION 3/4" MAXIMUM SIZE, SHALL BE PLACED 6" UNDER THE PIPE AND UP TO THE PIPE LAID THEREON, CRUSHED STONE PULLED AGAINST THE PIPE SIDES TO FIRMLY HOLD THE PIPE IN PLACE.
- 4. CRUSHED STONE HAUNCHING 3/4" MAXIMUM SIZE SHALL BE BROUGHT LEVEL TO THE TOP OF THE PIPE AND OUT TO THE TRENCH WALL AT THIS ELEVATION FOR ALL PIPE.
- 5. PIPE SHALL BE SCHEDULE 40 PVC OR APPROVED EQUAL.

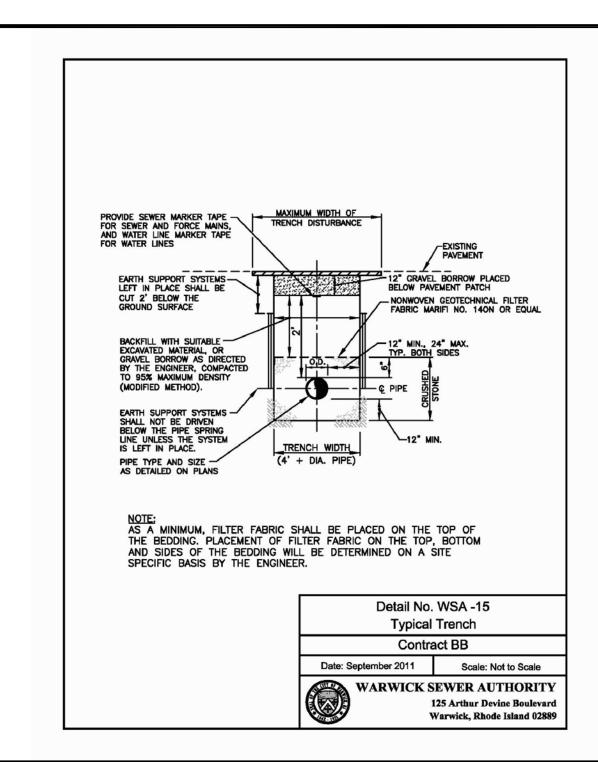


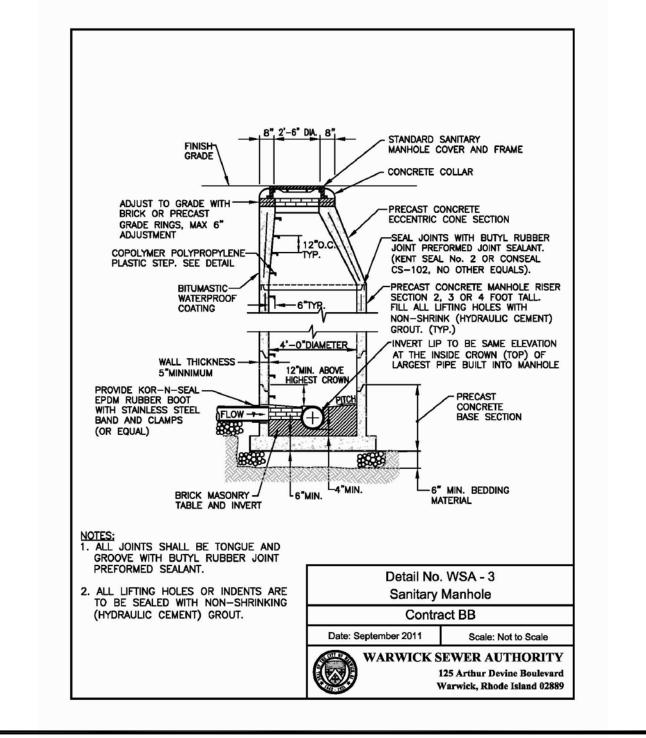


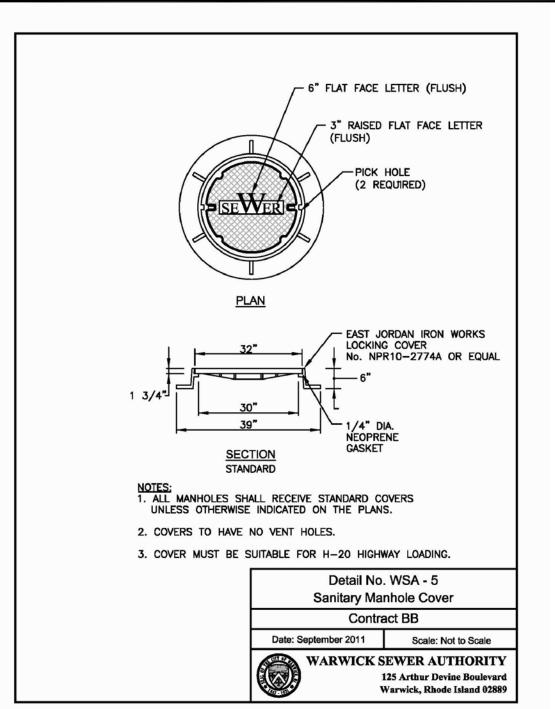

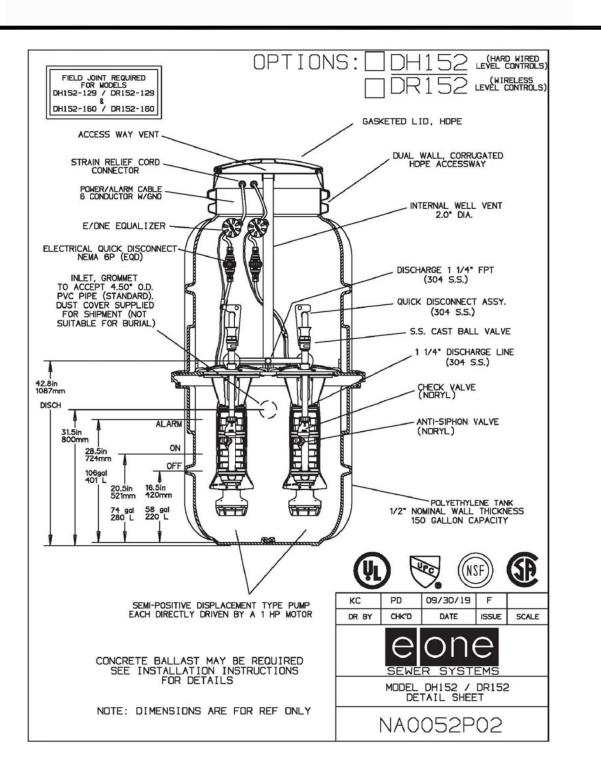


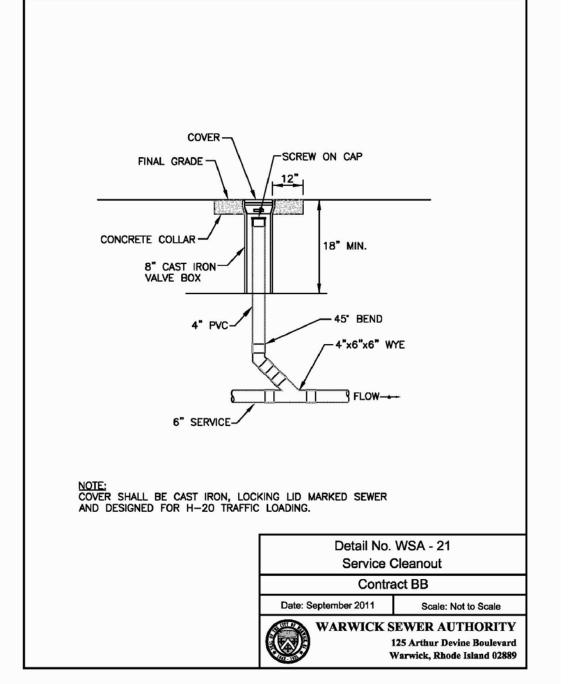

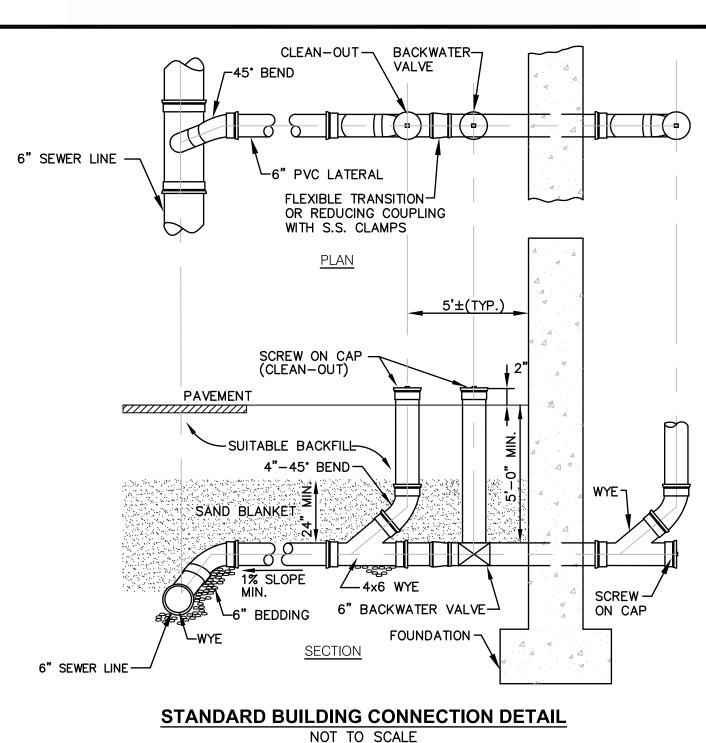

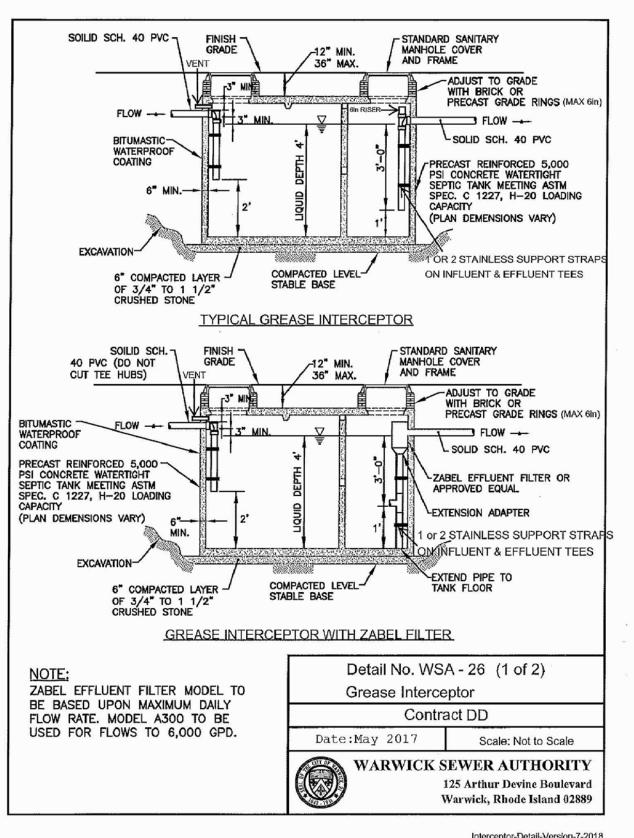

Interceptor-Detail-Version-7-2018

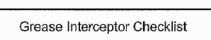

- Interceptor with standard effluent tee
- Tank has H20 loading capacity
- Bitumastic waterproof coating
- Influent and effluent tees visible in cover opening Influent and effluent tees have at least 1 stainless support strap
- Effluent tee has 6in riser
- Influent standpipe 24in off bottom of tank
- Effluent standpipe 12in off bottom of tank
- At least 2 manhole covers over tees. Larger tanks (2000+) may require 3 manhole covers with third near center for proper cleaning.

nterceptor with Zabel filter additional items:

Zabel filter must be installed according to manufacturer's specifications.

(stainless strap not needed if space does not allow).

- Support pipe installed to floor under the filter with tee opening position 12in off the floor
- Support pipe under the tee must have at least four 1in holes near bottom for draining
- during tank cleanings.

Handle extension must be installed on the filter if it cannot be safely reached.

Detail No. WSA - 26 (2 of 2) Grease Interceptor Contract DD Date: May 2017 Scale: Not to Scale WARWICK SEWER AUTHORITY 125 Arthur Devine Boulevard Warwick, Rhode Island 02889

Interceptor-Detail-Version-7-2018



Crossman Engineering

103 Commonwealth Avenue 151 Centerville Road Warwick, RI 02886 North Attleboro, MA 02763 Phone (401) 738-5660 Phone (508) 695-1700

Email: cei@crossmaneng.com

THESE DRAWINGS ARE THE PROPERTY OF CROSSMAN ENGINEERING AND HAVE BEEN PREPARED FOR THEIR CLIEN' FOR A SPECIFIC SITE AND PROJECT, THESE DRAWINGS ARI NOT TO BE COPIED OR USED FOR ANY OTHER PURPOSE WITHOUT THE WRITTEN CONSENT OF CROSSMAN ENGINEERIN

KEY PLAN

PROJECT TITLE:

PROPOSED

PLAT MAP 319, LOTS 2, 4 & 502 ZONING DISTRICT **GENERAL BUSINESS** 35 WEST SHORE ROAD **WARWICK, RHODE ISLAND**

PREPARED FOR:

E&J WEST SHORE REALTY, LLC

75 TIPPING ROCK DRIVE EAST GREENWICH, RI 02818

DRAWING TITLE:


APRIL 2021

MISCELLANEOUS DETAIL PLAN No. 4

		, ,,	110125	
VG. NAME: 2416-14-DETAIL4.dwg				
EVISIONS				
NUMBER	REM	ARKS	DATE	
1	PRELIMINA	ARY PLAN	10/1/21	
2	RIDEM CO	OMMENTS	12/1/21	
3	RIDOT CO	OMMENTS	12/28/21	
4	RIDOT CO	OMMENTS	2/14/22	

AS NOTED

SHEET: 14 OF: 18

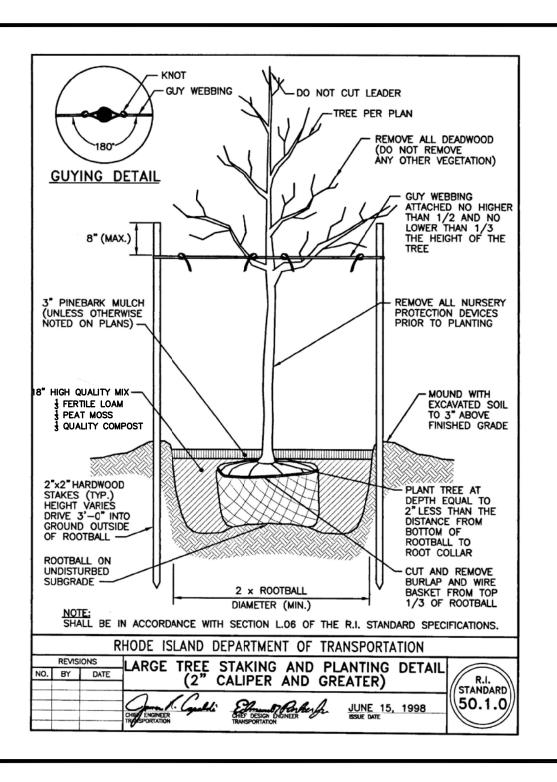

FURNISH AND INSTALL ALL PLANTS SHOWN ON THE DRAWINGS SPECIFIED HEREIN, AND IN THE

NURSERY STOCK SHALL MEET THE STANDARDS OF THE AMERICAN NURSERY AND LANDSCAPE

QUANTITIES LISTED ON THE PLANT LIST. NO SUBSTITUTIONS WILL BE PERMITTED, UNLESS APPROVED BY

ASSOCIATION AS TO GRADING AND QUALITY. CALIPER MEASUREMENTS FOR ALL NEW PLANT STOCK TO

ABOVE GRADE FOR TREES OVER FOUR (4) INCHES. ALL TREES SHALL BE A MINIMUM OF SEVEN (7)

FEET ABOVE FINISHED GRADE WHEN TRÈES ARE LOCATED WITHIN VEHICULAR AND PEDESTRIAN TRÀVEL

ONLY NURSERY-GROWN PLANTS, GROWN IN ACCORDANCE WITH ACCEPTED HORTICULTURAL PRACTICES.

AND GROWN UNDER CLIMATIC CONDITIONS SIMILAR TO TO THOSE IN THE LOCALITY OF THE PROJECT FOR

SET PLANTS PLUMB AND AT A LEVEL THAT AFTER SETTLEMENT THEY BEAR THE SAME RELATION TO THE

WATERING: WATER ALL PLANTS WITHIN 48 HOURS AFTER PLANTING. IF CONDITIONS WARRANT. AND AS

MATERIAL FOR PLANTS, THOROUGHLY AND PROPERLY BY FIRMING OR TAMPING. FORM SAUCERS,

CAPABLE OF HOLDING WATER ABOUT INDIVIDUAL PLANTS, BY PLACING RIDGES OF PLANTING SOIL

MANY TIMES THEREAFTER TO SUSTAIN HEALTHY CONDITIONS UNTIL LANDSCAPE INSTALLATION IS COMPLETED. SATURATE THE SOIL AROUND EACH PLANT THOROUGHLY AT EACH WATERING.

PRUNING: PRUNE PLANTS, AS DIRECTED BY OWNER, AT THE PROJECT SITE BEFORE OR IMMEDIATELY AFTER PLANTING IN ACCORDANCE WITH THE BEST HORTICULTURAL PRACTICE. CUT BROKEN, DEAD OR

BROKEN ROOTS ON THE PLANT SIDE OF THE BREAK. PAINT CUTS OVER 3/4" IN DIAMETER WITH TREE

SYMMETRY OF THE PLANT, AND SHALL NOT REDUCE THE HEIGHT BY MORE THAN ONE—THIRD. DO NOT CUT BACK THE LEADER OF THE PLANT UNLESS DIRECTED BY THE LANDSCAPE ARCHITECT.

POUNDS PER 100 SQUARE FEET OF SURFACE AREA BROADCAST. APPLY THE FERTILIZER UNIFORMLY TO

THE SURFACE BEDS AND WORK INTO THE UPPER TWO INCHES OF SOIL. FERTILIZE INDIVIDUAL TREES AT

A RATE OF ONE AGRIFORM PELLET PER INCH OF TRUNK DIAMETER (FOLLOW MANUFACTURER'S WRITTEN

INSTRUCTIONS). APPLY A SECOND APPLICATION OF FERTILIZER TO ALL PLANT ITEMS AT THE SAME

. MULCHING: WITHIN A 72 HOUR PERIOD AFTER PLANTING, COVER ALL PLANTED AREAS WITH 3" DARK HEMLOCK MULCH. NO RED OR DYED MULCH IS TO BE USED. MULCH SHOULD BE PULLED ONE INCH AWAY FROM PLANT TRUNK OR STEM, AND NOT ALLOWED TO REST DIRECTLY AGAINST THE TRUNK OR STEM.

12. GUARANTEE: ALL PLANTS FURNISHED BY THE CONTRACTOR SHALL BE GUARANTEED FOR A PERIOD OF ONE (1) YEAR AFTER PRELIMINARY INSPECTION AND SHALL BE ALIVE AND IN SATISFACTORY GROWTH AT THE ÈND OF THE GUARANTEE PERIOD. ALL DEAD OR DYING PLANT MATERIAL SHALL BE REPLACED AT

10. LIMING: ADD POWDERED LIME EVERY SIX MONTHS - OR SLOW RELEASE GRANULAR LIME-AS PER

SPECIFIED RATES OVER THE MULCH AT THE END OF AN EIGHT WEEK PERIOD.

INJURED BRANCHES IMMEDIATELY ABOVE THE STEM COLLAR ON THE TRUNK OR LIMB. PRUNE ALL

WOUND PAINT. PRUNING SHALL NOT DEFORM OR OTHERWISE DESTROY THE TYPICAL SHAPE OR

FERTILIZING: FERTILIZE SHRUB BEDS WITH 10-6-4 FERTILIZER BROADCAST AT A RATE OF THREE

3. STAKE ALL TREES OVER 5 FEET AS SHOWN ON PLANS. REMOVE STAKES AT THE END OF THE

SURROUNDING GROUND AS THEY BORE TO THE GROUND FROM WHICH THEY WERE DUG. SETTLE BACKFILL

BE TAKEN SIX (6) INCHES ABOVE GRADE FOR TREES UNDER FOUR (4) INCHES AND TWELVE (12) INCHES

LOAM TO BE SCREENED, GOOD QUALITY, FERTILE, FREE OF WEEDS, STICKS, STONES OVER 3/4", AND

LANDSCAPE CONSTRUCTION NOTES

AT LEAST TWO (2) YEARS, WILL BE ACCEPTED.

MANUFACTURER'S INSTRUCTION.

ONCE BY THE CONTRACTOR, FREE OF CHARGE.

ROOTS. SPREAD TO A MINIMUM OF 4" OVER ALL PLANTED AREAS.

- DO NOT CUT LEADER TREE PER PLAN REMOVE ALL DEADWOOD **GUYING DETAIL** ANY OTHER VEGETATION) ATTACHED NO HIGHER THAN 1/2 AND NO LOWER THAN 1/3 THE HEIGHT OF THE TREE " HIGH QUALITY MIX -EXCAVATED SOIL TO 3" ABOVE PEAT MOSS 1 QUALITY COMPOS 2"x2" HARDWOOD STAKES (TYP.) HEIGHT VARIES DRIVE 3'-0" INTO GROUND OUTSIDE OF PLANTING PIT - CUT AND REMOVE NOTE: SHALL BE IN ACCORDANCE WITH SECTION L.06 OF THE R.I. STANDARD SPECIFICATIONS. RHODE ISLAND DEPARTMENT OF TRANSPORTATION EVERGREEN TREE PLANTING DETAIL '-0" HIGH AND GREATER)

CHIEF DESIGN ENGINEER

- SHRUB PER PLAN REMOVE ALL DEADWOOD (DO NOT REMOVE ANY OTHER VEGETATION) 18" HIGH QUALITY MIX 3 QUALITY COMPO (UNLESS OTHERWISE NOTED ON PLANS) -- MOUND WITH EXCAVATED SOIL TO 3" ABOVE FINISHED GRADE GENTLY HAND LOOSEN SOIL FROM AROUND ROOTBALL WITHOUT SEVERING MAIN ROOTS SPREAD ROOTS OVER UNDISTURBED SUBGRADE -DISTANCE FROM BOTTOM OF THE ROOTBALL TO THE ROOT COLLAR NOTE: SHALL BE IN ACCORDANCE WITH SECTION L.06 OF THE R.I. STANDARD SPECIFICATIONS. RHODE ISLAND DEPARTMENT OF TRANSPORTATION CONTAINER GROWN SHRUB PLANTING DETAIL

- 1'-0" CLEARANCE -6'-0" STANDARD STEEL POST 2'-0" (MIN.) EVERGREEN TREE 1'-0" CLEARANCE 6'-0" STANDARD STEEL POST -DECIDUOUS TREE NOTE: SHALL BE IN ACCORDANCE WITH SECTION L.11 OF THE R.I. STANDARD SPECIFICATIONS. RHODE ISLAND DEPARTMENT OF TRANSPORTATION DRIP LINE TREE PROTECTION DEVICE FOR EXISTING TREES

WATER NOTES


- ALL INSTALLATION, JOINTS, CONSTRUCTION METHODS AND MATERIALS SHALL BE ACCORDING TO WARWICK WATER DIVISION REQUIREMENTS. AWWA STANDARDS AND GOVERNMENTAL REQUIREMENTS.
- 2. PROPOSED PIPE SHALL BE HDPE PIPE APPROVED BY WARWICK WATER DIVISION (BY AMERICAN MANUFACTURER ONLY). FITTINGS SHALL MEET THE WARWICK WATER DIVISION
- 3. CONSTRUCTION SHALL INCLUDE ALL PIPE, JOINTS, BENDS, TEES, FITTINGS, JOINTS, SERVICE CONNECTIONS AND ALL MISCELLANEOUS ITEMS REQUIRED TO CONSTRUCT THE
- 4. PRESSURE AND LEAKAGE TESTS AND DISINFECTING PIPES SHALL BE PERFORMED BY THE CONTRACTOR IN CONFORMANCE TO AMERICAN WATER WORKS ASSOCIATION (AWWA) RECOMMENDATIONS, WARWICK WATER DIVISION REQUIREMENTS, AND GOVERNMENTAL AGENCIES HAVING JURISDICTION.
- 5. ALL FITTINGS, PIPE, JOINTS, ETC. SHALL BE DESIGNED FOR 1.5 TIMES WORKING PRESSURE BUT NOT LESS THAN 150 PSI.
- 6. WATER PIPE SHALL TYPICALLY BE LOCATED AT LEAST TEN (10) FEET HORIZONTALLY FROM SEWER PIPE, AND AT A MINIMUM DEPTH OF COVER EQUAL TO 5'. WHERE A NEW WATER MAIN IS LESS THAN 18 INCHES CLEAR DISTANCE ABOVE A SEWER OR WHERE A WATER MAIN PASSES BENEATH A SEWER, ENCASE THE SEWER IN 6" OF CONCRETE FOR A DISTANCE OF 10 FEET ON EACH SIDE OF THE CROSSING WATER MAIN. THE USE OF DUCTILE IRON TIGHT JOINT SEWER PIPE IN LIEU OF CONCRETE ENCASEMENT WILL BE CONSIDERED UPON CONTRACTORS SUBMITTAL OF SPECIFICATIONS TO ENGINEERS FOR APPROVAL.
- 7. ALL SYSTEM COMPONENTS AND CONSTRUCTION METHODS, SUCH AS PIPE, JOINTS, FITTINGS. ETC. SHALL BE SUBMITTED TO THE ENGINEER FOR APPROVAL PRIOR TO PURCHASE AND INSTALLATION. THIS SUBMISSION SHALL INCLUDE MANUFACTURER'S LITERATURE, SHOP DRAWINGS, PROPOSED CONSTRUCTION METHODS, ETC.
- WATER LINE TRENCH TO BE AWWA TYPE 5. A METALIZED DETECTABLE IDENTIFICATION TAPE 2" IN WIDTH, BLUE IN COLOR AND PRINTED WITH "CAUTION WATERLINE BURIED BELOW" SHALL BE UTILIZED OVER ALL MAINS. TAPE SHALL BE SET AT APPROXIMATELY 1'-0" BELOW FINISHED GRADE.
- PRIOR TO CONSTRUCTION THE CONTRACTOR SHALL COMPLETE AND SUBMIT THE "CONTRACTOR'S MATERIAL AND TEST CERTIFICATE" FOR UNDERGROUND PIPING TO THE WARWICK WATER DIVISION AND ENGINEER. IN ADDITION, THE CONTRACTOR IS REQUIRED TO SUBMIT THE FOLLOWING ITEMS TO THE ENGINEER FOR THEIR REVIEW AND
- TYPE AND MANUFACTURER OF CORPORATIONS AND CURB STOPS
- TYPE AND MANUFACTURER OF VALVE BOXES TYPE AND MANUFACTURER OF PIPING
- TYPE AND MANUFACTURER OF VALVES (OPEN LEFT)
- TYPE AND MANUFACTURER OF HDPE SERVICE LINE
- 10. WHEN THIS PROJECT IS COMPLETE, THE CONTRACTOR IS RESPONSIBLE TO PROVIDE THE WATER DEPARTMENT AND ENGINEER TWO SETS OF AS BUILT PLANS CERTIFIED BY A RHODE ISLAND LICENSED PROFESSIONAL ENGINEER (ONE BLUE LINE, ONE REPRODUCIBLE COPY-MYLAR OR SEPIA) WHICH INDICATES:
- a. ALL CURB STOPS WITH APPROPRIATE LOCATING MEASUREMENTS -MAIN-TO-CURB AND MEASUREMENTS FROM PERMANENT STRUCTURES.


b. A SCHEDULE OF MATERIALS WHICH INDICATES: AND MEASUREMENTS FROM PERMANENT STRUCTURES.


- 1. ITEM QUANTITY 2. MANUFACTURER
- 3. DESCRIPTION a. INCLUDE SERIAL #'S AS APPLICABLE
 - b. MATERIAL c. OPERATION CHARACTERISTICS
- . PIPE DEPTHS AT 50' INTERVALS
- d. PIPE CROSSING LOCATIONS AND SEPARATION DISTANCES
- 11. THE CONTRACTOR SHALL VERIFY THE SERVICE PIPE SIZE REQUIREMENT WITH THE BUILDING ARCHITECT AND PLUMBING CONTRACTOR PRIOR TO ORDERING PIPE, METERS AND BACKFLOW PREVENTORS. COORDINATION WITH THE WARWICK FIRE CHIEF AND WARWICK WATER DIVISION IS REQUIRED TO DETERMINE THE EXISTING WATER PRESSURE AVAILABLE.
- 12. ALL VALVES TO OPEN LEFT.
- 13. A SOLID STAINLESS STEEL INSERT SHALL BE INSTALLED AT EACH HDPE PIPE CONNECTION AND A 12-FOOT TYPE "K" COPPER WHIP SHALL BE INSTALLED AT THE POINT OF ENTRY INTO THE BUILDING.

NOTES:

14. HDPE PIPE SHALL CONFORM TO ASTM D1248 TYPE III, GRADE P34, CLASS A, CATEGORY 5, COLOR BLUE WITH VIRGIN CLEAR NATURAL CENTER. AWWA C901, 200 PSI

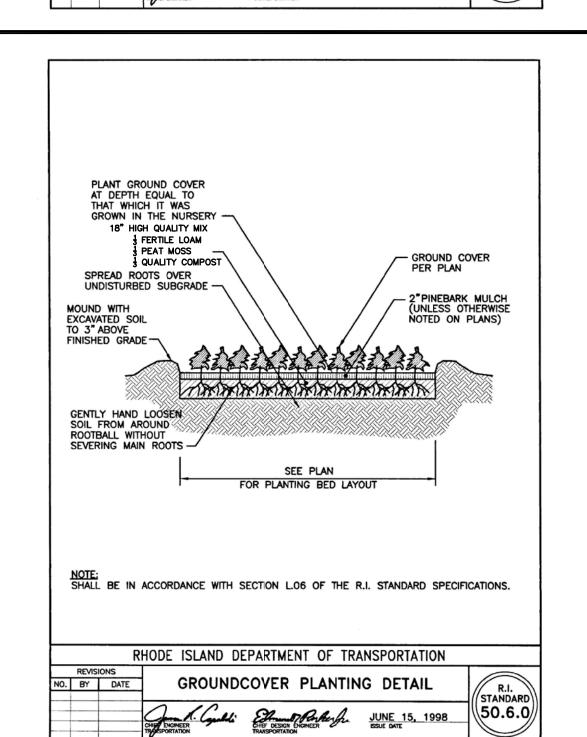

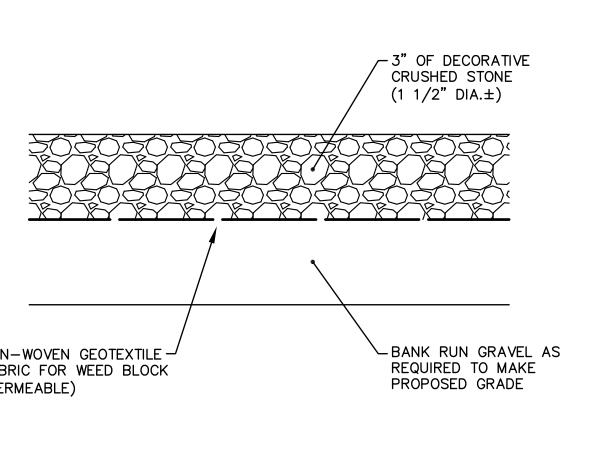

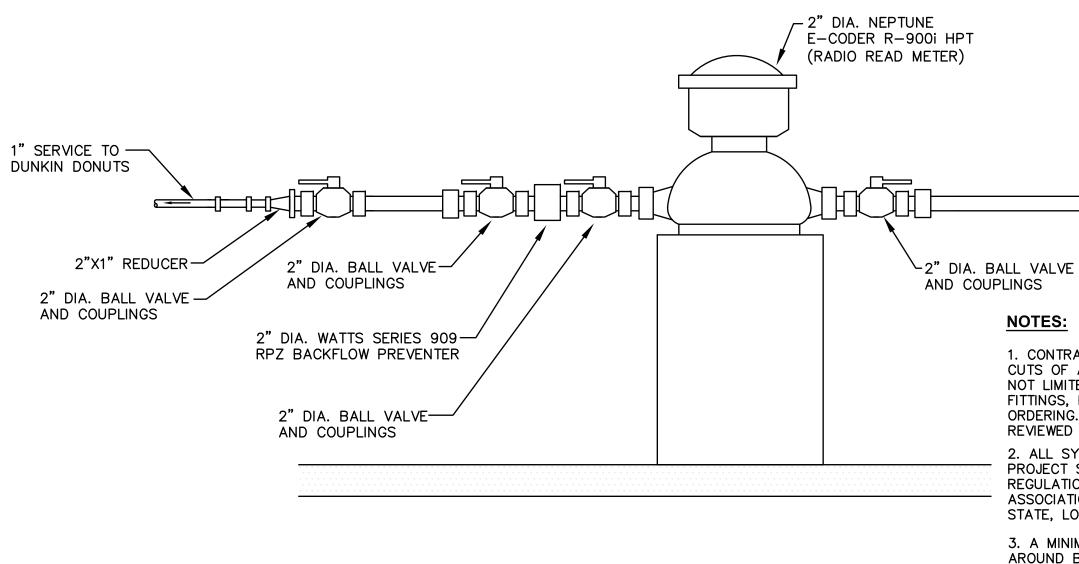

1. CONTRACTOR TO SUBMIT SHOP DRAWINGS/CATALOG CUTS OF ALL BACKFLOW COMPONENTS, INCLUDING BUT NOT LIMITED TO BACKFLOW PREVENTERS, METERS, FITTINGS, PIPES, ETC., TO VERIFY SIZES PRIOR TO ORDERING. ALL COMPONENT SHOP DRAWINGS ARE TO BE REVIEWED AND APPROVED BY THE ENGINEER. 2. ALL SYSTEM COMPONENTS MUST CONFORM TO THE

← 2"W TO SITE

PROJECT SPECIFICATIONS, WARWICK WATER DIVISION REGULATIONS, THE NATIONAL FIRE PROTECTION ASSOCIATION STANDARDS, INCLUDING NFPA-20, AND STATE, LOCAL AND FEDERAL REGULATIONS AND CODES.

3. A MINIMUM CLEARANCE OF 12" SHALL BE MAINTAINED AROUND BACKFLOW PREVENTER

4. PROVIDE DOUBLE CHECK VALVE ASSEMBLY ON 1" SERVICE TO DUNKIN DONUTS.



Crossman Engineering

103 Commonwealth Avenue 151 Centerville Road Warwick, RI 02886 North Attleboro, MA 02763 Phone (401) 738-5660 Phone (508) 695-1700

Email: cei@crossmaneng.com

THESE DRAWINGS ARE THE PROPERTY OF CROSSMAN NCINEERING AND HAVE BEEN PREPARED FOR THEIR CLIEN FOR A SPECIFIC SITE AND PROJECT. THESE DRAWINGS ARE NOT TO BE COPIED OR USED FOR ANY OTHER PURPOSE WITHOUT THE WRITTEN CONSENT OF CROSSMAN ENGINEERIN

KEY PLAN

PROJECT TITLE:

PROPOSED

PLAT MAP 319, LOTS 2, 4 & 502 ZONING DISTRICT **GENERAL BUSINESS 35 WEST SHORE ROAD WARWICK, RHODE ISLAND**

PREPARED FOR:

E&J WEST SHORE REALTY, LLC

75 TIPPING ROCK DRIVE EAST GREENWICH, RI 02818

DRAWING TITLE:

APRIL 2021

MISCELLANEOUS DETAIL PLAN No. 5

AS NOTED

DWG. NAME:		
2	2416-15-DETAIL5.dw	⁄g
REVISIONS		
\triangle		
NUMBER	REMARKS	DATE
1	PRELIMINARY PLAN	10/1/
2	RIDEM COMMENTS	12/1/
3	RIDOT COMMENTS	12/28/
4	RIDOT COMMENTS	2/14/2

DRAWING NUMBER

SHEET: 15 OF: 18


1" PEAT MOSS-LOOSEN -ROOTS 18" HIGH QUALITY MIX - 1/3 FERTILE LOAM - 1/3 SAND COMPACTED -- 1/3 QUALITY COMPOST SUBGRADE PERENNIAL DETAIL NOT TO SCALE

NON-WOVEN GEOTEXTILE -FABRIC FOR WEED BLOCK (PERMEABLE)

CRUSHED STONE BED DETAIL

NOT TO SCALE

DOMESTIC WATER BACKFLOW AND METERING SYSTEM (INSIDE BUILDING) NOT TO SCALE

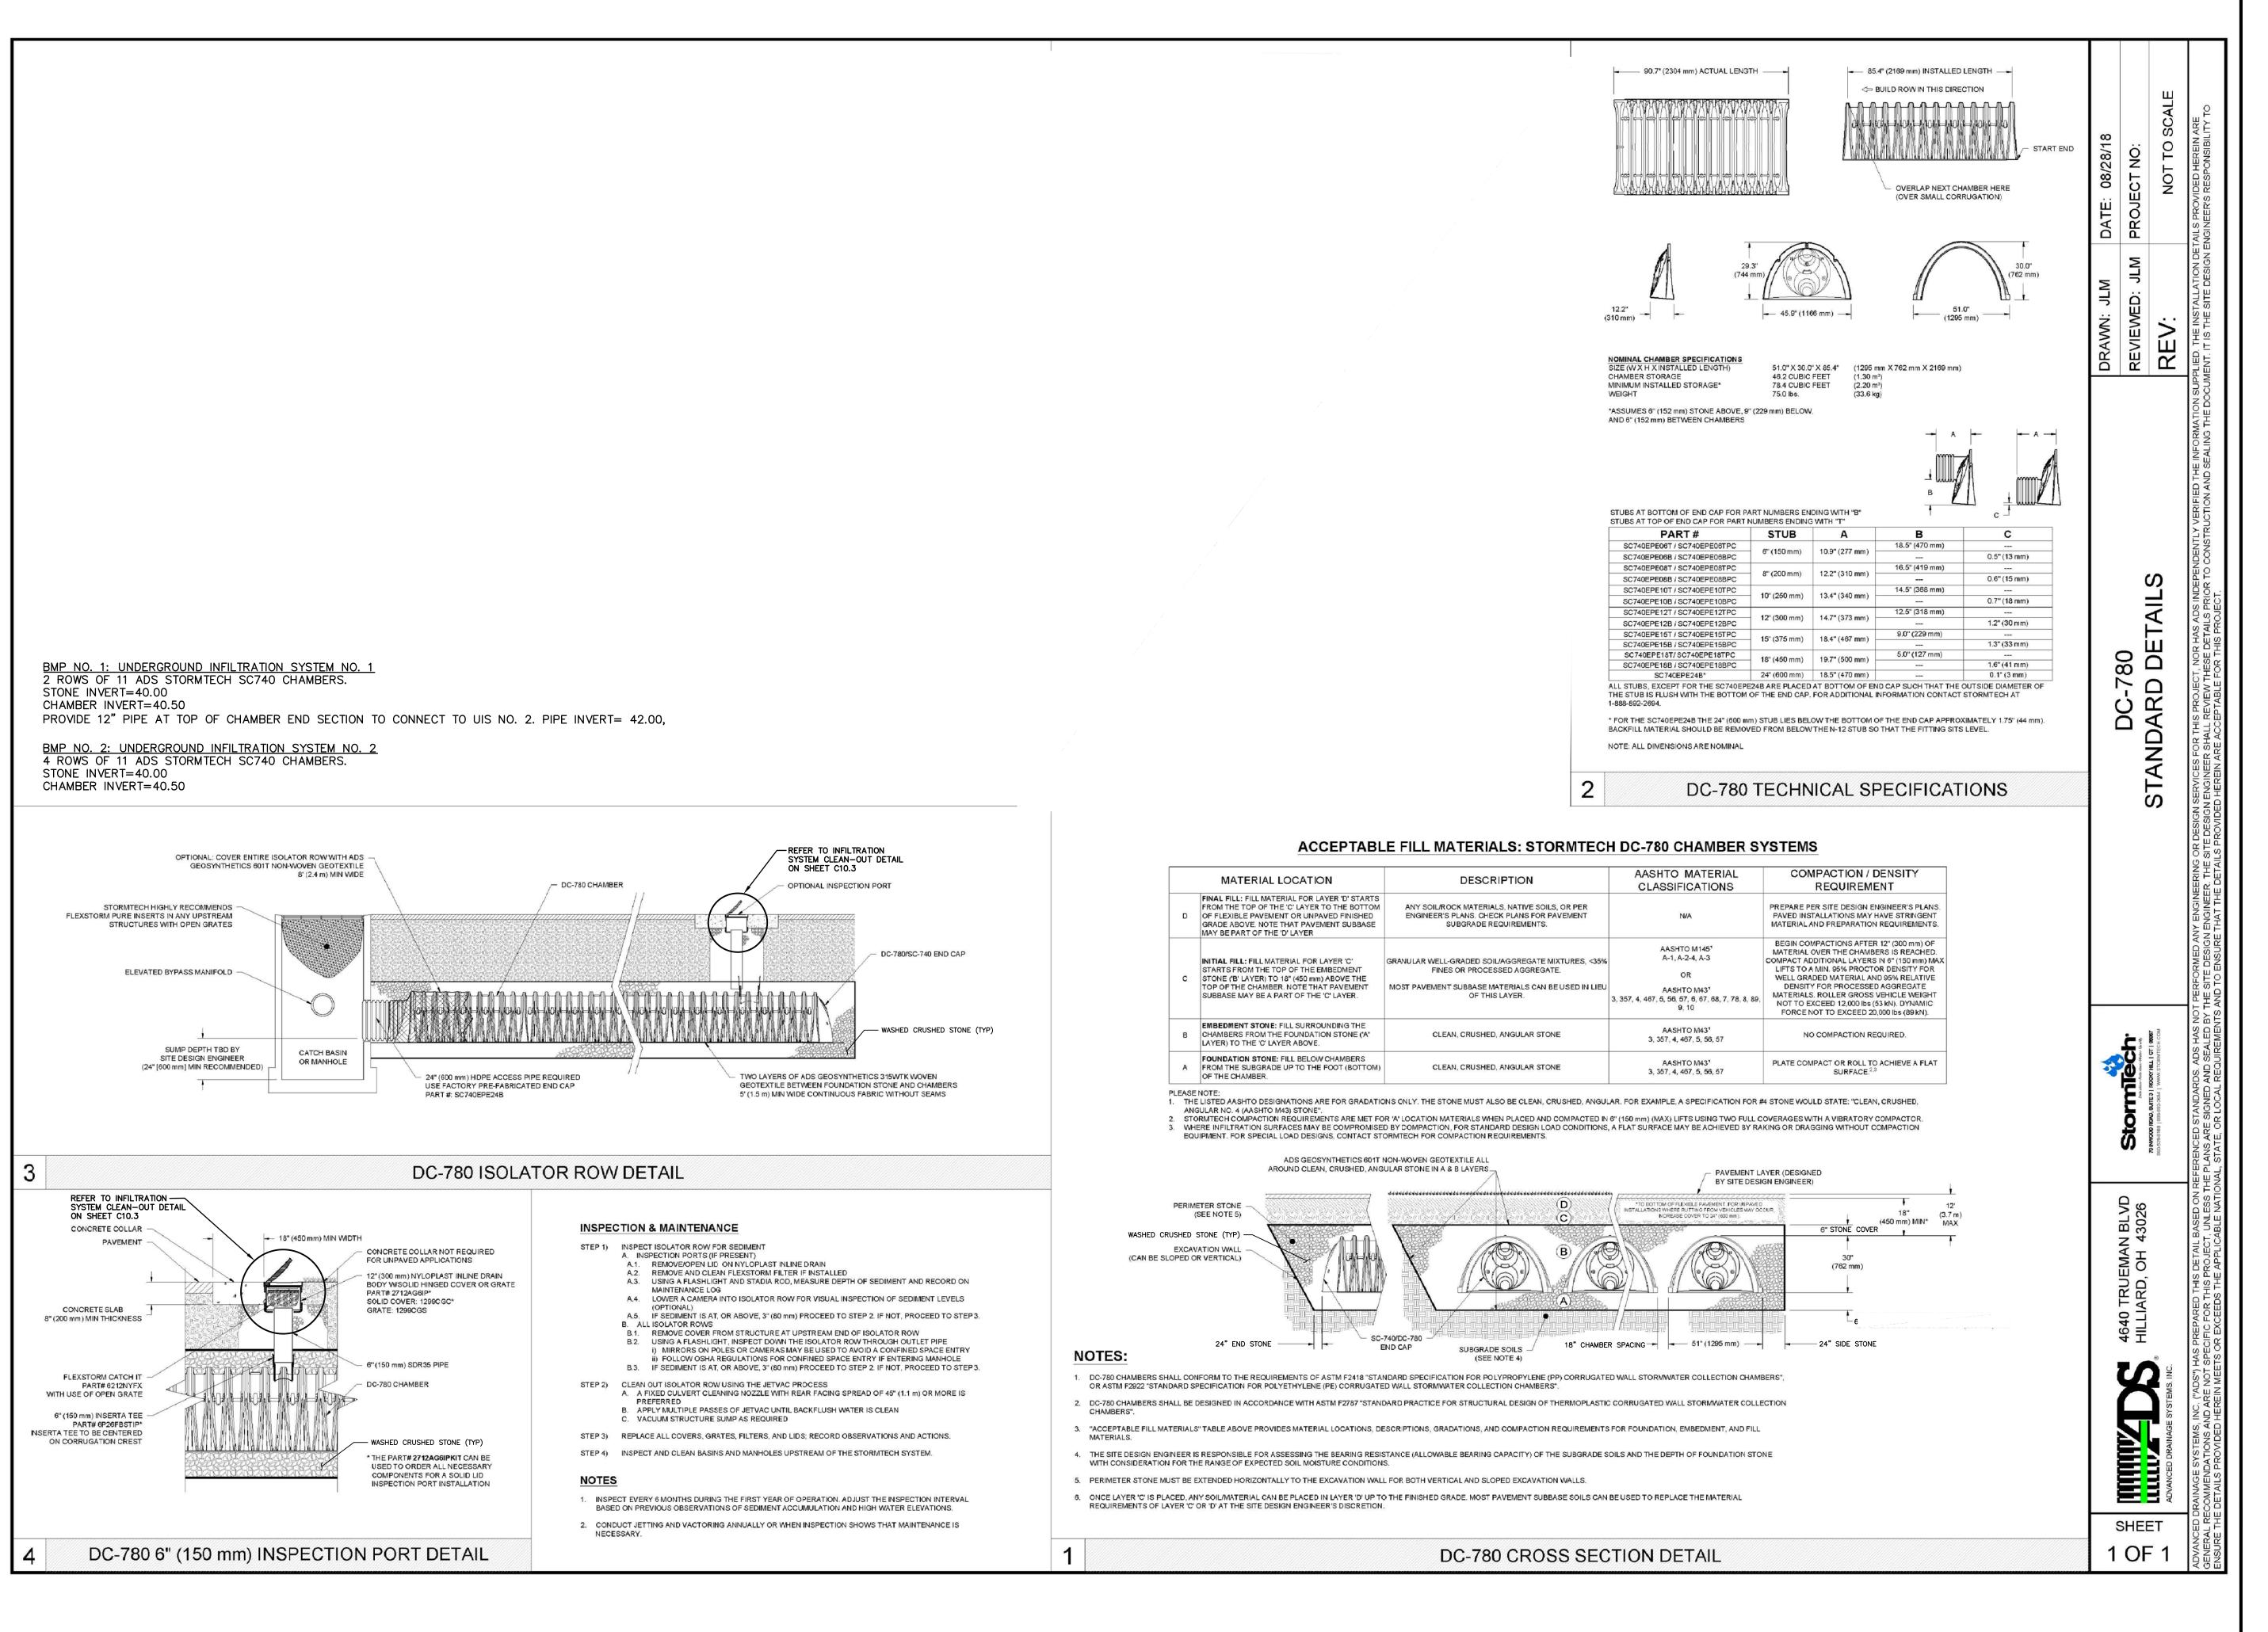



Crossman Engineering

Rhode Island
151 Centerville Road
Warwick, RI 02886
Phone (401) 738-5660

Massachusetts
103 Commonwealth Avenue
North Attleboro, MA 02763
Phone (508) 695-1700

Email: cei@crossmaneng.com

THESE DRAWINGS ARE THE PROPERTY OF CROSSMAN ENGINEERING AND HAVE BEEN PREPARED FOR THEIR CLIENT FOR A SPECIFIC SITE AND PROJECT. THESE DRAWINGS ARE NOT TO BE COPIED OR USED FOR ANY OTHER PURPOSE WITHOUT THE WRITTEN CONSENT OF CROSSMAN ENGINEERING

KEY PLAN

PROJECT TITLE:

PROPOSED

DUNKI

PLAT MAP 319, LOTS 2, 4 & 502
ZONING DISTRICT
GENERAL BUSINESS
35 WEST SHORE ROAD
WARWICK, RHODE ISLAND

PREPARED FOR:

E&J WEST SHORE REALTY, LLC

75 TIPPING ROCK DRIVE EAST GREENWICH, RI 02818

DRAWING TITLE:

MISCELLANEOUS
DETAIL PLAN No. 6

SCALE:

APRIL 2021 AS NOTED

DWG. NAME: 2416-16-DETAIL6.dwg


REVISIONS


NUMBERREMARKSDATE1PRELIMINARY PLAN10/1/212RIDEM COMMENTS12/1/213RIDOT COMMENTS12/28/214RIDOT COMMENTS2/14/22

DRAWING NUMBER

C10.6

SHEET: 16 OF: 18

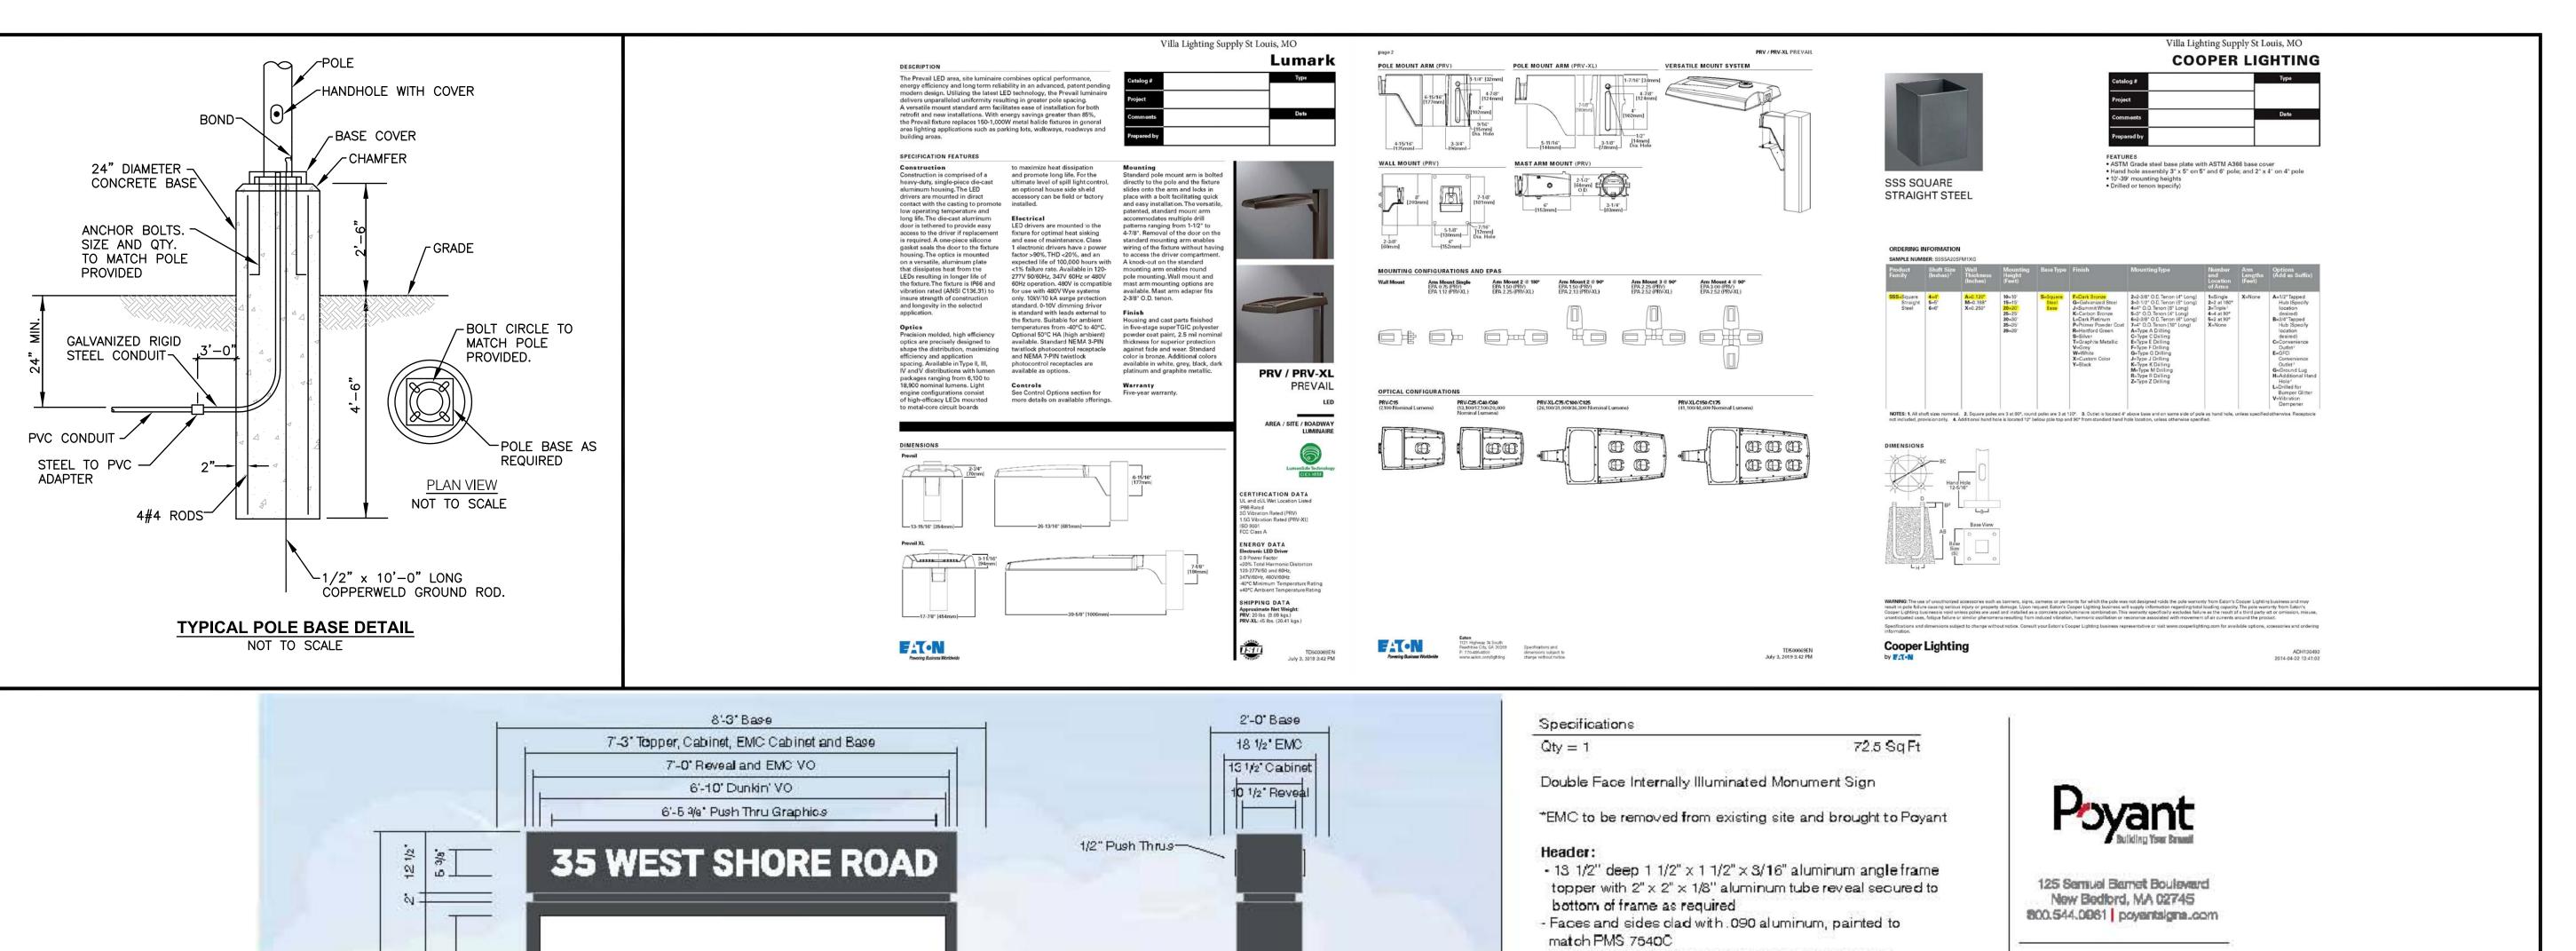

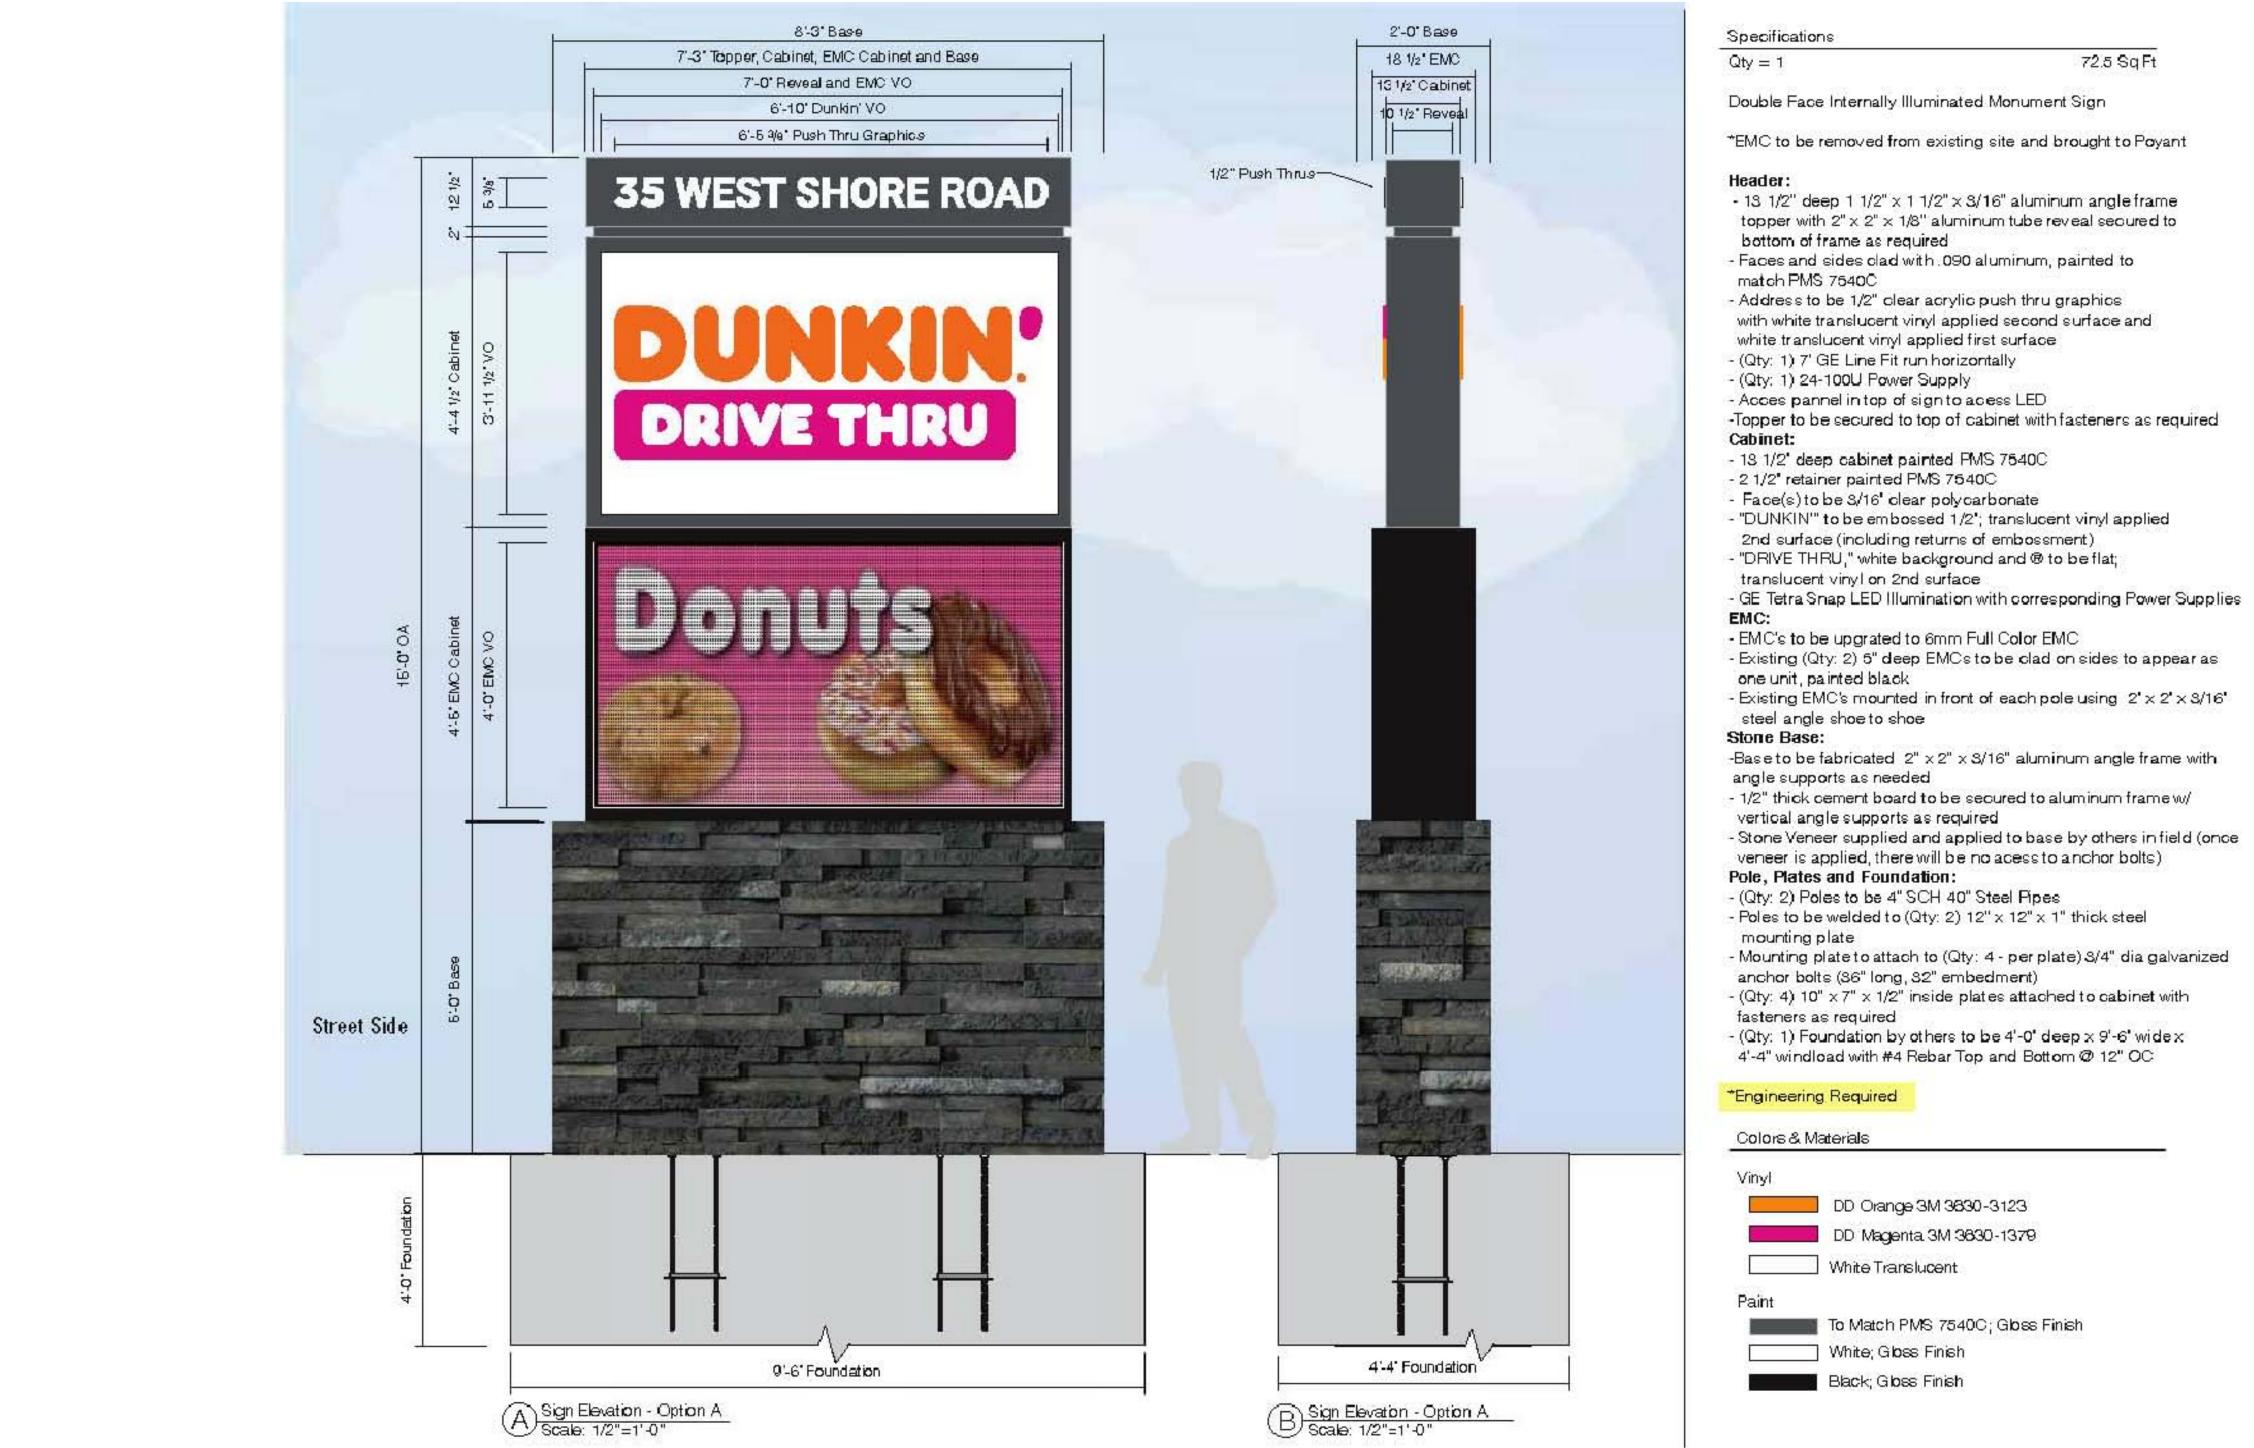

35 West Shore Road Warwick, RI 02889

Project: 1.9467

Dunkin'

Sales: Bill Gavigan Jr. Date: 4.13.21 Designer: RMA

Notes

This is an original unpublished drawing created by Poyant Signa, inc. It is submitted for your personal use in connection with a project being planned for you by Poyant Signa, inc. It is not to be shown to anyone outside your organization, nor is it to be reproduced, copied or enhibited in any fashion until transferred.

4.23.21 RMA (R2) Added to Package



This sign is interested to its fractiled in assertioness with this exploiments of Article 200 of the Neutonal Electrical Code and / or other applicable least so dec. This hastates peoper prounding and bonding of the aign



Al Signage Shown is Covered by Poyant's Exclusive DD Franchisee 3 Year Branid Identity Wauranty Program

Approved By:

Date:

Monument

Option B

Sign Type 19457.1B-R2

PROJECT TITLE:

KEY PLAN

PROPOSED

Civil

Crossman Engineering

Rhode Island Massachusetts
151 Centerville Road 103 Commonwealth Avenue

Phone (401) 738-5660

Warwick, RI 02886 North Attleboro, MA 02763

Email: cei@crossmaneng.com

THESE DRAWINGS ARE THE PROPERTY OF CROSSMAN ENGINEERING AND HAVE BEEN PREPARED FOR THEIR CLIEN

FOR A SPECIFIC SITE AND PROJECT. THESE DRAWINGS ARI

NOT TO BE COPIED OR USED FOR ANY OTHER PURPOSE

WITHOUT THE WRITTEN CONSENT OF CROSSMAN ENGINEERIN

Transportation

Environmental

 Site Planning Surveying

Landscape Architectur

Phone (508) 695-1700

Permitting

PLAT MAP 319, LOTS 2, 4 & 502 ZONING DISTRICT **GENERAL BUSINESS 35 WEST SHORE ROAD WARWICK, RHODE ISLAND**

PREPARED FOR:

E&J WEST SHORE REALTY, LLC

75 TIPPING ROCK DRIVE EAST GREENWICH, RI 02818

DRAWING TITLE:

MISCELLANEOUS DETAIL PLAN No. 7

DATE:	SCALE:
APRIL 2021	AS NOTED
DWC NAME:	

2416-17-DETAIL7.dwg


REVISIONS


NUMBER REMARKS DATEPRELIMINARY PLAN 10/1/21 RIDEM COMMENTS | 12/1/21 RIDOT COMMENTS | 12/28/21 RIDOT COMMENTS | 2/14/22

	PLANTING SCHEDULE								
		TREES							
Key	Quantity	Botanical Name Common Name	Spacing	Size	Remarks				
CBF	7	Carpinus betulus 'Fastigiata' Columnar Hornbeam	as shown	2-2 1/2" cal.	В&В				
CK	5	Cornus kousa Kousa Dogwood	as shown	2-2 1/2" cal.	B & B				
JT	6	Juniperus virginiana 'Taylor'	as shown	6' - 8'	B & B				
PA	1	Platanus acerifolia	as shown	2-2 1/2" cal.	B & B				
PP	7	Picea pungens 'Hoopsi'	as shown	6' - 8'	B & B				
PS	6	Colorado Blue Spruce Pinus stobus	as shown	6' - 8'	B & B				
PSG	-	White Pine Prunus sargentii							
	1	Sargent's Cherry Thuja occidentalis 'Nigra'	as shown	2 - 2 1/2" cal.	B & B				
TON	40	Dark Green Arborvitae	as shown	6' - 8'	B & B				
	T T	SHRUBS	T	T					
BM	14	Buxus microphylla 'Green Mountain' Green Mountain Boxwood	as shown	#3	cont.				
CF	6	Chamaecyparis p. 'King's Gold' Gold Threadleaf Falsecypress	as shown	#5	cont.				
CA	6	Cornus sanguinea 'Artic Fire' Artic Fire Redtwig Dogwood	as shown	#5	cont.				
НМ	29	Hydrangea macrophylla 'Nikko Blue' Nikko Blue Hydrangea	as shown	#5	cont.				
HL	4	Hydrangea p. 'Little Lime' Little Lime Dwarf Green Hydrangea	as shown	#5	cont.				
IGS	20	Ilex glabra 'Shamrock' Shamrock Inkberry	as shown	#5	cont.				
MD	34	Microbiota decusata Siberian Cypress	as shown	#3	cont,				
RBN	17	Rhododendron 'Boule De Neige' White Compact Rhododendron	as shown	24"-30"	В&В				
RS	16	Rhododendron 'Scintillation'	as shown	24"-30"	B & B				
RDK	14	Pink Compact Rhododendron Rosa 'Double White Knockout'	30" o.c.	#2	cont.				
RF	71	Rosa 'Flower Carpet Red'	30" o.c.	#2	cont.				
SG	21	Red Groundcover Rose Spirea japonica 'Gold Flame'	as shown	#5	cont.				
SMK	11	Syringa p. 'Miss Kim'	as shown	#5	cont.				
DIVIL		Miss Kim Dwarf Lilac GROUNDCOVER	as snown	113					
		Hemerocallis 'Stella D'Oro'							
HSD	81	Dwarf Reblooming Daylily Hosta 'Sieboldiana Elegans'	24" o.c.	#1	cont.				
HSE	5	Large Blue Hosta	as shown	#2	cont.				
JS	103	Juniperus chinensis 'Sargenii' Green Sargent's Juniper	36" o.c.	#2	cont.				
JSG	22	Juniperus chinensis "Sea of Gold' Sea of Gold Juniper	as shown	#5	cont.				
MS	23	Miscanthus sinensis 'Yaku Jima' Yaku Jima Dwarf Maiden Grass	as shown	#3	cont.				
NN	9	Nipponanthemum nipponicum Montauk Daisy	30' o.c.	#1	cont.				
SS	15	Schizachyrium scoparium 'The Blues' Little Bluestem	as shown	#2	cont.				

NOTES:

- 1. DECORATIVE STONE OR MULCH TO BE USED IN PLANTING BEDS SITE WIDE. COORDINATE COLOR AND SIZE WITH OWNER. ALL LANDSCAPED AREAS ONSITE WILL BE WITHIN PLANTING BEDS AND WILL RECEIVE STONE COVER. NO GRASS AREAS ARE PROPOSED. ALL STONE AREAS SHALL HAVE A WEED BLOCK FILTER FABRIC BELOW.
- 2. PROPOSED STREET TREES WILL BE SPACED 50' ON CENTER.

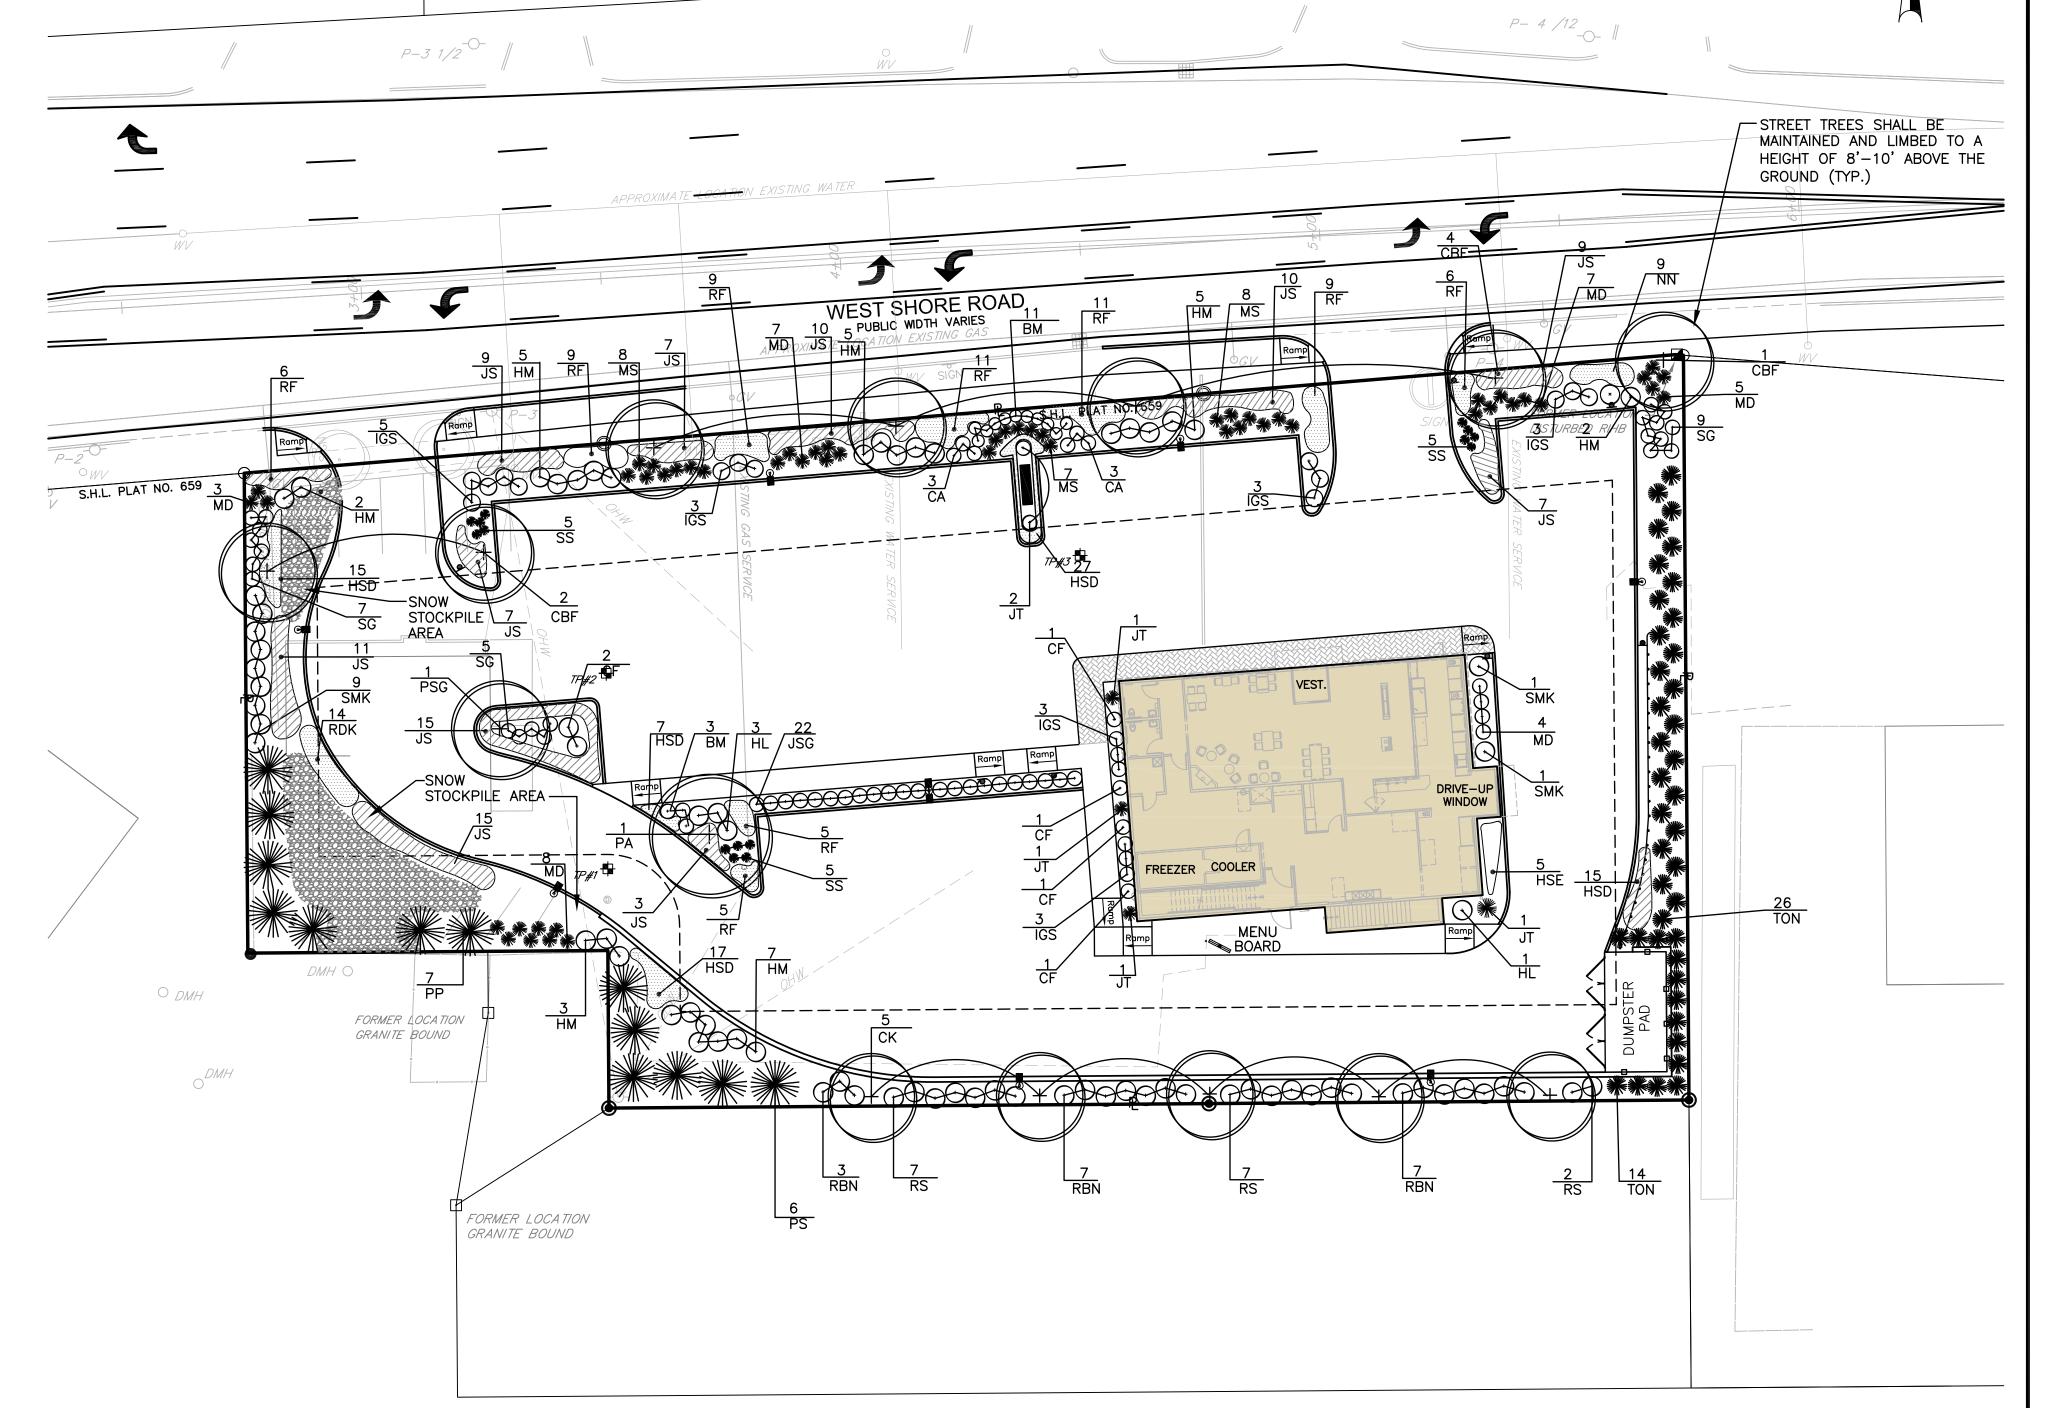

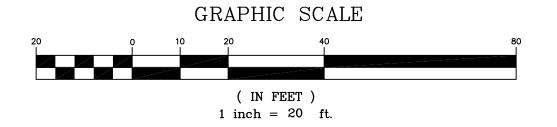



APPROX. LOCATION 1 1/2" FORCE MAIN (FROM NOTES)

Surveying Permitting Landscape Architectur

 Environmental Site Planning

Crossman Engineering

Rhode Island
151 Centerville Road
Warwick, RI 02886
Phone (401) 738-5660

Massachusetts
103 Commonwealth Avenue
North Attleboro, MA 02763
Phone (508) 695-1700

Email: cei@crossmaneng.com

WITHOUT THE WRITTEN CONSENT OF CROSSMAN ENGINEERING

THESE DRAWINGS ARE THE PROPERTY OF CROSSMAN ENGINEERING AND HAVE BEEN PREPARED FOR THEIR CLIENT FOR A SPECIFIC SITE AND PROJECT. THESE DRAWINGS ARE NOT TO BE COPIED OR USED FOR ANY OTHER PURPOSE

KEY PLAN

PROJECT TITLE:

PROPOSED

PLAT MAP 319, LOTS 2, 4 & 502 **ZONING DISTRICT GENERAL BUSINESS** 35 WEST SHORE ROAD **WARWICK, RHODE ISLAND**

PREPARED FOR:

E&J WEST SHORE REALTY, LLC

75 TIPPING ROCK DRIVE EAST GREENWICH, RI 02818

DRAWING TITLE:

LANDSCAPE PLAN

1"=20' APRIL 2021 DWG. NAME:

2416-18-LAND.dwg

REVISIONS

NUMBERREMARKSDATEPRELIMINARY PLAN 10/1/21 RIDEM COMMENTS 12/1/21 RIDOT COMMENTS 12/28/21

DRAWING NUMBER

SHEET: __18__ 0F: __18__