


RUSSEL SPEEDER'S CAR WASH

1119 DIVISION ST. WARWICK, RI

4/19/2023
SCEMATIC DESIGN
PHASE 1

PARCEL ID: 215/0007

	DRAWING LIST
SHEET NUMBER	SHEET NAME
A0.0	COVER
A0.1	SITE PLAN
A0.2	HALF SIZE ELEVATIONS
A1.0	FLOOR PLANS
A2.0	BUILDING ELEVATIONS
A2.1	BUILDING ELEVATIONS
A2.2	BUILDING ELEVATIONS

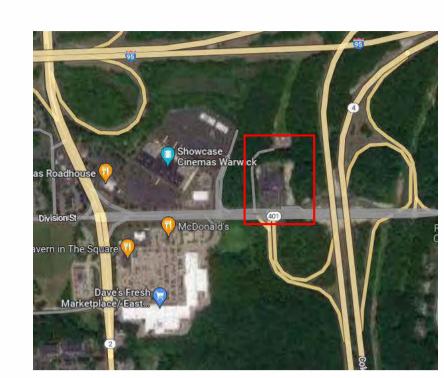

VICINITY MAP







SCEMATIC DESIGN GENERAL NOTES

1. THESE DRAWINGS INDICATE IN GENERAL THE PROJECT IN TERMS OF ARCHITECTURAL DESIGN INTENT, THE DIMENSIONS OF THE BUILDING, THE MAJOR ARCHITECTURAL ELEMENTS AND TYPE OF STRUCTURAL, MECHANICAL AND ELECTRICAL SYSTEMS. THE DRAWINGS DO NOT NECESSARILY INDICATE OR DESCRIBE ALL WORK REQUIRED FOR FULL PERFORMANCE AND COMPLETION OF THE REQUIREMENTS OF THE CONTRACT DOCUMENTS. AS INDICATED OR DESCRIBED, THE CONTRACTOR SHALL FURNISH ALL ITEMS REQUIRED FOR THE PROPER EXECUTION AND COMPLETION OF THE WORK.

2. THE CONTRACTOR SHALL COORDINATE ALL MECHANICAL FLOOR/WALL SLEEVES AND SHAFTS IN CONCRETE SLABS/WALLS WITH MECHANICAL, PLUMBING, FIRE PROTECTION, ELECTRICAL, STRUCTURAL AND ARCHITECTURAL DRAWINGS AND DISCREPANCIES, IF ANY, TO BE BROUGHT TO NOTICE OF THE ENGINEER PRIOR TO EXECUTION OF WORK.

3. THE CONTRACTOR SHALL CONDUCT HIS OWN SITE SURVEY OF THE EXISTING GROUND AND CURB ELEVATIONS (LEVELS) AND REPORT ACTUAL ELEVATIONS (LEVELS) TO THE ENGINEER.

4. CONTRACTOR'S SHOP DRAWINGS SHOULD INDICATE ACTUAL ELEVATIONS (LEVELS).

5. ALL ELEVATIONS (LEVELS) ARE IN FEET AND INCHES.

6. ALL DIMENSIONS ARE IN FEET AND INCHES AND ANGLES IN DEGREES UNLESS OTHERWISE NOTED.

7. ONLY WRITTEN DIMENSIONS IN ALL CASES SHALL BE FOLLOWED.

8. ALL EXISTING OR PROPOSED ELEVATIONS (LEVELS) AND DIMENSIONS, ON SITE AND ON DRAWINGS MUST BE CHECKED AND VERIFIED BY THE CONTRACTOR BEFORE THE PREPARATION OF SHOP DRAWINGS OR COMMENCEMENT OF ANY ITEM OF WORK ON THE SITE.


9. ARCHITECTURAL DRAWINGS MUST ALWAYS BE READ IN CONJUNCTION WITH ALL OTHER RELEVANT SERVICES DRAWINGS AND CONTRACT DOCUMENTS. ANY DISCREPANCY BETWEEN THESE DRAWINGSAND DOCUMENTS SHOULD BE REPORTED TO THE ENGINEER FOR CLARIFICATION AND VERIFICATION.

10. ALL ALUMINUM TRIMS SHALL BE POWDER COATED FINISH.

11. ALL PLASTERED SURFACES SHALL BE PAINTED.

FILL	IN	SCHE	MATIC	OR	DESIG	N DE	VEL	OF

AFTER CAREFUL REVIEW, PLEASE SIGN & SELEC	SHEMATIC DESIGN DRAWINGS: ISSUED: APRIL 15, 2023		
			REVIEWED BY: DATE:
CLIENT <approved or="" rejected=""> <description of<="" td=""><td>documentation approved> on MM/DD/YY with <no c<="" exceptions,="" td=""><td>OMMENTS, REQUEST TO REVISE AND RESUBMIT>.</td><td>SIGNATURE:</td></no></td></description></approved>	documentation approved> on MM/DD/YY with <no c<="" exceptions,="" td=""><td>OMMENTS, REQUEST TO REVISE AND RESUBMIT>.</td><td>SIGNATURE:</td></no>	OMMENTS, REQUEST TO REVISE AND RESUBMIT>.	SIGNATURE:

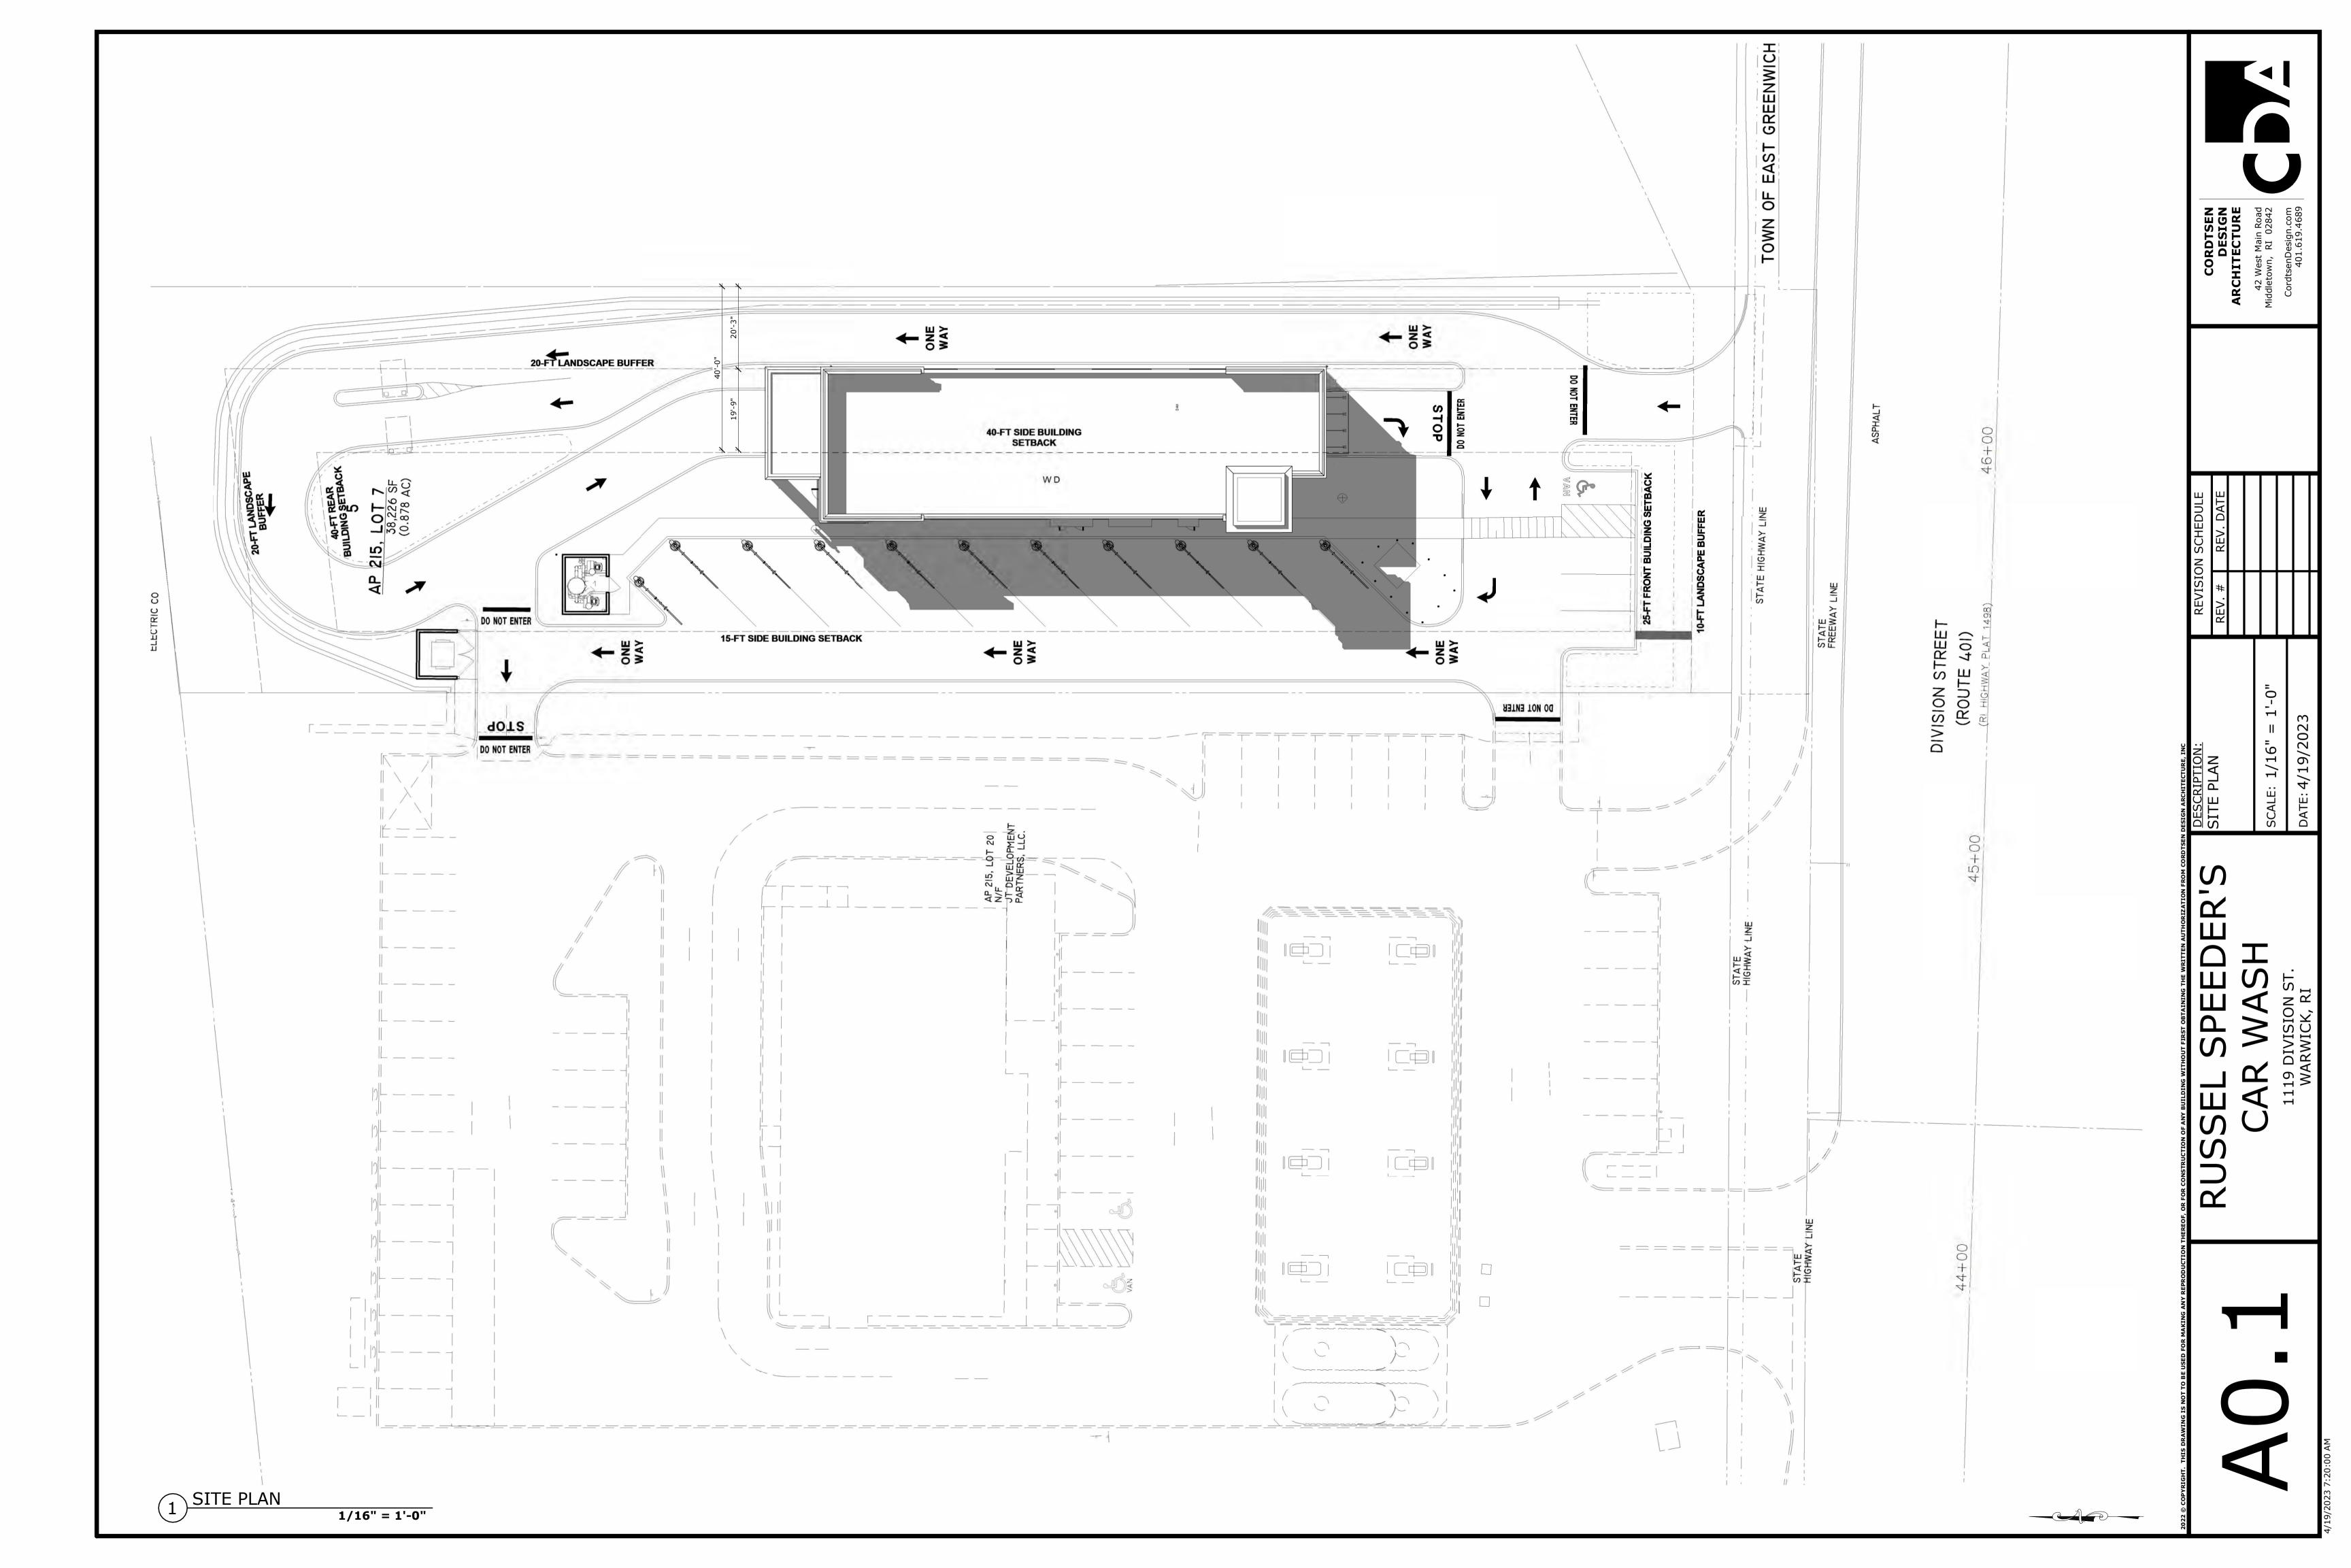

CORDTSEN DESIGN ARCHITECTURE	42 West Main Roac Middletown, RI 02842	CordtsenDesign.com 401 619 4689

CORDTSEN DESIGN ARCHITECTURE	42 West Main Road Middletown, RI 02842	CordtsenDesign.com 401.619.4689

CORDTSEN DESIGN ARCHITECTURE	42 West Main Road Middletown, RI 02842	CordtsenDesign.com 401.619.4689

CORDTSEN DESIGN ARCHITECTURE	42 West Main Road Middletown, RI 02842	CordtsenDesign.com 401.619.4689

DESIGN DESIGN ARCHITECTURE	42 West Main Road Middletown, RI 02842	CordtsenDesign.com 401.619.4689

401.6	
CordtsenDes	
Middletown, RI	
42 West Ma	
ARCHITEC	
בּב	

|--|

П		ARCHIT
		42 Wes Middletown
Π		Cordtsen 40


AR	Midd	Ö	



HALF SIZE ELEVAT	SCALE: $1/8'' = 1'-0'$
EEDER'S	۸SH

2 EAST ELEVATION HALF SIZE

1/8" = 1'-0"

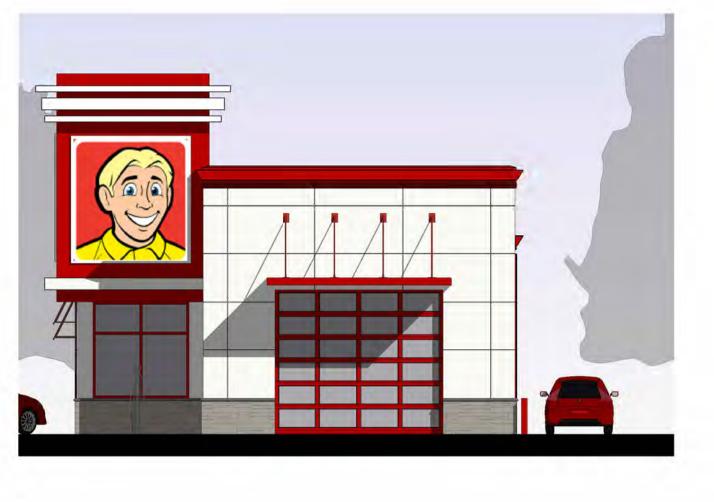


(1) SOUTH ELEVATION HALF SIZE 1/8" = 1'-0"



4 NORTH ELEVATION HALF SIZE 1/8" = 1'-0"



(3) WEST ELEVATION HALF SIZE 1/8" = 1'-0"

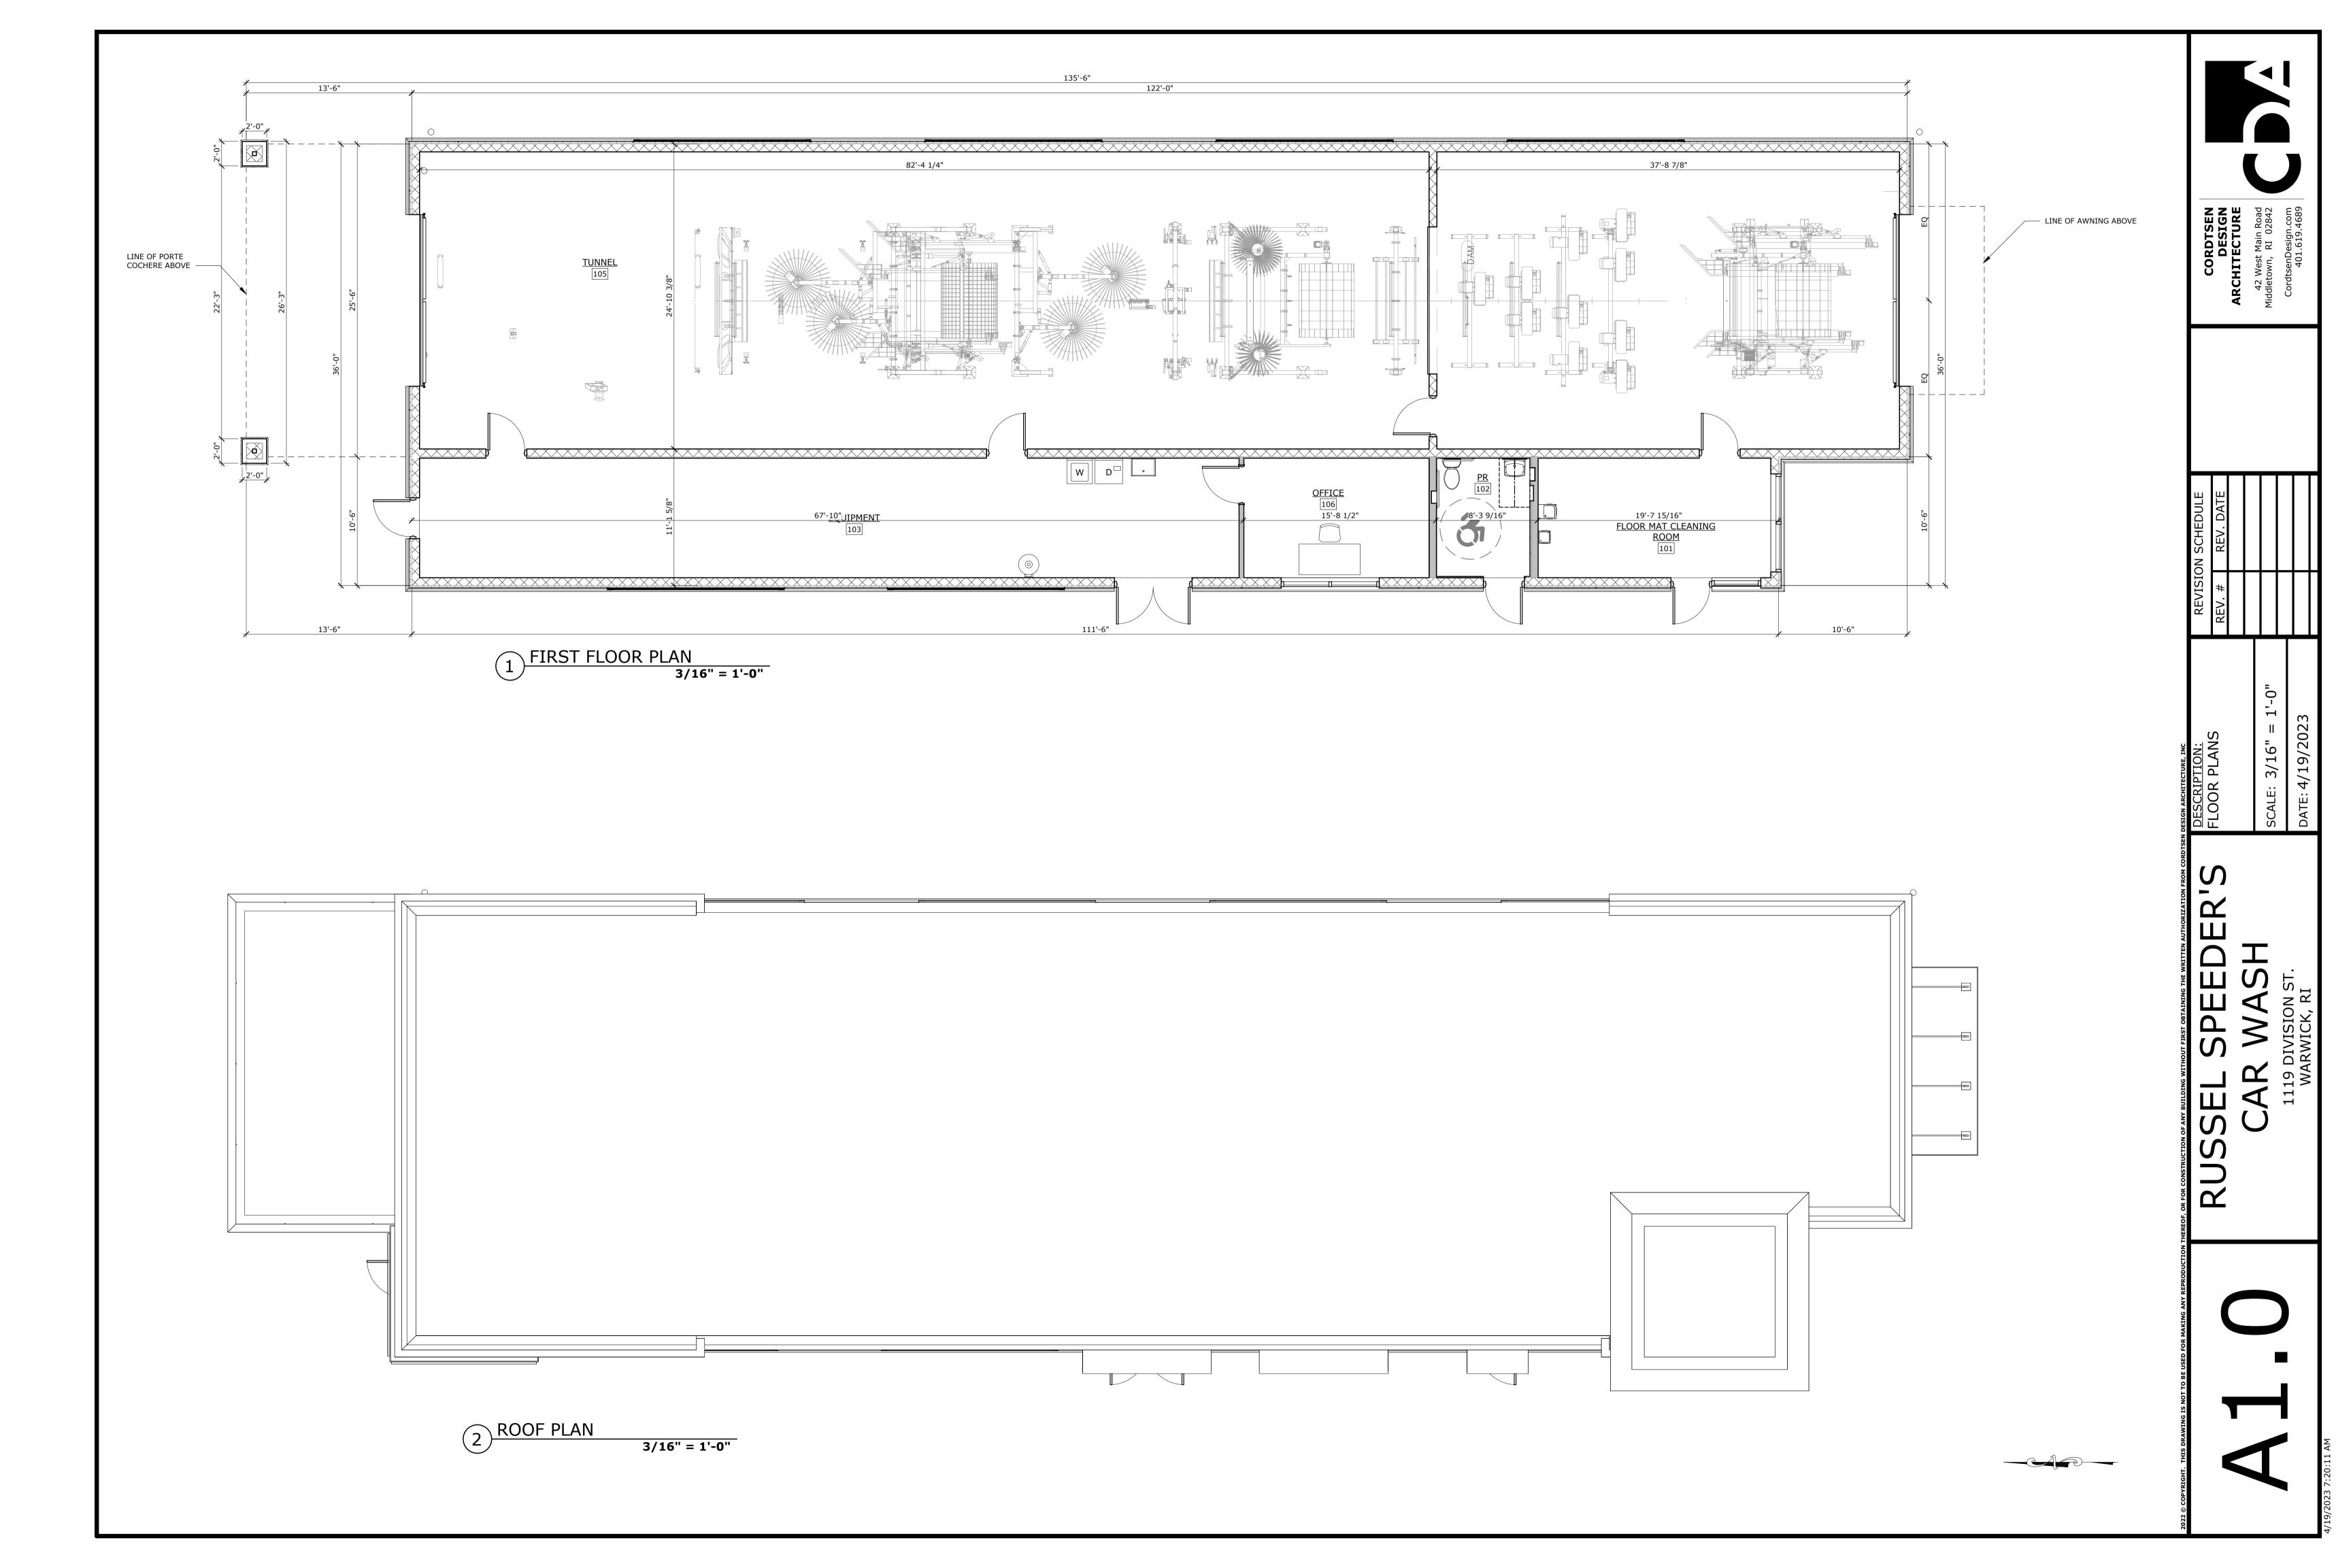

ELEVATION NOTE:
ALL SIGNAGE SHOWN FOR DESIGN INTENT
ONLY AND IS NOT A FINALIZED REPRESENTAION



1 SOUTH ELEVATION
1/4" = 1'-0"



2 NORTH ELEVATION
1/4" = 1'-0"


SCALE: 1/4" = 1'-0"

PATE: 4/19/2023

BUILDING ELEVATIONS
REV. #

SCALE: 1/4" = 1'-0"


DATE: 4/19/2023

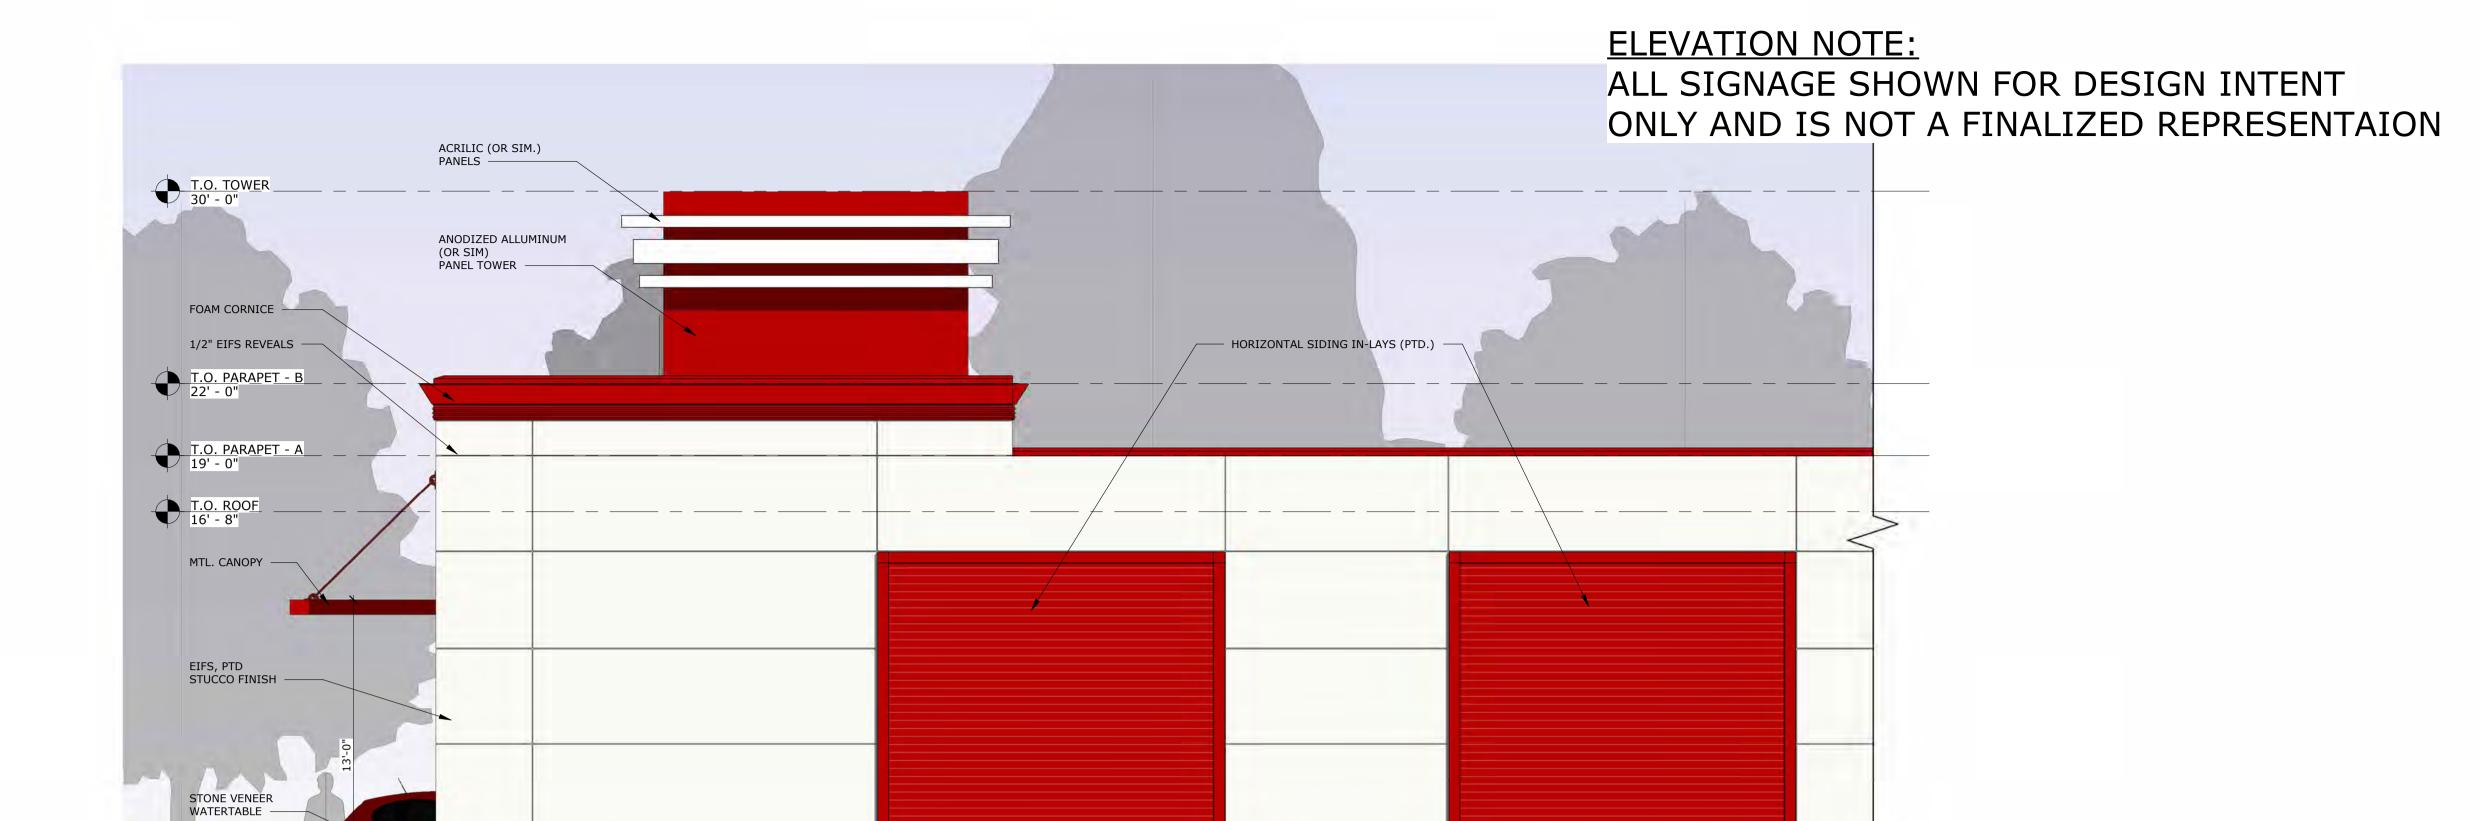


1 EAST ELEVATION - A 1/4" = 1'-0"



2 EAST ELEVATION - B
1/4" = 1'-0"

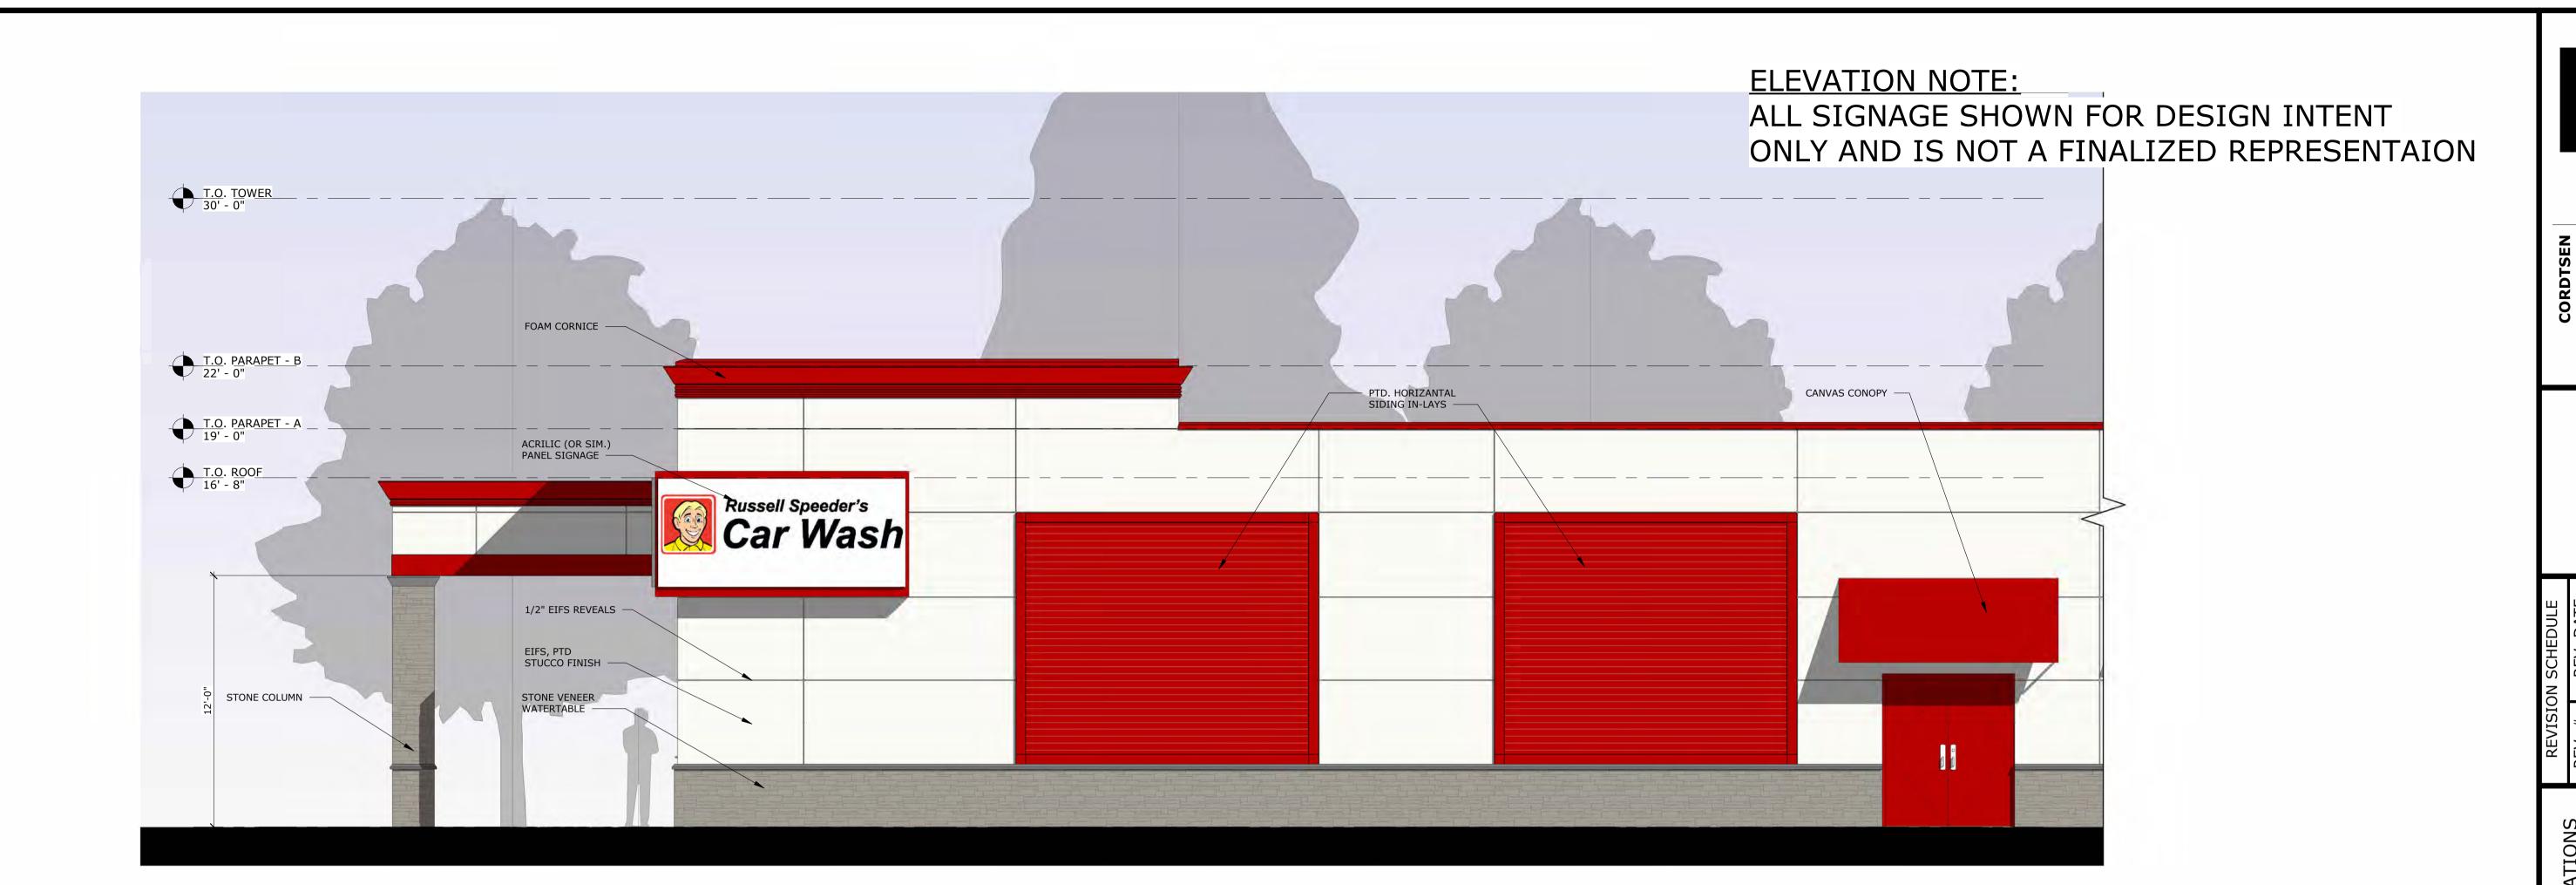

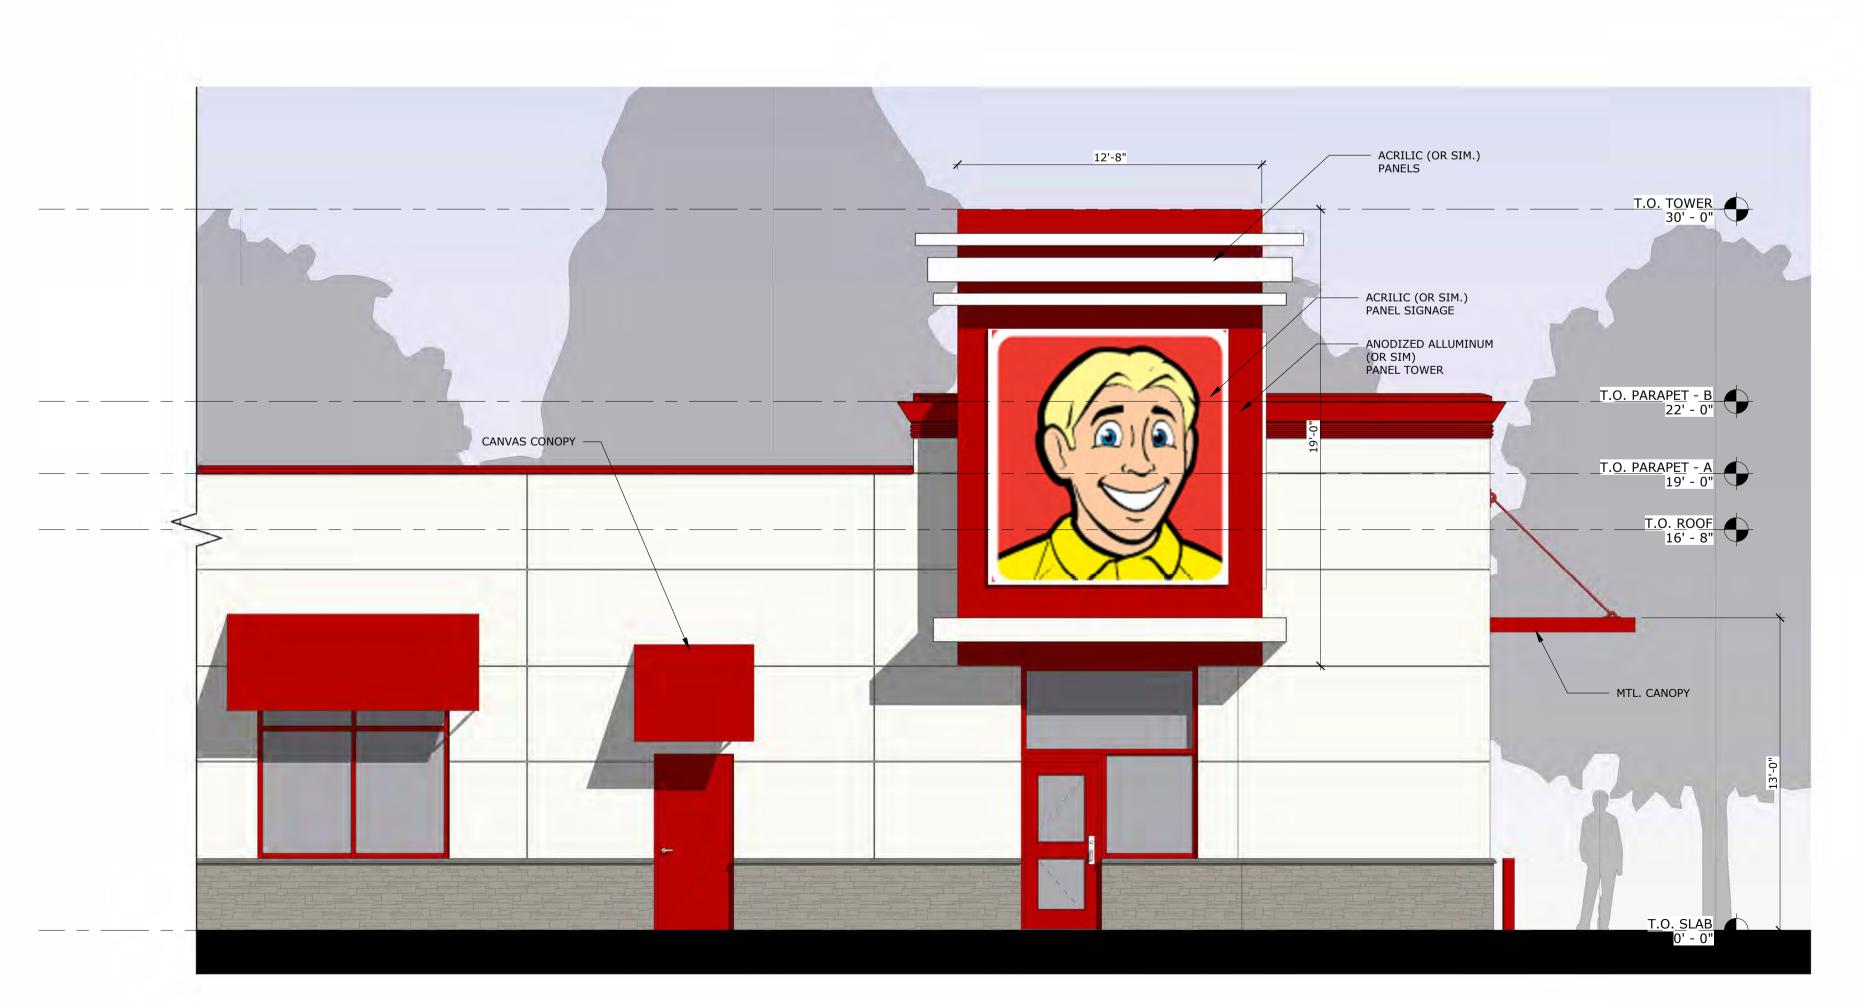

(2) WEST ELEVATION - B
1/4" = 1'-0"

(1) WEST ELEVATION - A

1/4" = 1'-0"