


PRELIMINARY SUBMISSION

POST ROAD APARTMENTS

2119 POST ROAD

WARWICK, RHODE ISLAND 02886

ASSESSOR'S PLAT 323 LOT 523

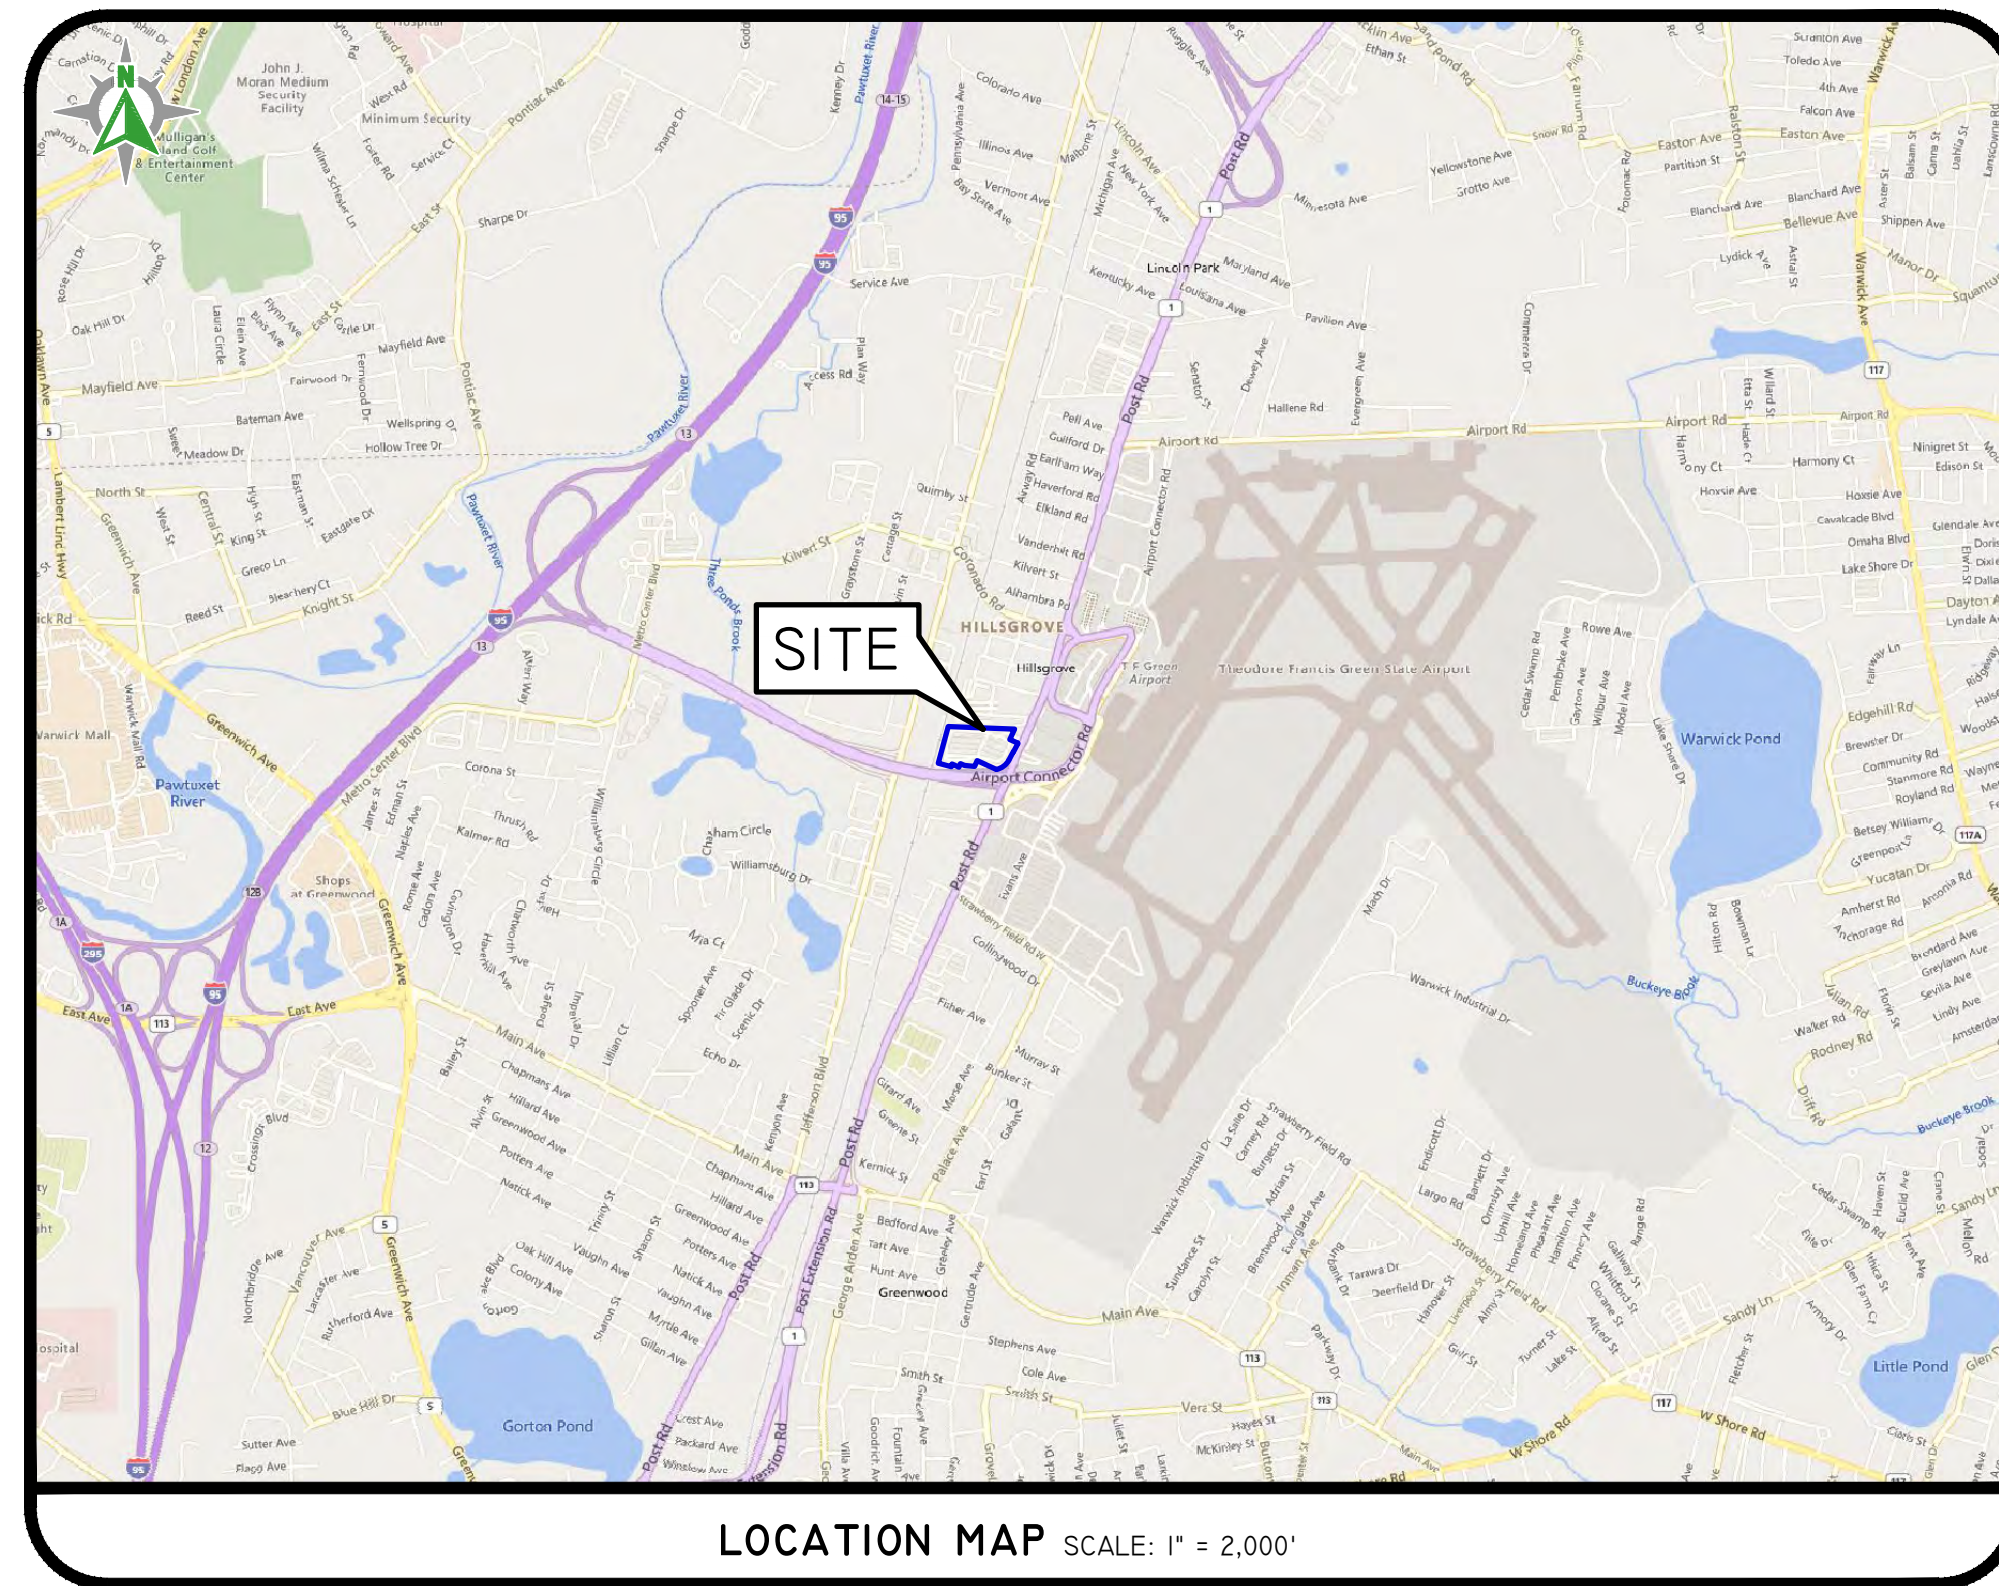

SHEET LIST TABLE

- 1 COVER SHEET
- 2 AERIAL HALF-MILE RADIUS & USGS MAP
- 3 NOTES AND LEGEND
- 4 EXISTING CONDITIONS PLAN
- 5 SOIL EROSION & SEDIMENT CONTROL PLAN
- 6 SITE LAYOUT PLAN
- 7 GRADING & DRAINAGE PLAN
- 8 UTILITIES PLAN
- 9 UNDERGROUND INFILTRATION SYSTEM - A
- 10 UNDERGROUND INFILTRATION SYSTEM - B
- 11 UNDERGROUND INFILTRATION SYSTEM - C
- 12 UNDERGROUND INFILTRATION SYSTEM - D
- 13 UNDERGROUND INFILTRATION SYSTEM - E
- 14 DETAIL SHEET - 1
- 15 DETAIL SHEET - 2
- 16 LANDSCAPE PLAN
- 17 LANDSCAPE NOTES & DETAILS

SESC / O&M
 THE SOIL EROSION AND SEDIMENT CONTROL PLAN (SESC) AND STORMWATER OPERATION AND MAINTENANCE PLAN (O&M) ARE REQUIRED DOCUMENTS WITH THIS PLAN SET AND MUST BE MAINTAINED BY THE CONTRACTOR AND OWNER ON SITE.

RIDEM / DOT
 THE PROPOSED IMPROVEMENTS WILL NOT INCREASE THE RATE OF STORMWATER RUNOFF ONTO THE STATE HIGHWAY. ALL WORK WITHIN THE STATE RIGHT OF WAY MUST CONFORM TO THE RI STANDARD SPECIFICATIONS, DETAILS, AND ADDENDUMS.

Diprete Engineering

Two Stafford Court Cranston, RI 02920
 tel 401-943-1000 fax 401-664-6006 www.diprete-eng.com

Boston • Providence • Newport

BRANDON D. CARR

 REGISTERED PROFESSIONAL ENGINEER
 CIVIL


THIS PLAN SET MUST NOT BE USED FOR CONSTRUCTION PURPOSES WITHOUT THE APPROVAL OF A REGISTERED PROFESSIONAL ENGINEER OF DIPRETE ENGINEERING.

DIPRETE ENGINEERING ON BEHALF OF SKYDRA PLANNING AND DESIGN, A REGISTERED PROFESSIONAL ENGINEER OF DIPRETE ENGINEERING, IS PROVIDING PROFESSIONAL ENGINEERING SERVICES TO SKYDRA DEVELOPMENT, INC. FOR THE PRELIMINARY SUBMISSION OF THE PROPOSED POST ROAD APARTMENTS.

THE CONTRACTOR IS RESPONSIBLE FOR ALL OF THE MEASUREMENTS, SURVEYING, METHODS, SAFETY, PRECAUTIONS AND REQUIREMENTS, AND OSHA COMPLIANCE IN THE IMPLEMENTATION OF THIS PLAN AND DESIGN. EXISTING UTILITIES SHOWN ON THIS PLAN ARE APPROXIMATE AND NOT TO BE RELIED UPON FOR CONSTRUCTION PURPOSES. DAMAGE TO EXISTING UTILITIES SHALL BE THE RESPONSIBILITY OF THE CONTRACTOR. SEE UTILITY NOTE ON SHEET 3.


NO.	DATE	DESCRIPTION	BY
7	05-24-2024	PRELIMINARY SUBMISSION	J.A.R.
8	05-20-2024	RESPONSE TO RFI COMMENTS	J.A.R.
9	05-20-2024	REVISION TO PRELIMINARY SUBMISSION	J.A.R.
10	05-20-2024	REVISION TO PRELIMINARY SUBMISSION	J.A.R.
11	05-20-2024	REVISION TO PRELIMINARY SUBMISSION	J.A.R.
12	05-20-2024	REVISION TO PRELIMINARY SUBMISSION	J.A.R.
13	05-20-2024	REVISION TO PRELIMINARY SUBMISSION	J.A.R.
14	05-20-2024	REVISION TO PRELIMINARY SUBMISSION	J.A.R.
15	05-20-2024	REVISION TO PRELIMINARY SUBMISSION	J.A.R.
16	05-20-2024	REVISION TO PRELIMINARY SUBMISSION	J.A.R.
17	05-20-2024	REVISION TO PRELIMINARY SUBMISSION	J.A.R.

COVER SHEET
POST ROAD APARTMENTS
 ASSESSOR'S PLAT 323 LOT 523
 WARWICK, RHODE ISLAND
 PREPARED FOR:
SKYDRA DEVELOPMENT
 858 WASHINGTON STREET, SUITE #305, DEDHAM, MA 02026
 TEL 781-451-5600
 DRAWN BY: J.A.R. DESIGN BY: F.Y.A.

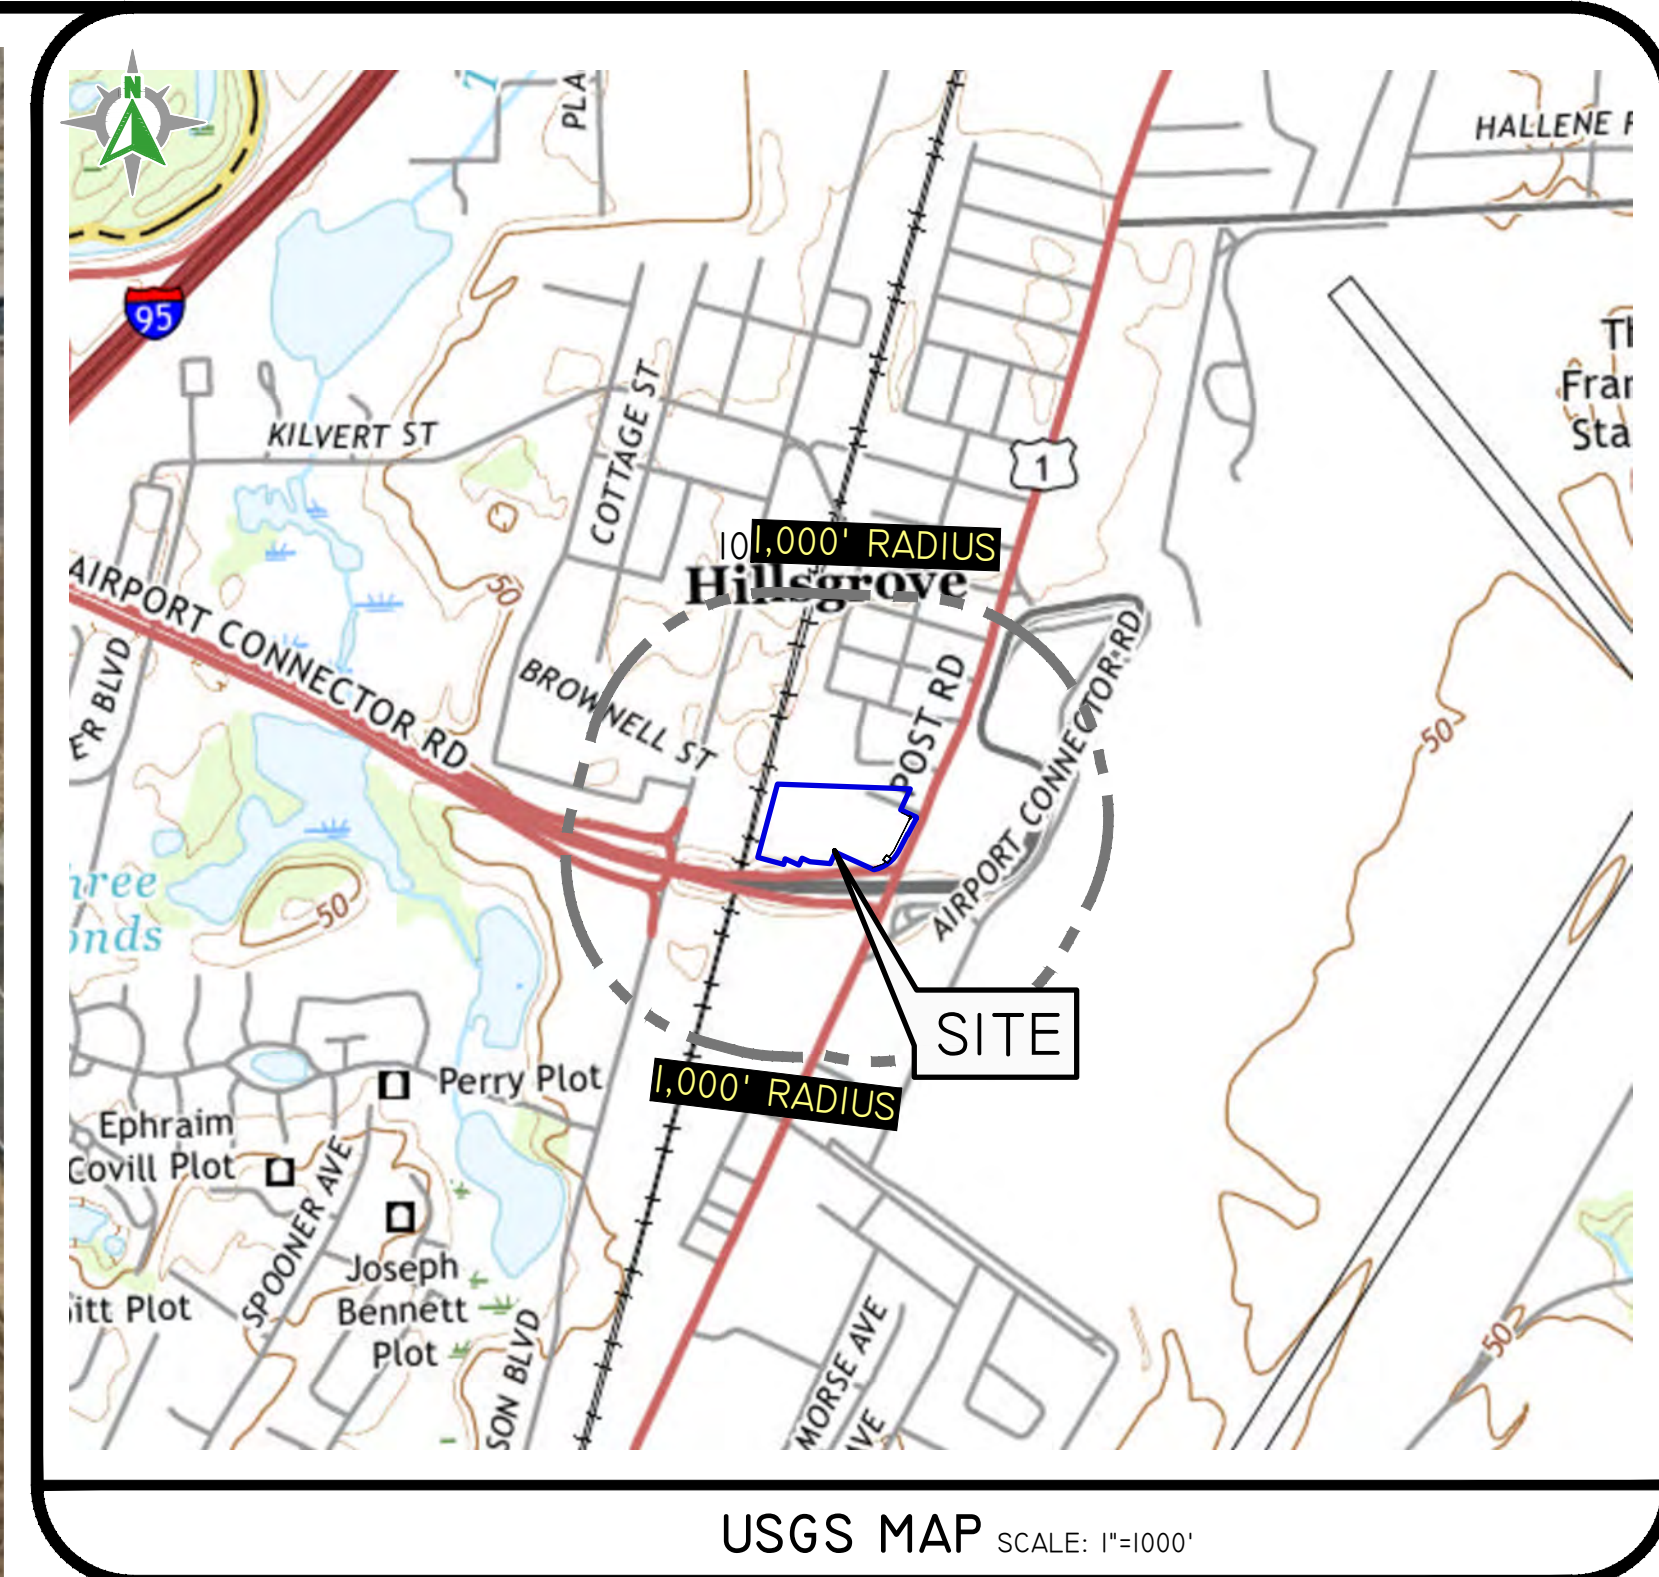

USGS MAP SCALE: 1"=1000'

PHOTO OBTAINED FROM NEARMAP.
DATE OF PHOTOGRAPHY 04/22/2022.

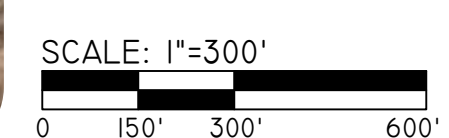

Diprete Engineering
Two Stafford Court Cranston, RI 02920
tel 401-943-1000 fax 401-644-6006 www.diprete-eng.com

BRANDON D. CARR
[Signature]
9801
REGISTERED PROFESSIONAL ENGINEER
CIVIL

THIS PLAN SET MUST NOT BE USED FOR CONSTRUCTION PURPOSES UNLESS APPROVED BY THE REGISTERED PROFESSIONAL ENGINEER OF DIPRETE ENGINEERING.

DIPRETE ENGINEERING ON STARBUCKS PLATS DOES NOT WARRANT THE ACCURACY OF THE INFORMATION PROVIDED HEREIN. THE CONTRACTOR IS RESPONSIBLE FOR ALL OF THE MEASUREMENTS, METHODS, SAFETY PRECAUTIONS AND REQUIREMENTS, AND OSHA COMPLIANCE IN THE IMPLEMENTATION OF THIS PLAN AND DESIGN.

EXISTING UTILITIES SHOWN ON THIS PLAN ARE APPROXIMATE. DAMAGE TO EXISTING UTILITIES OCCURRING AS A RESULT OF CONSTRUCTION SHALL BE THE RESPONSIBILITY OF THE CONTRACTOR. SEE UTILITY NOTE ON SHEET 1.


NO.	DATE	DESCRIPTION	BY:
1	05-24-2023	PRELIMINARY SUBMISSION	J.A.R.
2	05-20-2023	RESPONSE TO RFI COMMENTS	J.A.R.
3	05-22-2023	FINAL SUBMISSION	J.A.R.

DESIGN BY: J.A.R.

AERIAL HALF-MILE RADIUS & USGS MAP
POST ROAD APARTMENTS
WARWICK, RHODE ISLAND

PREPARED FOR:
SKYDRA DEVELOPMENT
658 WASHINGTON STREET, SUITE #305, DEDHAM, MA 02026
TEL 781-451-5600

Z:\DEMAN\PROJECTS\2625-08 POST ROAD 2109\AUTOCAD DRAWINGS\2625-08-CVAR.DWG PLOTTED: 5/24/2023

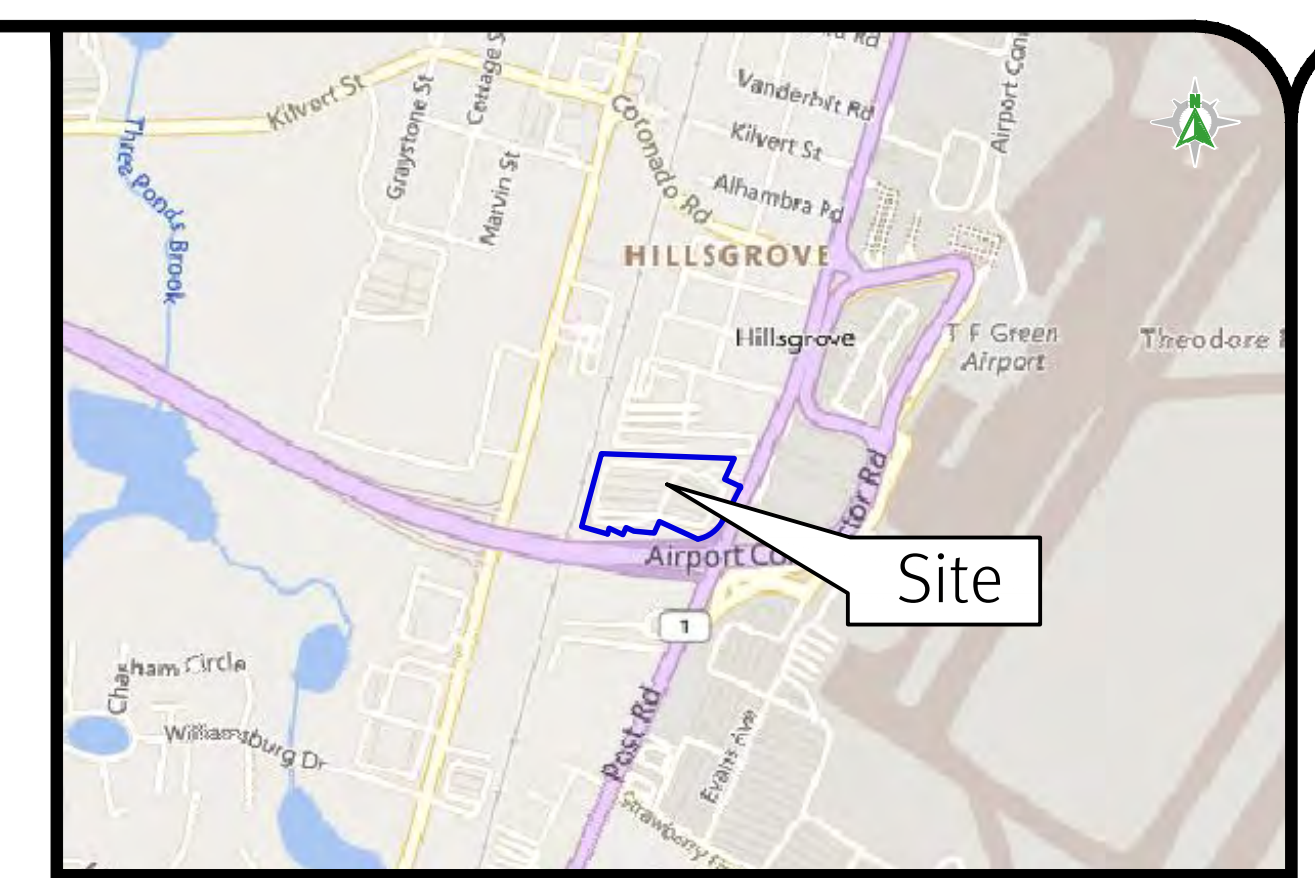

LOCUS MAP Not To Scale

LEGEND

Legend table with symbols for utility lines (Water, Sewer, Gas, Electric, etc.), property lines, and other features.

GENERAL NOTES

- 1. THE PARCEL IS FOUND ON ASSESSOR'S PLAT 323, LOT 523 IN THE CITY OF WARWICK, KENT COUNTY, RHODE ISLAND.
2. THE OWNER PER DEED BOOK 8671, PAGE 199 IS RHODE ISLAND AIRPORT CORPORATION.
3. THIS SITE IS LOCATED IN FEMA FLOOD ZONE X. REFERENCE FEMA FLOOD INSURANCE RATE MAP 44002C0127H, MAP REVISED OCTOBER 2, 2015. THIS DESIGNATION MAY CHANGE BASED UPON REVIEW BY A FLOOD ZONE SPECIALIST OR BY THE RESULTS OF A COMPREHENSIVE FLOOD STUDY.
4. THE PARCEL IS ZONED INTERMODAL (IM) PER DECISION RECORDED IN DEED BOOK 1052, PAGE 296. ANY OVERLAY DISTRICTS, SPECIAL PERMITS OR VARIANCES SPECIFIC TO THIS SITE ARE NOT TAKEN INTO CONSIDERATION. PLEASE CONTACT THE ZONING DEPARTMENT FOR ANY ADDITIONAL INFORMATION OR FOR A CERTIFICATE OF ZONING.
5. THERE WERE NO CEMETERIES, GRAVE SITES AND OR BURIAL GROUNDS OBSERVED WITHIN THE LIMITS OF THE SURVEY.
6. FIELD SURVEY PERFORMED BY DIPRETE ENGINEERING IN 2016 AND MARCH 31, 2022. THIS PLAN REFLECTS ON THE GROUND CONDITIONS AS OF THAT DATE.
7. ELEVATIONS SHOWN HEREON, IN U.S. SURVEY FEET, ARE REFERENCED TO THE NORTH AMERICAN VERTICAL DATUM OF 1988 (NAVD 88), AS DETERMINED BY DIPRETE ENGINEERING USING REAL TIME KINEMATIC G.P.S. OBSERVATIONS.
8. THE SITE IS WITHIN A:
GROUNDWATER RESERVOIR AREA (RIDEM)
NATURAL HERITAGE AREA (RIDEM)

PLAN REFERENCES

- 1. HILLS GROVE CENTER NO.2, WARWICK R.I., BELONGING TO THE PROVIDENCE REAL ESTATE IMPROVEMENT CO., SCALE 1"=80', DATED SEPTEMBER, 1927, PLAN BY WATERMAN ENGINEERING CO., RECORDED ON PLAT CARD 347.
2. PROPERTY LINE PLAN ASSESSOR'S PLAT 323 PAT CARD 347, HILLGROVE SOUTH SUBDIVISION, PLAN BY VHB, DATED NOVEMBER 4, 1998, RECORDED IN PLAT BOOK 21, PLAN 16-17.
3. ADMINISTRATIVE SUBDIVISION, RADISSON PROVIDENCE AIRPORT PLAT, AP 323, LOTS 294, 295, 296, 297, 298, 319, 322, & 323, WARWICK, RHODE ISLAND, SCALE 1"=60', DATED JULY 14, 2019, PLAN BY DIPRETE ENGINEERING, RECORDED IN PLAT CARD 1677.
4. RHODE ISLAND HIGHWAY PLATS 1220, 1573, 2331 & 2335-A.

UTILITY NOTES

- 1. ALL EXISTING UTILITIES DEPICTED ARE SHOWN ACCORDANCE WITH UTILITY QUALITY LEVEL C AS DEFINED IN CIBASCE STANDARD 38-02 (STANDARD GUIDELINES FOR THE COLLECTION AND DEPICTION OF EXISTING SUBSURFACE UTILITY DATA), LATEST REVISION.
2. ALL EXISTING UNDERGROUND UTILITIES SHOWN WERE PROVIDED BY OTHERS AND ARE APPROXIMATE ONLY. LOCATIONS MUST BE DETERMINED IN THE FIELD BEFORE EXCAVATION, BLASTING, UTILITY INSTALLATION, BACKFILLING, GRADING, PAVEMENT RESTORATION, AND ALL OTHER SITE WORK. ALL UTILITY COMPANIES, PUBLIC AND PRIVATE, MUST BE CONTACTED INCLUDING THOSE IN CONTROL OF UTILITIES NOT SHOWN ON THESE DOCUMENTS. CONTACT DIG SAFE A MINIMUM OF 72 WORKING HOURS PRIOR TO ANY CONSTRUCTION AT 811. DIG SAFE IS RESPONSIBLE FOR CONTACTING MEMBER UTILITY COMPANIES. DIG SAFE MEMBER UTILITY COMPANIES ARE RESPONSIBLE TO MARK ONLY THE FACILITIES THAT THEY OWN OR MAINTAIN. NON DIG SAFE MEMBER COMPANIES ARE NOT NOTIFIED BY DIG SAFE. IT IS THE CONTRACTOR'S RESPONSIBILITY TO INVESTIGATE AND NOTIFY IF ANY PRIVATELY OWNED OR NON DIG SAFE MEMBER UTILITIES ARE IN THE AREA.
3. PER THE CODE OF FEDERAL REGULATIONS - TITLE 29, PART 1926 IT IS THE SITE CONTRACTOR'S RESPONSIBILITY TO OBTAIN ACCURATE UNDERGROUND UTILITY LINE LOCATIONS FROM THE UTILITY COMPANIES, UTILITY OWNERS AND, OR VIA UNDERGROUND UTILITY LOCATION EQUIPMENT AS NEEDED TO ESTABLISH ACCURATE LOCATIONS PRIOR TO ANY EXCAVATION. THE USE OF PROFESSIONAL UTILITY LOCATING COMPANIES PRIOR TO ANY EXCAVATION IS RECOMMENDED.
4. DIPRETE ENGINEERING IS NOT A PROFESSIONAL UTILITY LOCATION COMPANY, AND IS NOT RESPONSIBLE FOR UNDERGROUND UTILITIES, DEPICTED OR NOT, EITHER IN SERVICE OR ABANDONED, ANY SIZES, LOCATIONS, EXISTENCE, OR LACK OF EXISTENCE OF UTILITIES SHOWN ON THESE PLANS SHOULD BE CONSIDERED APPROXIMATE UNTIL VERIFIED BY A PROFESSIONAL UTILITY LOCATION COMPANY. DIPRETE ENGINEERING ASSUMES NO RESPONSIBILITY FOR DAMAGES INCURRED.
5. UTILITY PLAN REFERENCES
5.1. WATER INFORMATION OBTAINED FROM THE CITY OF WARWICK.
5.2. SEWER INFORMATION OBTAINED ON THE GROUND BY DIPRETE ENGINEERING (SEE GENERAL NOTES FOR DATE OF FIELD SURVEY) AND FROM THE CITY OF WARWICK.
5.3. GAS INFORMATION OBTAINED FROM NATIONAL GRID.
5.4. DRAINAGE INFORMATION OBTAINED ON THE GROUND BY DIPRETE ENGINEERING. (SEE GENERAL NOTES FOR DATE OF FIELD SURVEY)

SURVEYOR'S CERTIFICATE

THIS SURVEY HAS BEEN CONDUCTED AND THE PLAN HAS BEEN PREPARED PURSUANT TO 435-RICR-00-00-19 OF THE RULES AND REGULATIONS ADOPTED BY THE RHODE ISLAND STATE BOARD OF REGISTRATION FOR PROFESSIONAL LAND SURVEYORS ON NOVEMBER 25, 2015, AS FOLLOWS:
CLASS I COMPREHENSIVE BOUNDARY SURVEY
CLASS III DATA ACCUMULATION SURVEY
CLASS T-2 TOPOGRAPHIC SURVEY
THE PURPOSE FOR THE CONDUCT OF THE SURVEY AND FOR THE PREPARATION OF THE PLAN IS AS FOLLOWS: PERIMETER RETRACEMENT WITH TOPOGRAPHY FOR SITE ENGINEERING AND PERMITTING.

Professional Land Surveyor seal for Robert G. Babcock, No. 2504, dated 01-20-2023.


Signature of Robert G. Babcock and contact information: ROBERT G. BABCOCK, RIPLS #2504, COA #LS.000A160


Z:\DEPMAN\PROJECTS\2025-08 POST ROAD 21P\AUTOCAD DRAWINGS\2504-01E-CO DWG PLATTER 3/20/2023

Professional Engineer seal for Brandon D. Carr, No. 9801, dated 08-01-2022.

Diprete Engineering logo and contact information: Two Stafford Court, Cranston, RI 02920, tel 401-943-1000, fax 401-464-6006, www.diprete-eng.com

EXISTING CONDITIONS PLAN Post Road Apartments, Assessor's Plat 323 Lot 523, Warwick, Rhode Island. Prepared for Skydra Development, 888 Washington Street, Suite #505, Dedham, MA 02026, Tel 781-451-5600.

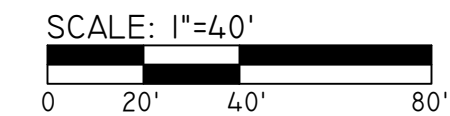

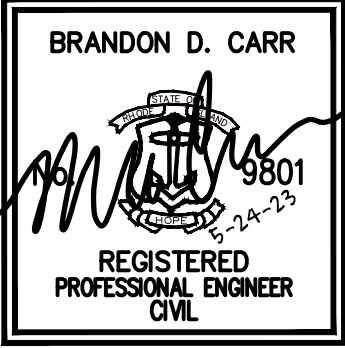

THIS PLAN SET MUST NOT BE USED FOR CONSTRUCTION PURPOSES UNLESS IT IS ACCOMPANIED BY THE STAMPED AND SIGNED PROFESSIONAL ENGINEER'S SEAL AND SIGNATURE OF A REGISTERED PROFESSIONAL ENGINEER OF DIPRETE ENGINEERING.

DIPRETE ENGINEERING ON STARBOARD PLANS DOES NOT WARRANT THE ACCURACY OF THE INFORMATION PROVIDED HEREON. THE CONTRACTOR IS RESPONSIBLE FOR ALL OF THE MEASUREMENTS, METHODS, SAFETY PRECAUTIONS AND REQUIREMENTS AND OSHA DESIGN. DIPRETE ENGINEERING IS NOT RESPONSIBLE FOR THE DESIGN. EXISTING UTILITIES SHOWN ON THIS PLAN ARE APPROXIMATE AND NOT TO BE RELIED UPON FOR CONSTRUCTION PURPOSES. SEE UTILITY NOTES ON SHEET 13.

NO.	DATE	DESCRIPTION	BY	CHKD
1	05-24-2024	PRELIMINARY SUBMISSION	J.A.R.	J.A.R.
2	05-24-2024	RESPONSE TO RFI COMMENTS	J.A.R.	J.A.R.
3	05-24-2024	FINAL SUBMISSION	J.A.R.	J.A.R.

DESIGN BY: F.V.A.
DRAWN BY: J.A.R.


SOIL EROSION & SEDIMENT CONTROL PLAN

POST ROAD APARTMENTS
ASSESSOR'S PLAT 323 LOT 523
WARWICK, RHODE ISLAND

PREPARED FOR:
SKYDRA DEVELOPMENT
858 WASHINGTON STREET, SUITE #305, DEDHAM, MA 02026
TEL 781-451-5600

SOIL EROSION CONTROL LEGEND

- EROSION CONTROL (COMPOST SOCK, SILT FENCE (RI STD 9.2.0, OR APPROVED EQUAL))
- LIMIT OF DISTURBANCE (NO SEDIMENT CONTROL)
- LIMIT OF DISTURBANCE (WITH SEDIMENT CONTROL)
- CONSTRUCTION ACCESS (RIDOT STD 9.9.0)
- INFILTRATING AREA (TO BE PROTECTED BY COMPOST SOCK OR SILT FENCE)
- FINAL CONTOUR GRADE
- INLET SEDIMENT CONTROL

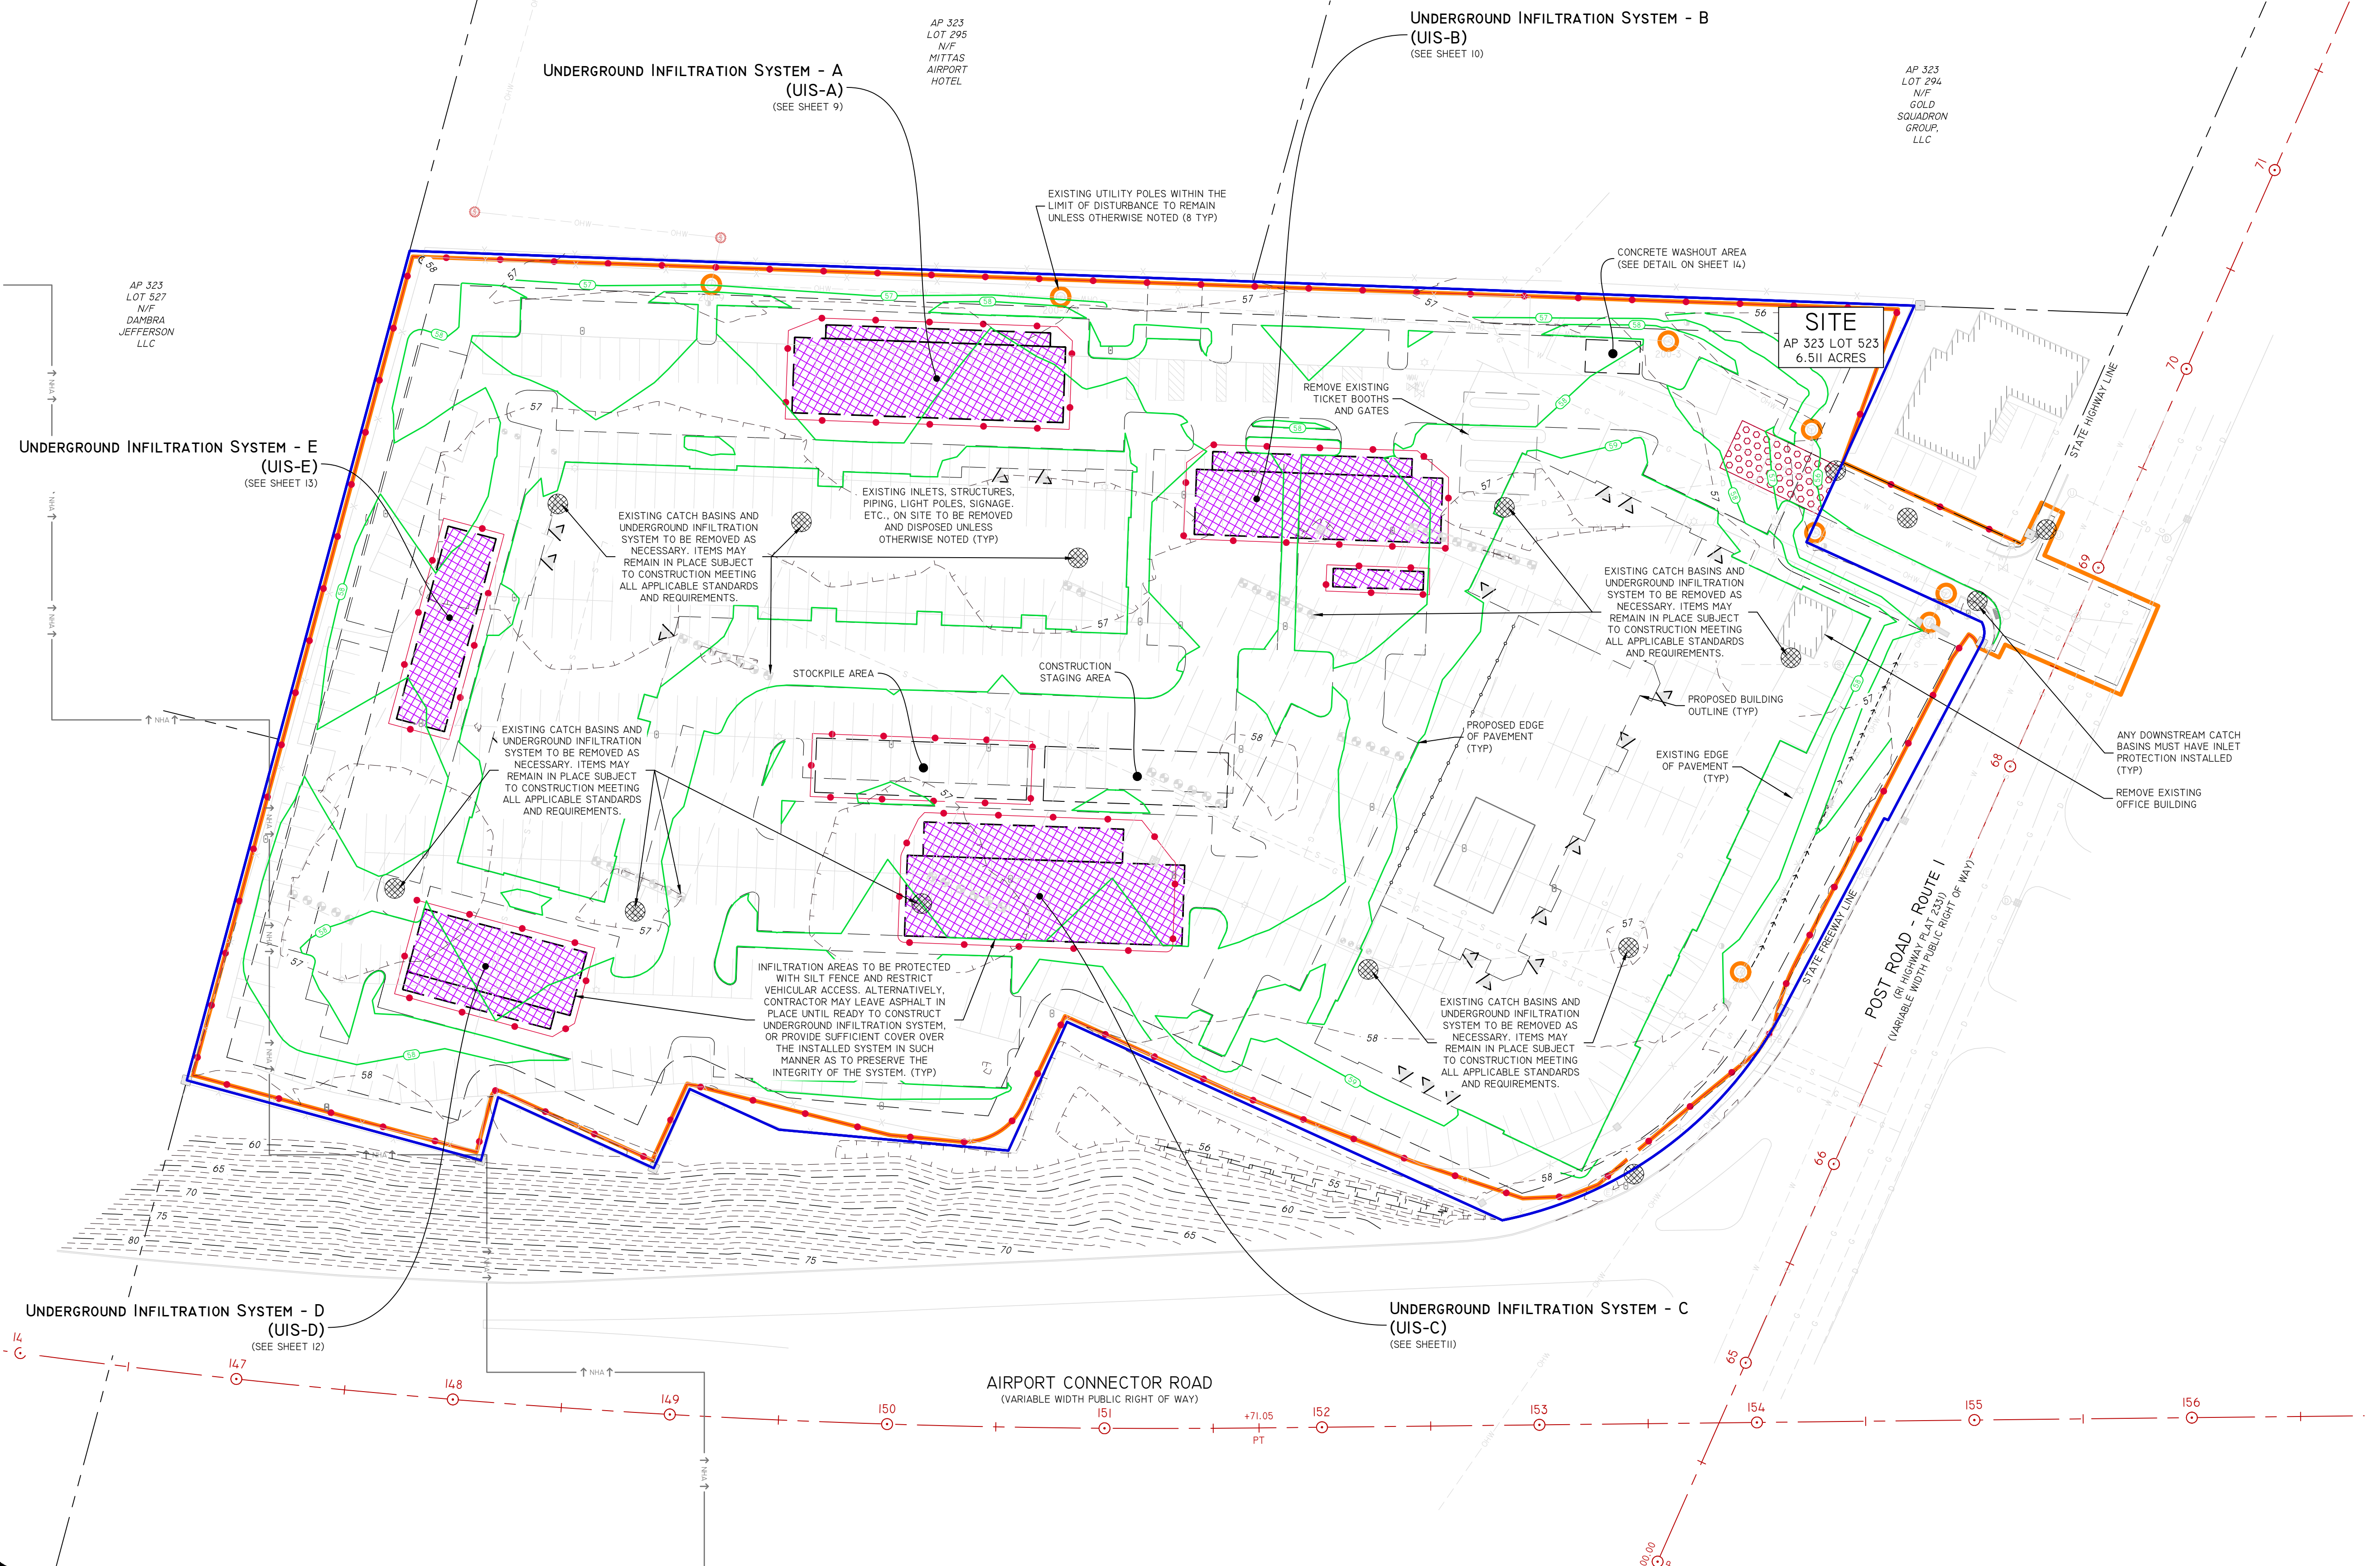

Z:\DEMAN\PROJECTS\2625-08 POST ROAD 2109\AUTOCAD DRAWINGS\2625-08-PLAN.DWG PLOT# 5/24/2025



DEVELOPMENT DATA:

TOTAL SITE AREA:	6.51 ACRES
TOTAL NUMBER OF BUILDINGS:	2
TOTAL NUMBER OF UNITS:	210 ONE BEDS 84 TWO BEDS 8 THREE BEDS 210 UNITS TOTAL





DIMENSIONAL REGULATIONS:

CURRENT ZONING:	INTERMODAL (IM) REQUIRED:	PROVIDED:
MINIMUM LOT AREA:	6,000 SF	283,625 SF
MINIMUM FRONTAGE AND LOT WIDTH:	60'	360.8'
MINIMUM FRONT AND CORNER SIDE YARD:	0'	10.1'
MAXIMUM FRONT YARD:	N/A	10.1'
MINIMUM SIDE YARD:	0'	19.4'
MINIMUM REAR YARD:	0'	94.2'
MAXIMUM STRUCTURE HEIGHT:	75'	475'
MINIMUM LANDSCAPE OPEN SPACE:	10%*	31.6%
UNITS PER ACRE:	N/A	-

- *MINIMUM LOT WIDTH:
(1) FOR LOTS FRONTING ON ANY STREET CUL-DE-SAC, BOTH THE MINIMUM FRONTAGE AND LOT WIDTH SHALL BE AT LEAST 80 PERCENT OF THE REQUIREMENTS.
(4) MINIMUM LOT WIDTH: ON CORNER LOTS, THE REQUIRED FRONTAGE AND WIDTH SHALL BE NECESSARY ONLY ON ONE STREET PROVIDED THAT THE SECOND STREET FRONTAGE MAINTAINS THE MINIMUM OF 80 PERCENT OF THE FRONTAGE REQUIREMENT.
- *MINIMUM LANDSCAPED OPEN SPACE:
(5) ALSO SUBJECT TO THE REQUIREMENTS OF SUBSECTION 505.
- *MINIMUM REAR YARD:
(6) ON CORNER LOTS, THE REAR SETBACK SHALL CONFORM TO THE SIDE SETBACK REQUIREMENTS.
- 505.1 MINIMUM LANDSCAPED BUFFER.
A TEN-FOOT-WIDE LANDSCAPED BUFFER SHALL BE PROVIDED ACROSS THE ENTIRE FRONTAGE OF THE LOT EXCEPT FOR ANY CURB CUTS.

PARKING REGULATIONS:

PARKING USE:	MULTI-FAMILY
PARKING REQUIREMENT:	1.5 SPACES PER DWELLING UNIT
ADA PARKING REQUIRED:	8 SPACES
NUMBER OF UNITS:	210 UNITS
REQUIRED PARKING CALCULATIONS:	1.5 x 210 = 315 SPACES
ADA PARKING PROVIDED:	10 SPACES
TOTAL REQUIRED PARKING:	315 SPACES
TOTAL PARKING PROVIDED:	322 SPACES

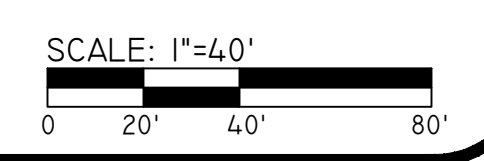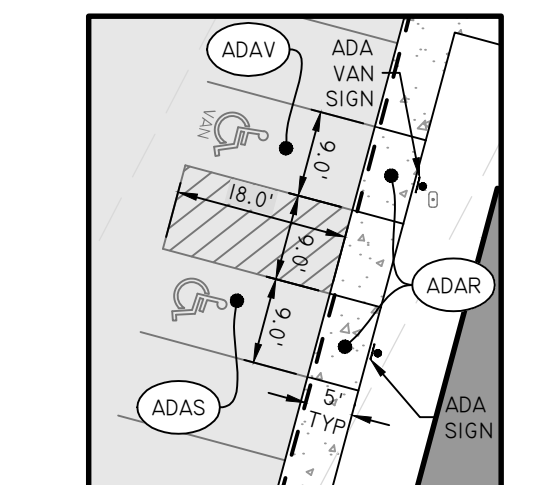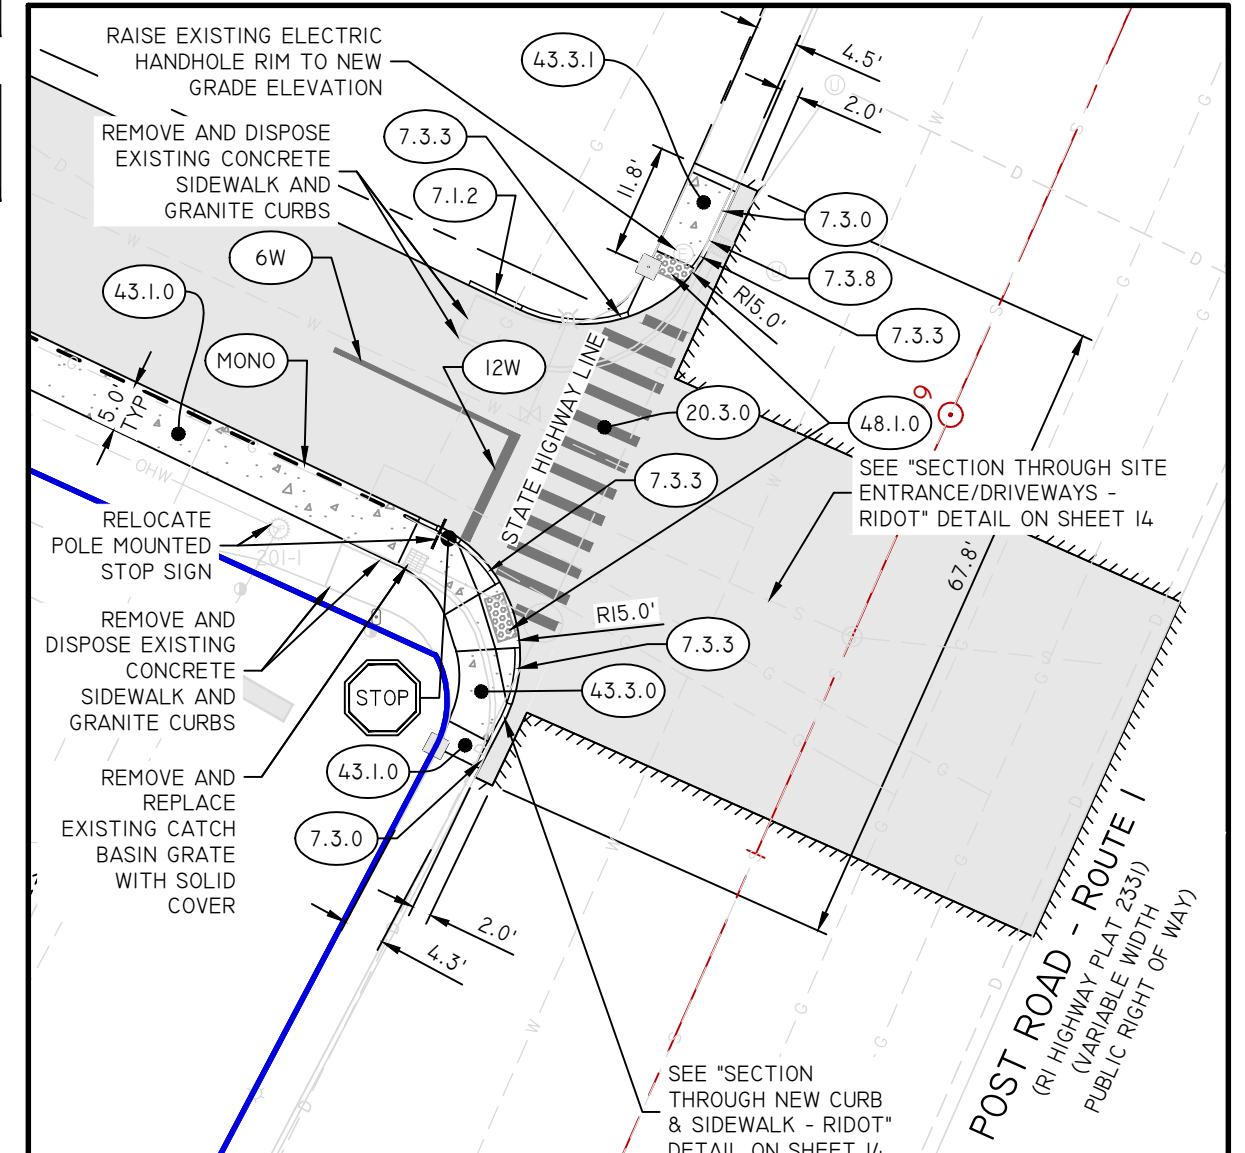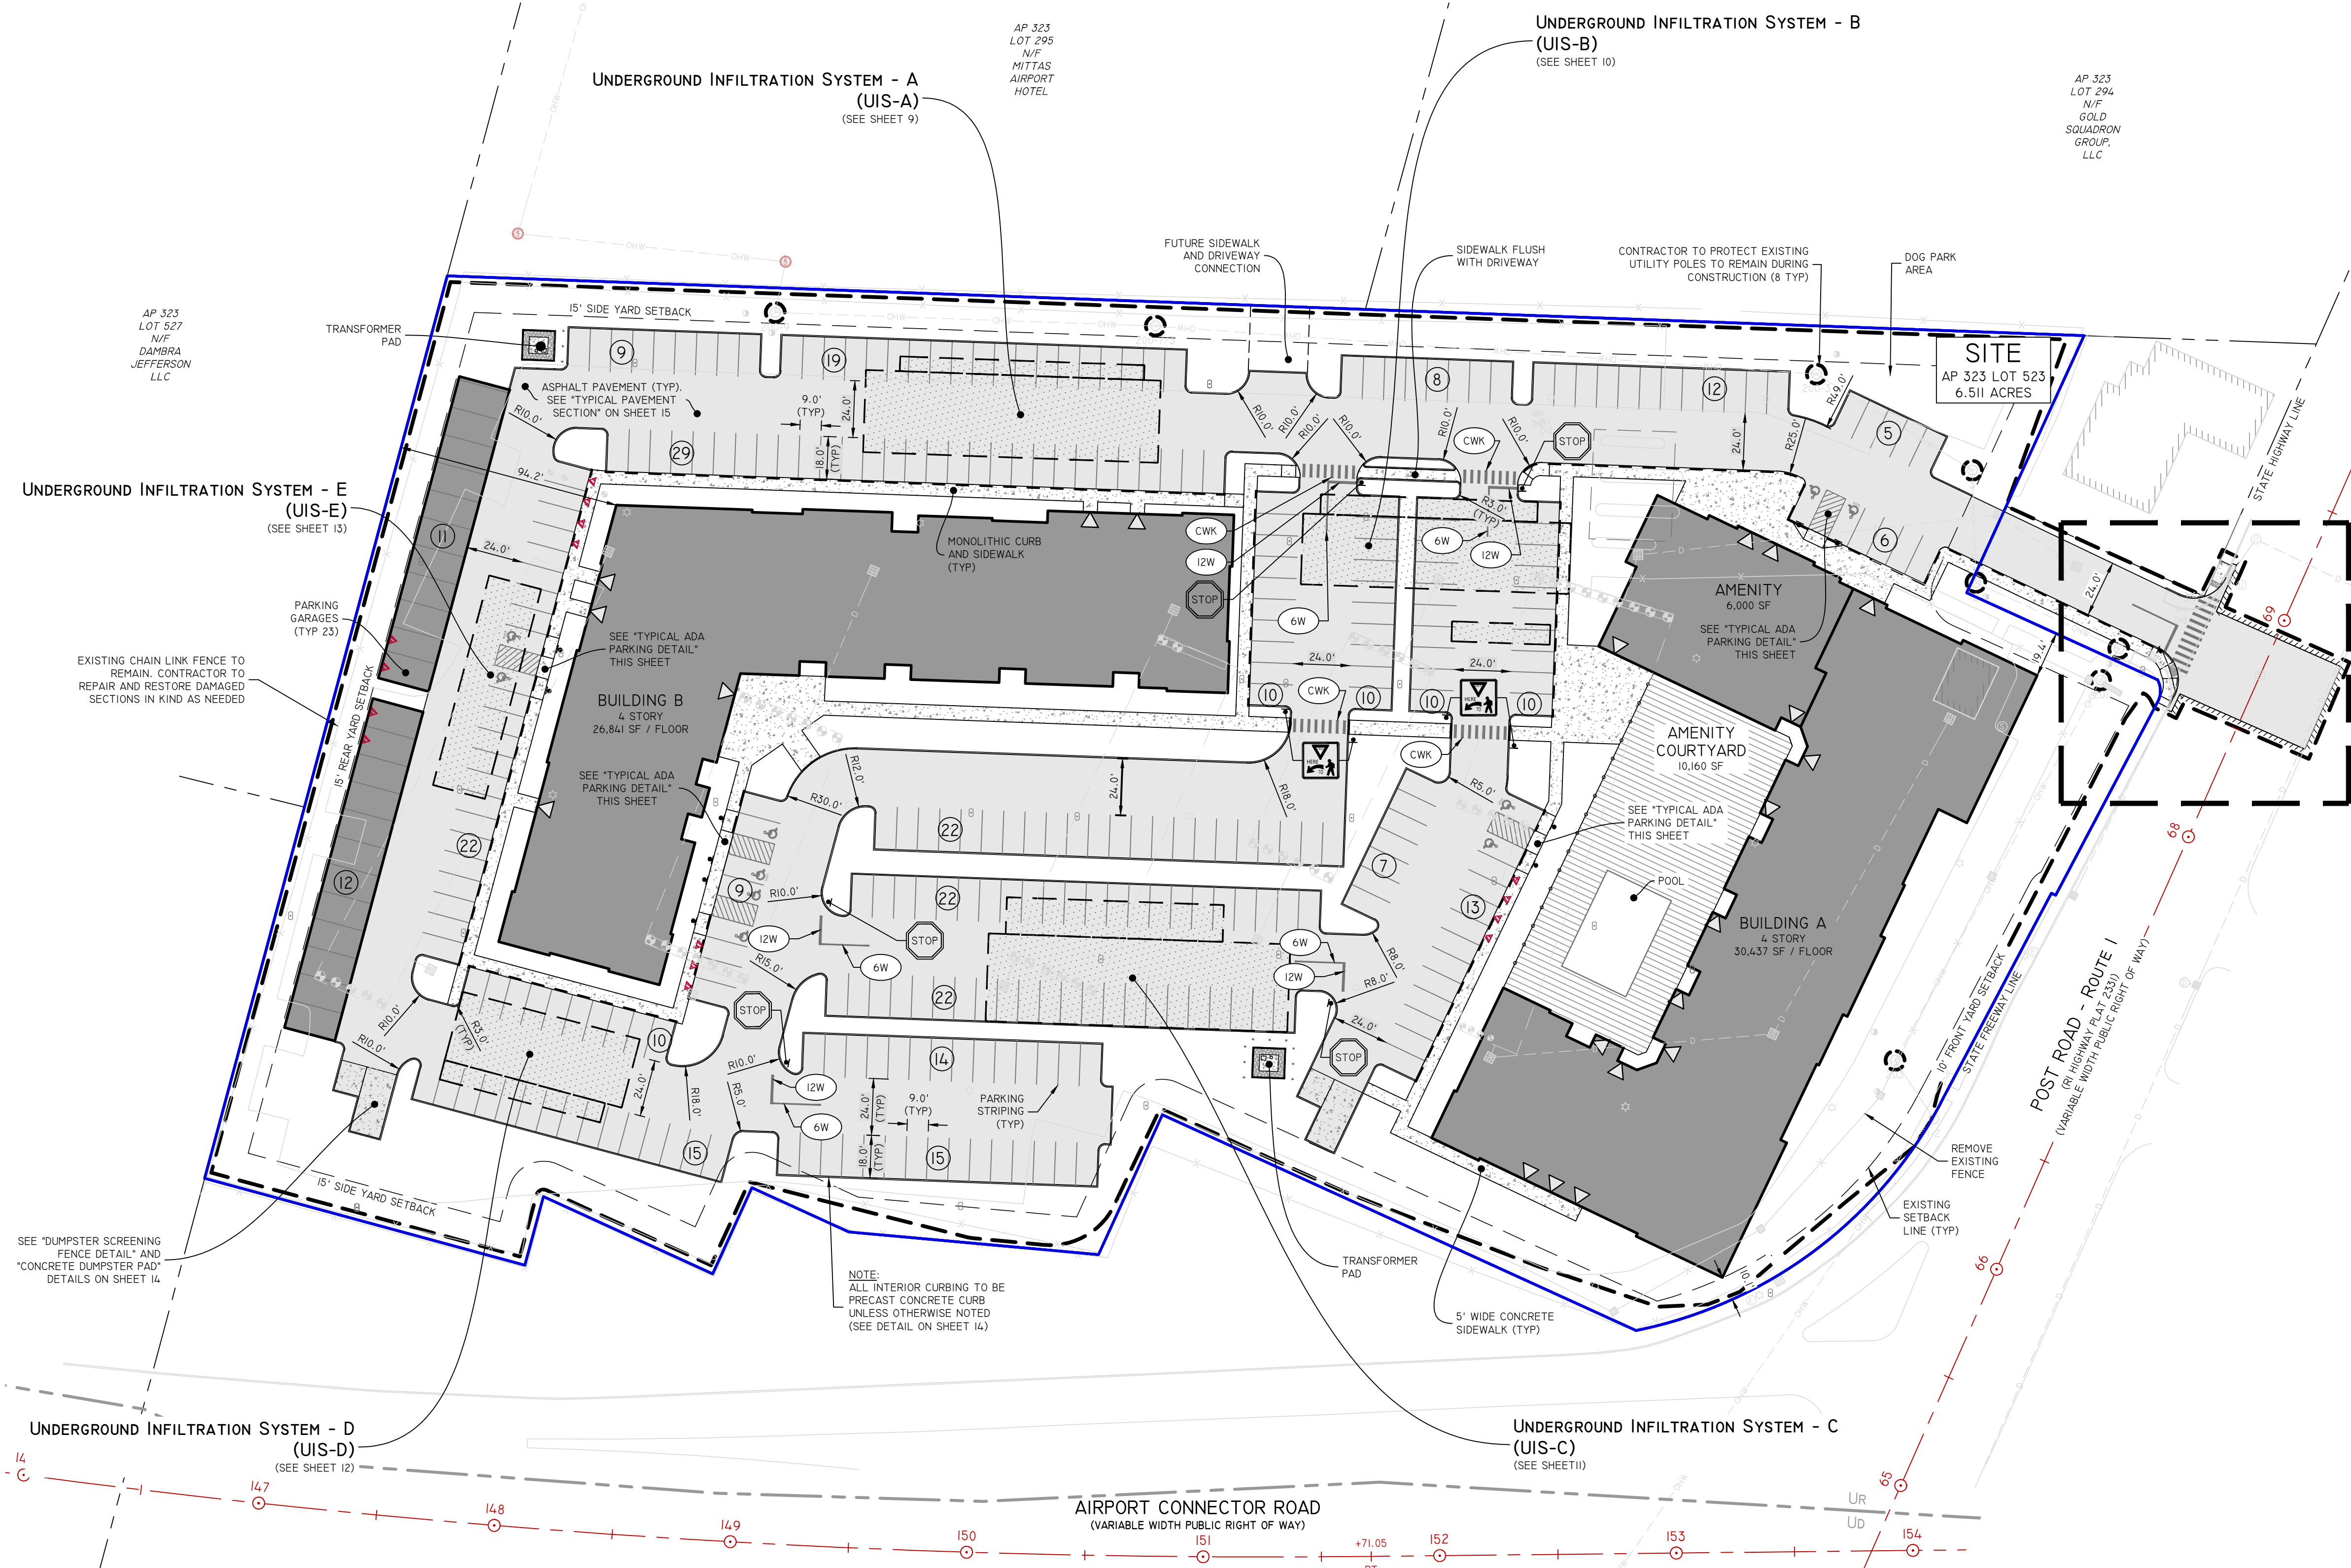


BRANDON D. CARR

 REGISTERED PROFESSIONAL ENGINEER
 CIVIL

THIS PLAN SET IS NOT TO BE USED FOR CONSTRUCTION PURPOSES.
 A REGISTERED PROFESSIONAL ENGINEER OF RHODE ISLAND.
 DIPRETE ENGINEERING, INC., A MEMBER OF THE DIPRETE GROUP.
 REGISTERED PROFESSIONAL ENGINEER OF RHODE ISLAND.
 THE CONTRACTOR IS RESPONSIBLE FOR ALL OF THE MEASUREMENTS, METHODS, SAFETY PRECAUTIONS AND REQUIREMENTS, AND OSHA REGULATIONS, IN THE IMPLEMENTATION OF THIS PLAN AND DESIGN.
 EXISTING UTILITIES SHOWN ON THIS PLAN ARE APPROXIMATE.
 DATE: 05/24/2024
 DRAWN BY: J.A.R. DESIGN BY: F.Y.A.
 CHECKED BY: J.A.R.
 REVIEWED BY: R.B.T.
 DATE: 05/24/2024
 DESCRIPTION: SKYDRA DEVELOPMENT

SITE LAYOUT PLAN
POST ROAD APARTMENTS
 ASSESSOR'S PLAT 323 LOT 523
 WARWICK, RHODE ISLAND
 PREPARED FOR:
SKYDRA DEVELOPMENT
 888 WASHINGTON STREET, SUITE #505, DEHAY, MA 02026
 TEL 781-431-5600



Z:\DEVELOPMENT\PROJECTS\02425-08 POST ROAD 210P\AUTOCAD DRAWINGS\02425-08P-PLAN.DWG PLOT DATE: 5/24/2024

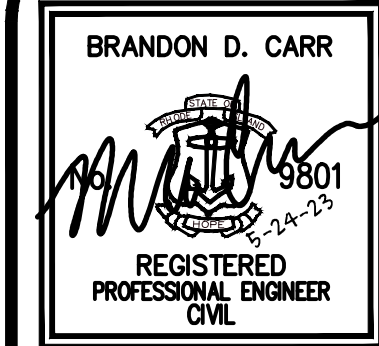

THIS PLAN SET IS NOT TO BE USED FOR CONSTRUCTION PURPOSES UNLESS IT IS APPROVED BY A REGISTERED PROFESSIONAL ENGINEER OF DIPRETE ENGINEERING.
DIPRETE ENGINEERING ONLY WARRANTS THE PLANS ON A DIPRETE PROFESSIONAL ENGINEER OF DIPRETE ENGINEERING, CRANSTON, RHODE ISLAND. THE CONTRACTOR IS RESPONSIBLE FOR ALL OF THE NECESSARY METHODS, SAFETY PRECAUTIONS AND REQUIREMENTS AND OSHA DESIGN. EXISTING UTILITIES SHOWN ON THIS PLAN ARE APPROXIMATE. DIPRETE ENGINEERING ASSUMES NO RESPONSIBILITY FOR DATA. SEE UTILITY NOTE ON SHEET 3.
DESIGN BY: J.A.R.

NO.	DATE	DESCRIPTION	BY
1	05-24-2023	PRELIMINARY SUBMISSION	J.A.R.
2	05-30-2023	RESPONSE TO RFI COMMENTS	J.A.R.
3	06-29-2023	REVISION	J.A.R.
4	07-20-2023	REVISION	J.A.R.
5	08-01-2023	REVISION	J.A.R.

GRADING & DRAINAGE PLAN
POST ROAD APARTMENTS
ASSESSOR'S PLAT 323 LOT 523
WARWICK, RHODE ISLAND
PREPARED FOR:
SKYDRA DEVELOPMENT
888 WASHINGTON STREET, SUITE #505, DEBHAM, MA 02026
TEL 781-441-5150
DE JOB NO. 2852-88-80V COPYRIGHT 2023 BY DIPRETE ENGINEERING ASSOCIATES, INC.

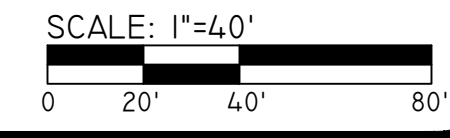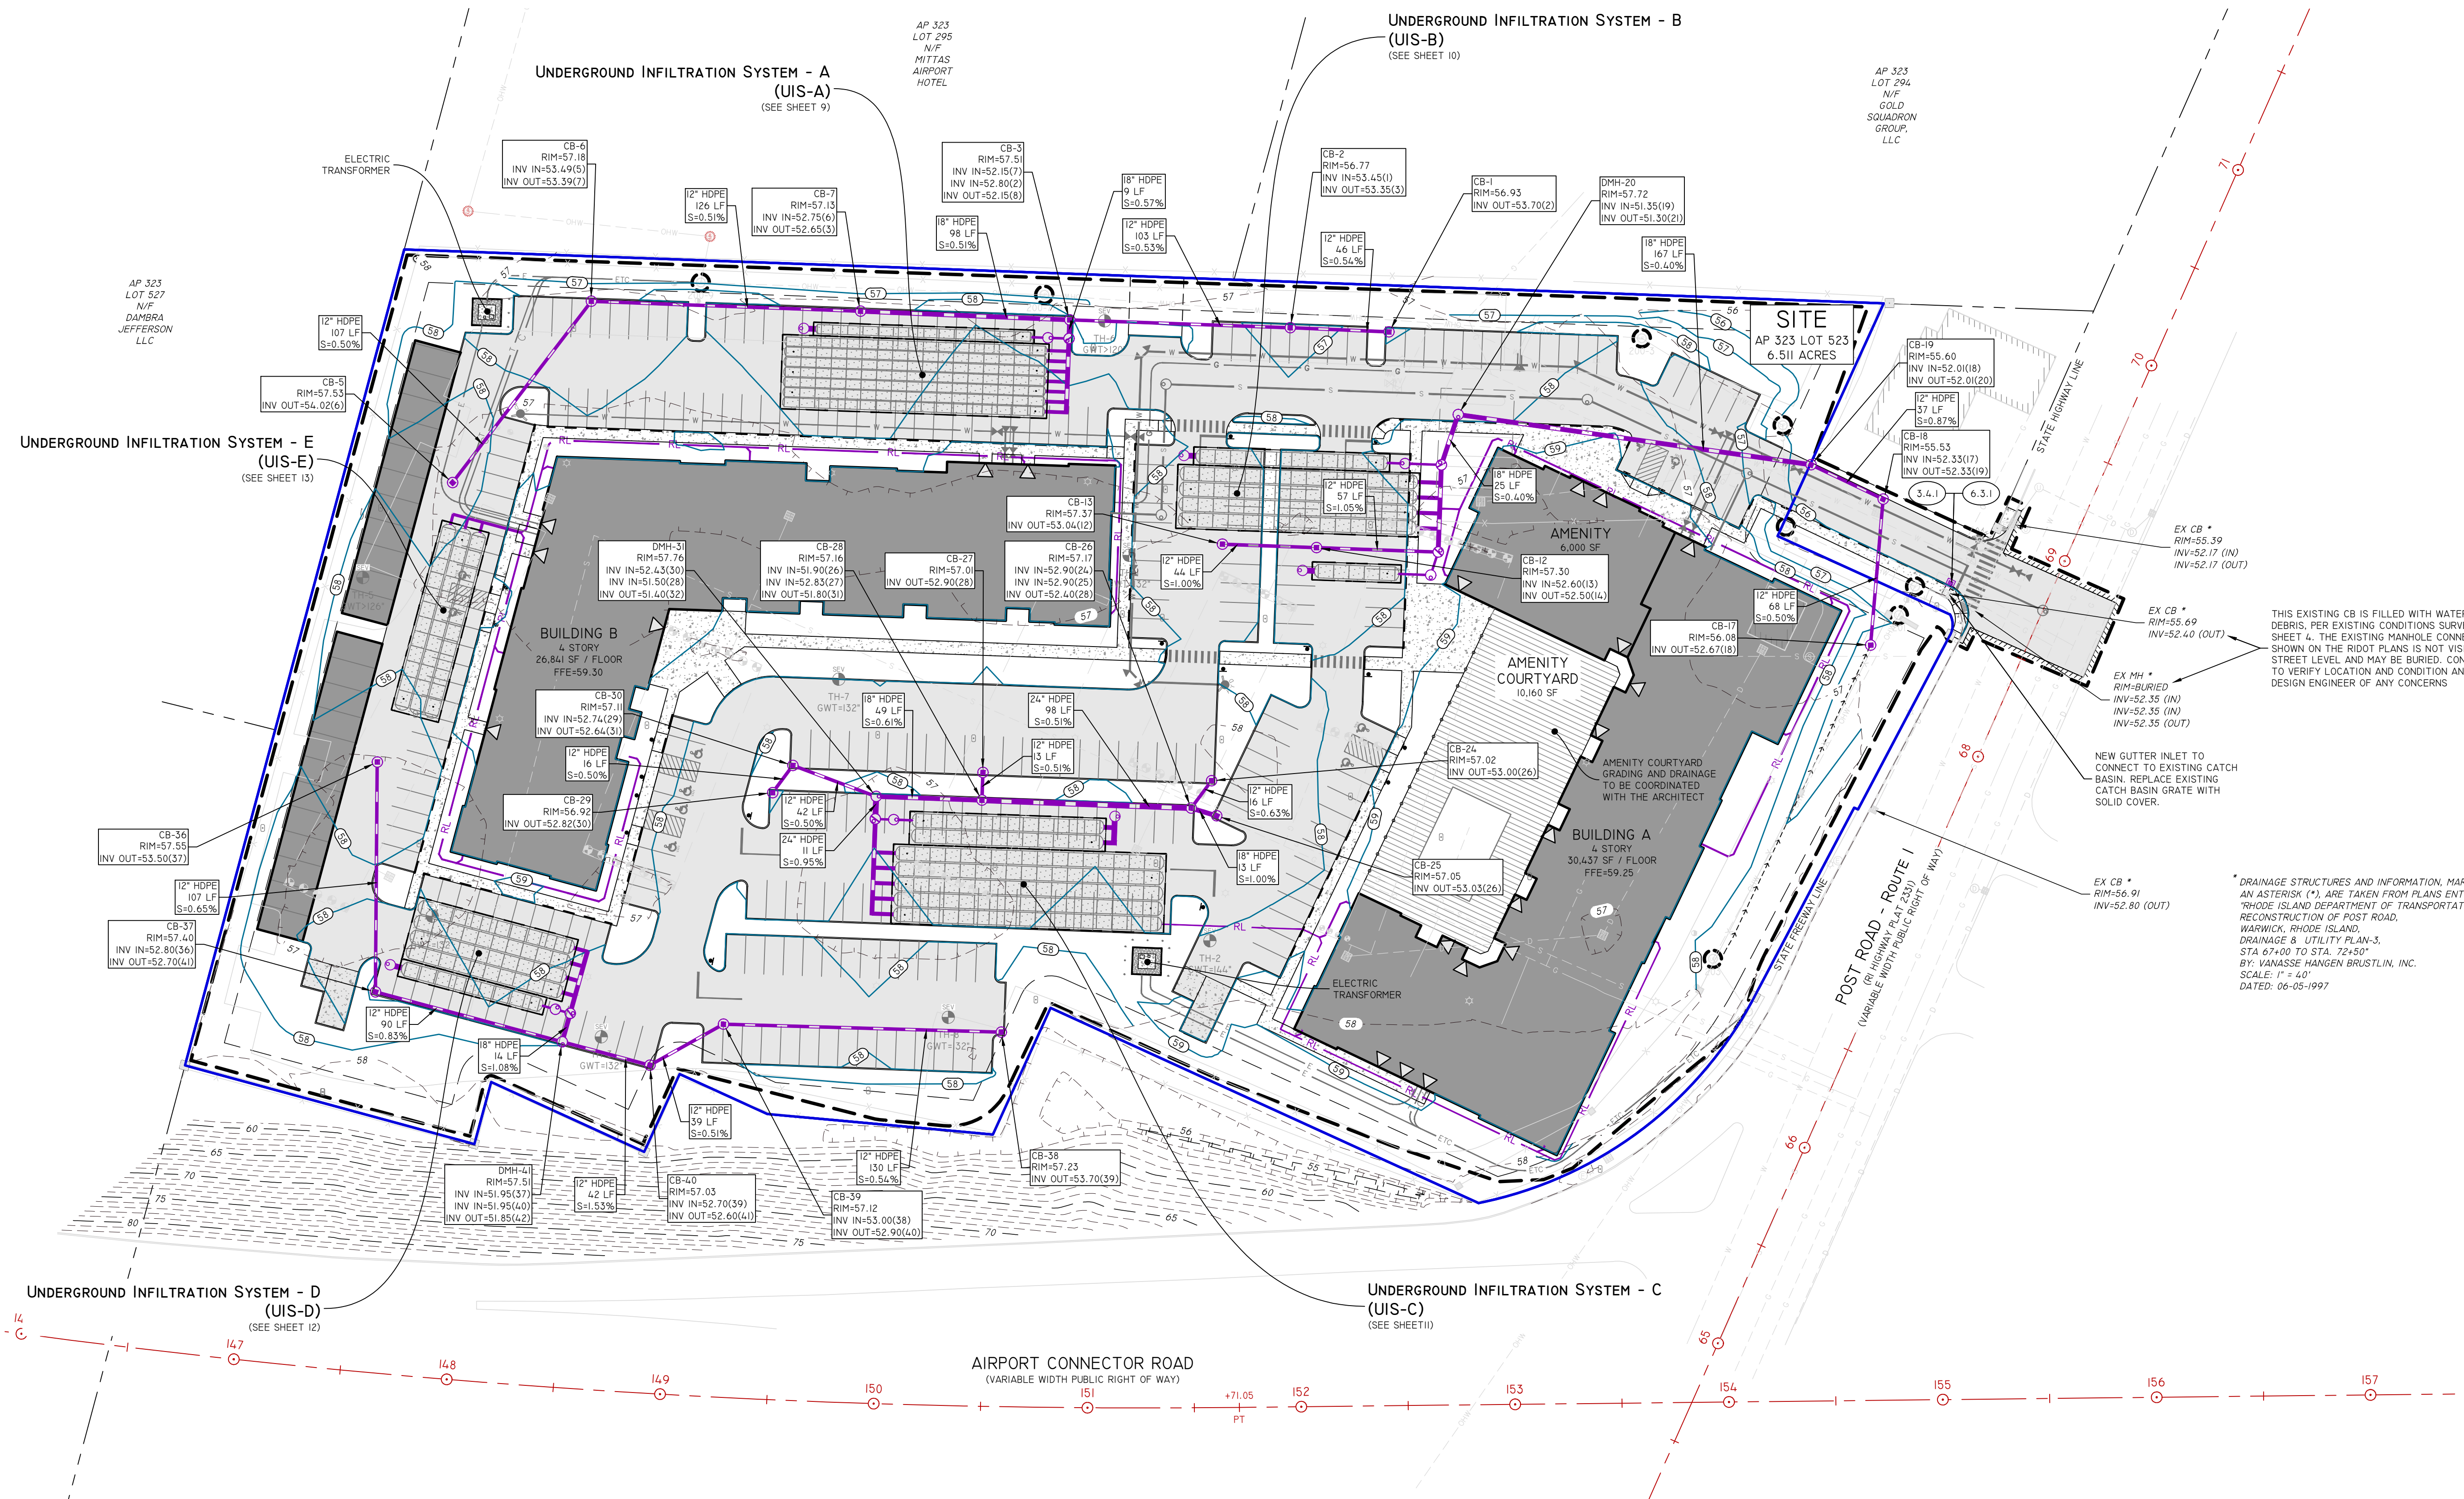

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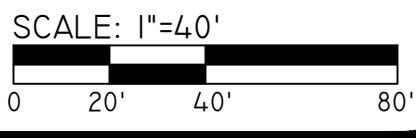
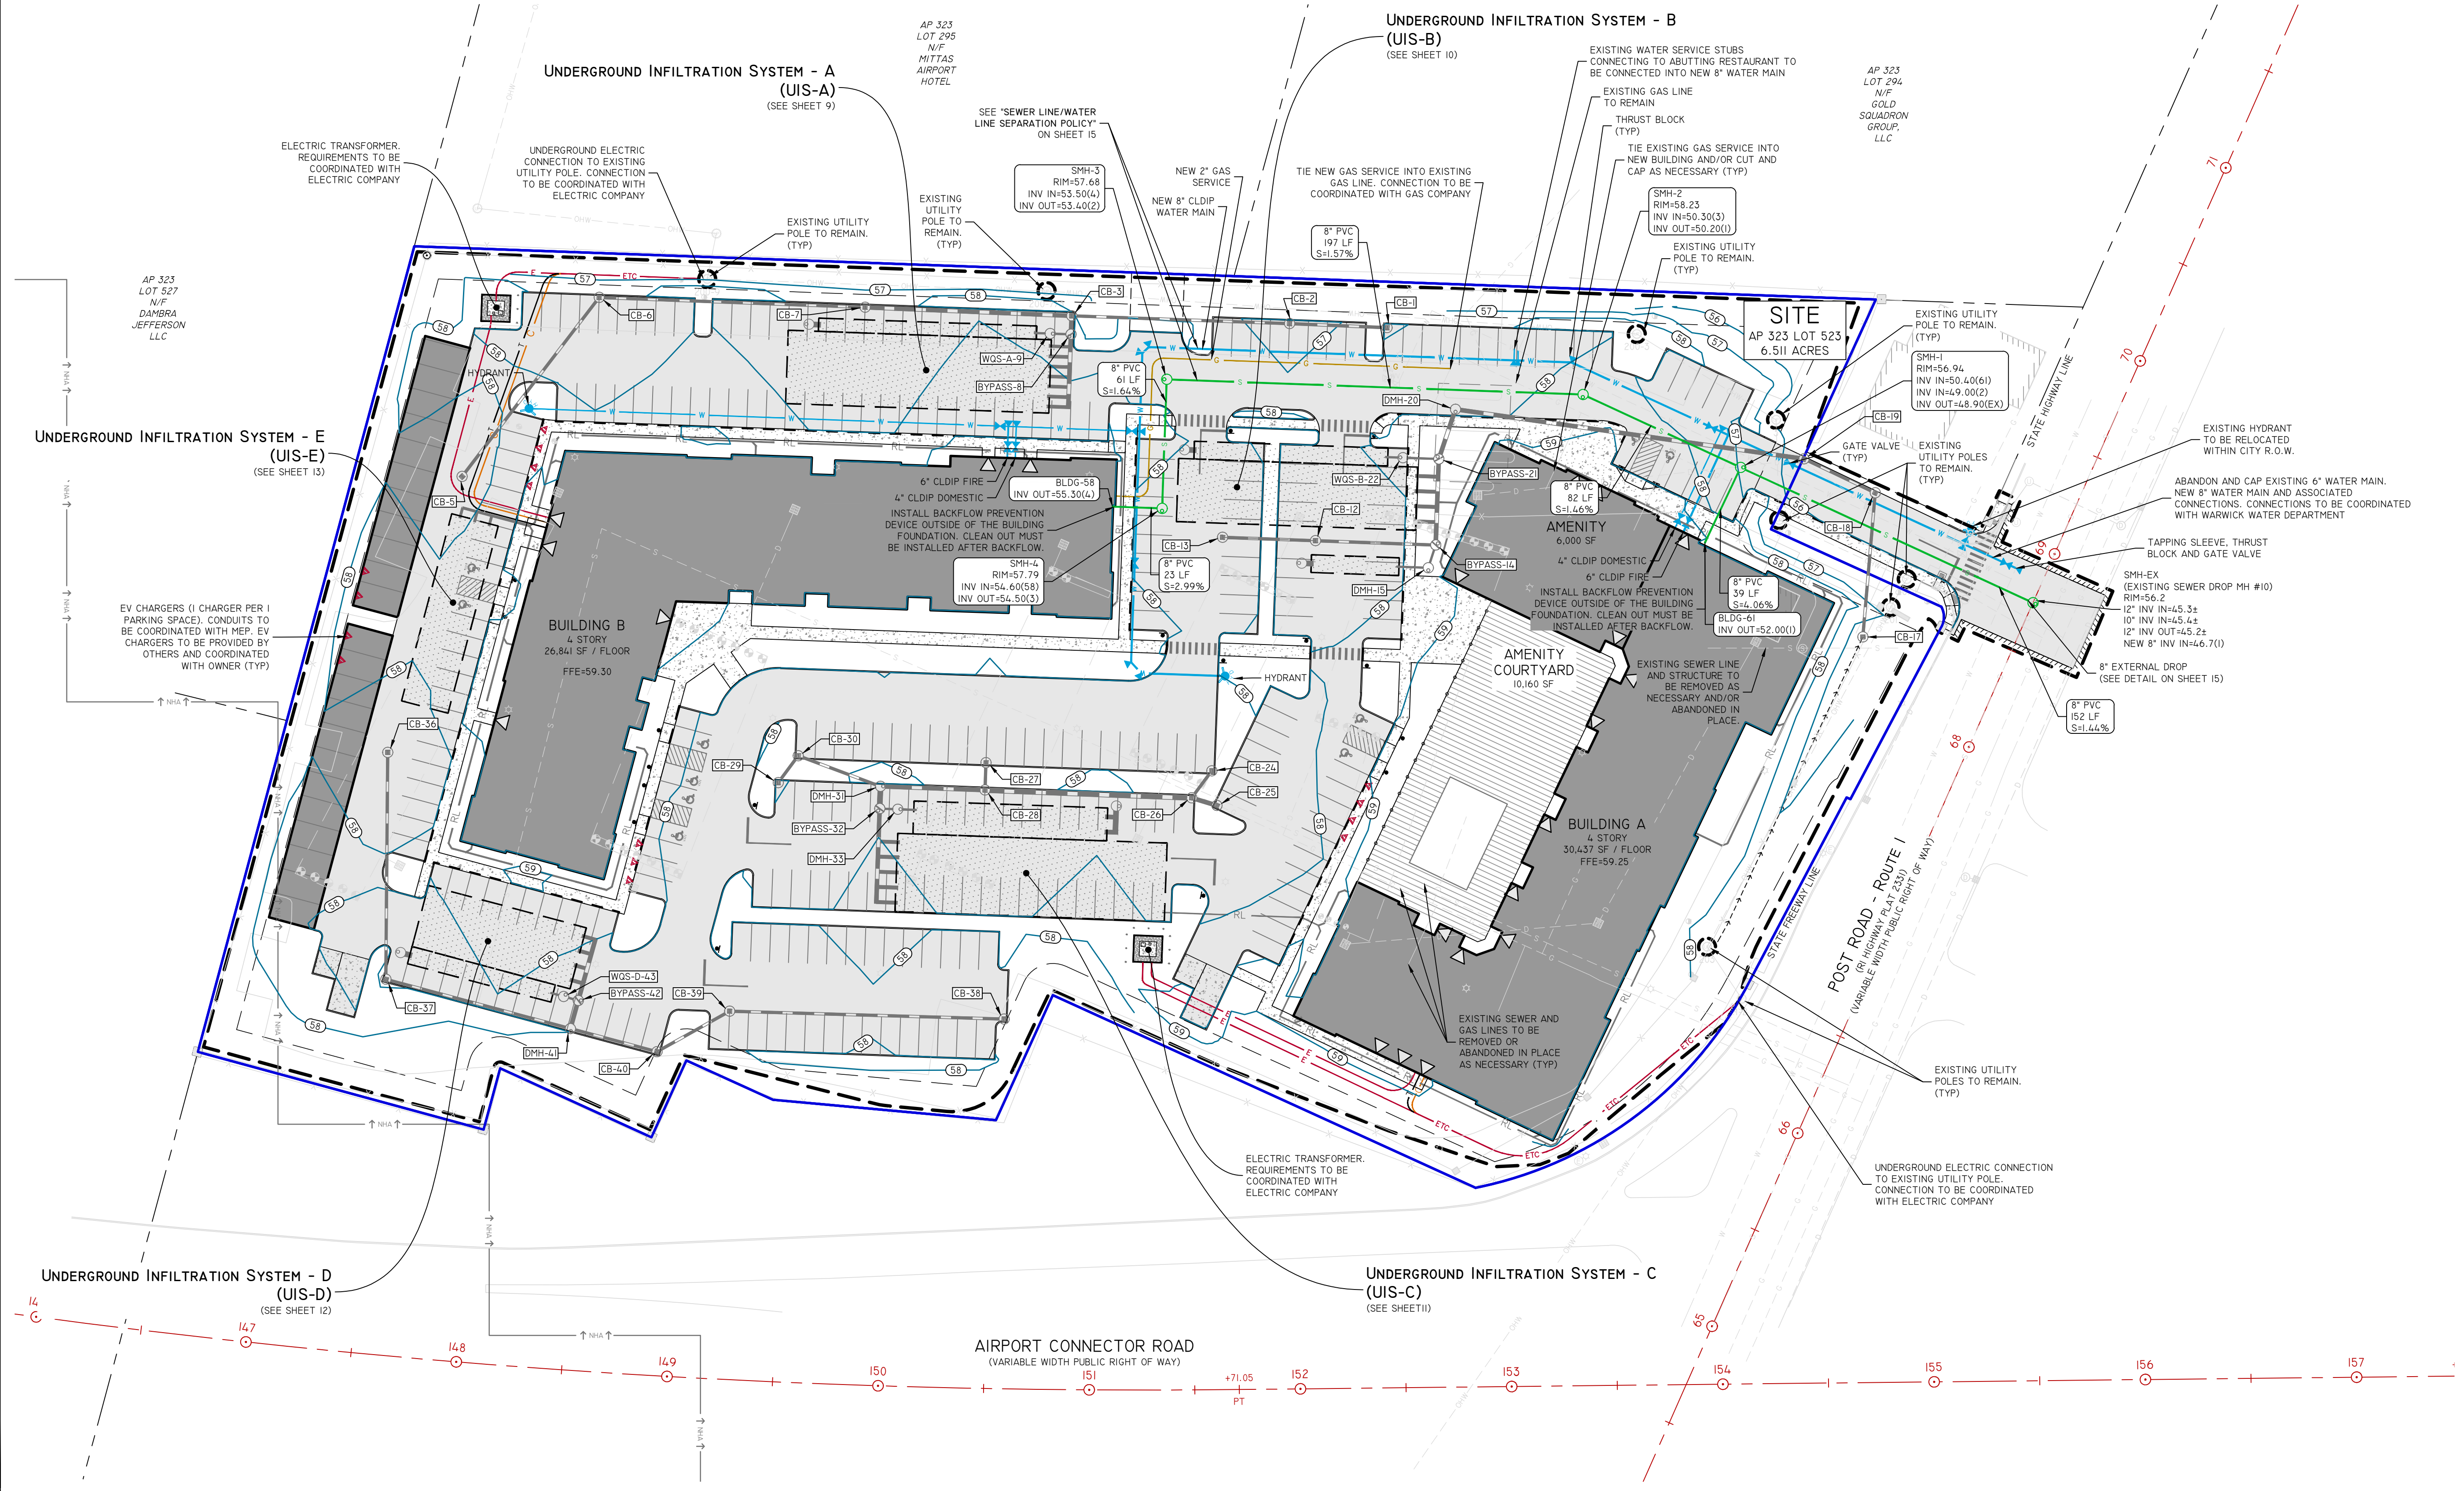


THIS PLAN SET IS NOT TO BE USED FOR CONSTRUCTION PURPOSES UNLESS IT IS APPROVED BY THE CITY ENGINEER.
DIPRETE ENGINEERING, INC. IS THE ENGINEER OF RECORD FOR THIS PROJECT.
THE CONTRACTOR IS RESPONSIBLE FOR ALL OF THE FIELD SURVEY, METHODS, SAFETY PRECAUTIONS AND REQUIREMENTS AND OSHA DESIGN. ANY CHANGES MADE IN THE IMPLEMENTATION OF THIS PLAN AND DESIGN SHALL BE THE RESPONSIBILITY OF THE CONTRACTOR.
EXISTING UTILITIES SHOWN ON THIS PLAN ARE APPROXIMATE. DATA FROM FIELD SURVEYING SHALL BE USED TO VERIFY THE LOCATION OF ALL UTILITIES.
SEE UTILITY NOTE ON SHEET 5.


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3	05/24/2023	REVISED SUBMISSION	J.A.R.	J.A.R.

DRAWN BY: J.A.R. DESIGN BY: P.Y.A.



UTILITIES PLAN
POST ROAD APARTMENTS
 ASSESSOR'S PLAT 323 LOT 523
 WARWICK, RHODE ISLAND
 PREPARED FOR:
SKYDRA DEVELOPMENT
 888 WASHINGTON STREET, SUITE #505, DEDHAM, MA 02026
 TEL 781-443-5600
 DE JOB NO. 2852-88-809 COPYRIGHT 2023 BY DIPRETE ENGINEERING ASSOCIATES, INC.




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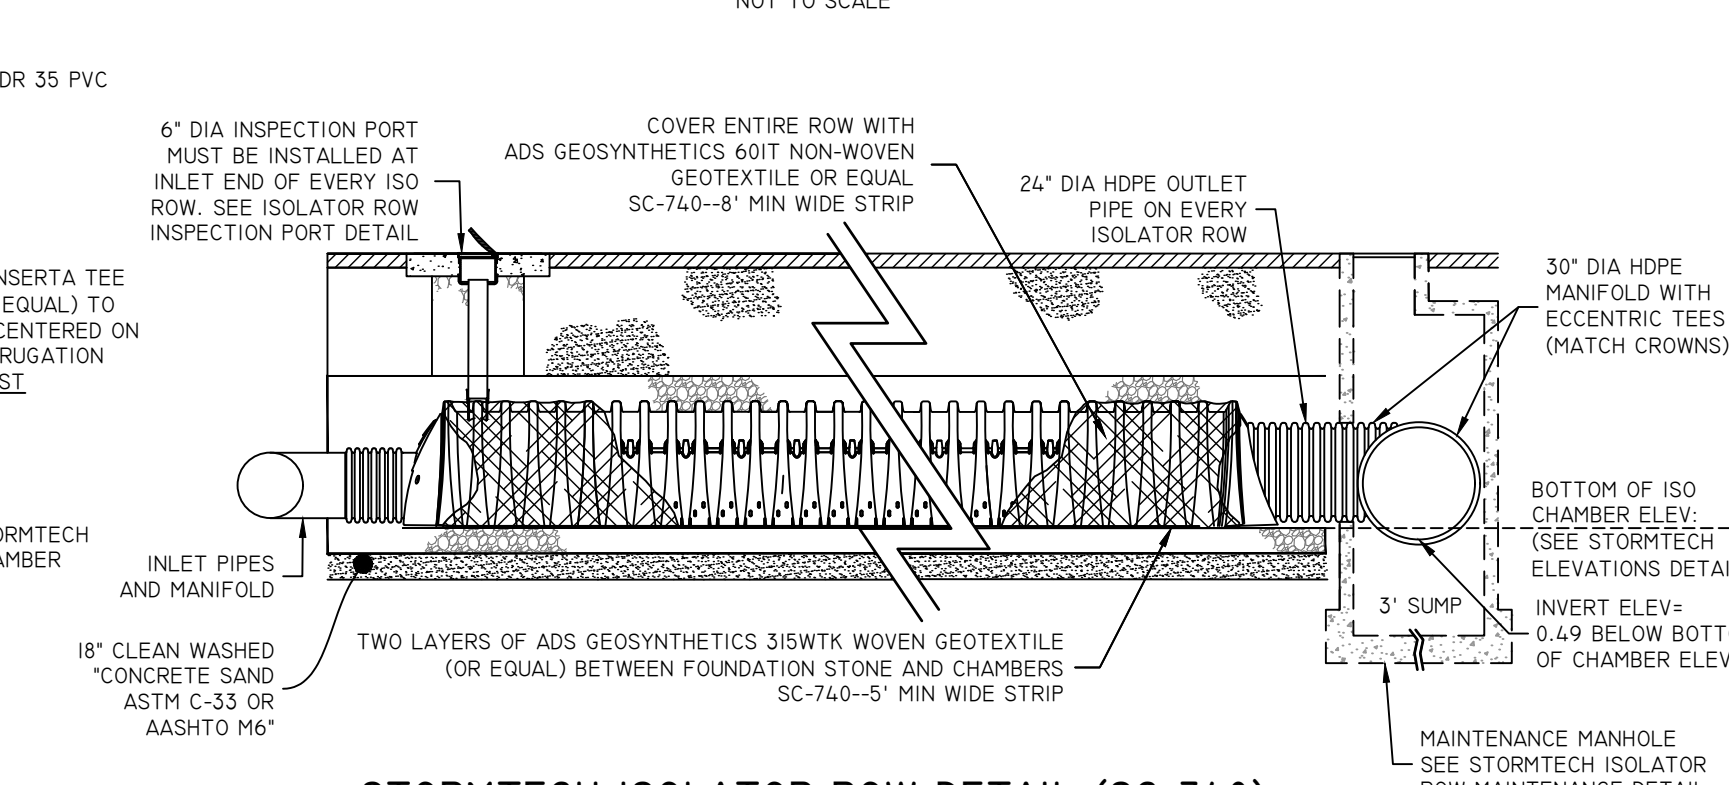
UNDERGROUND INFILTRATION SYSTEM - A (UIS-A)

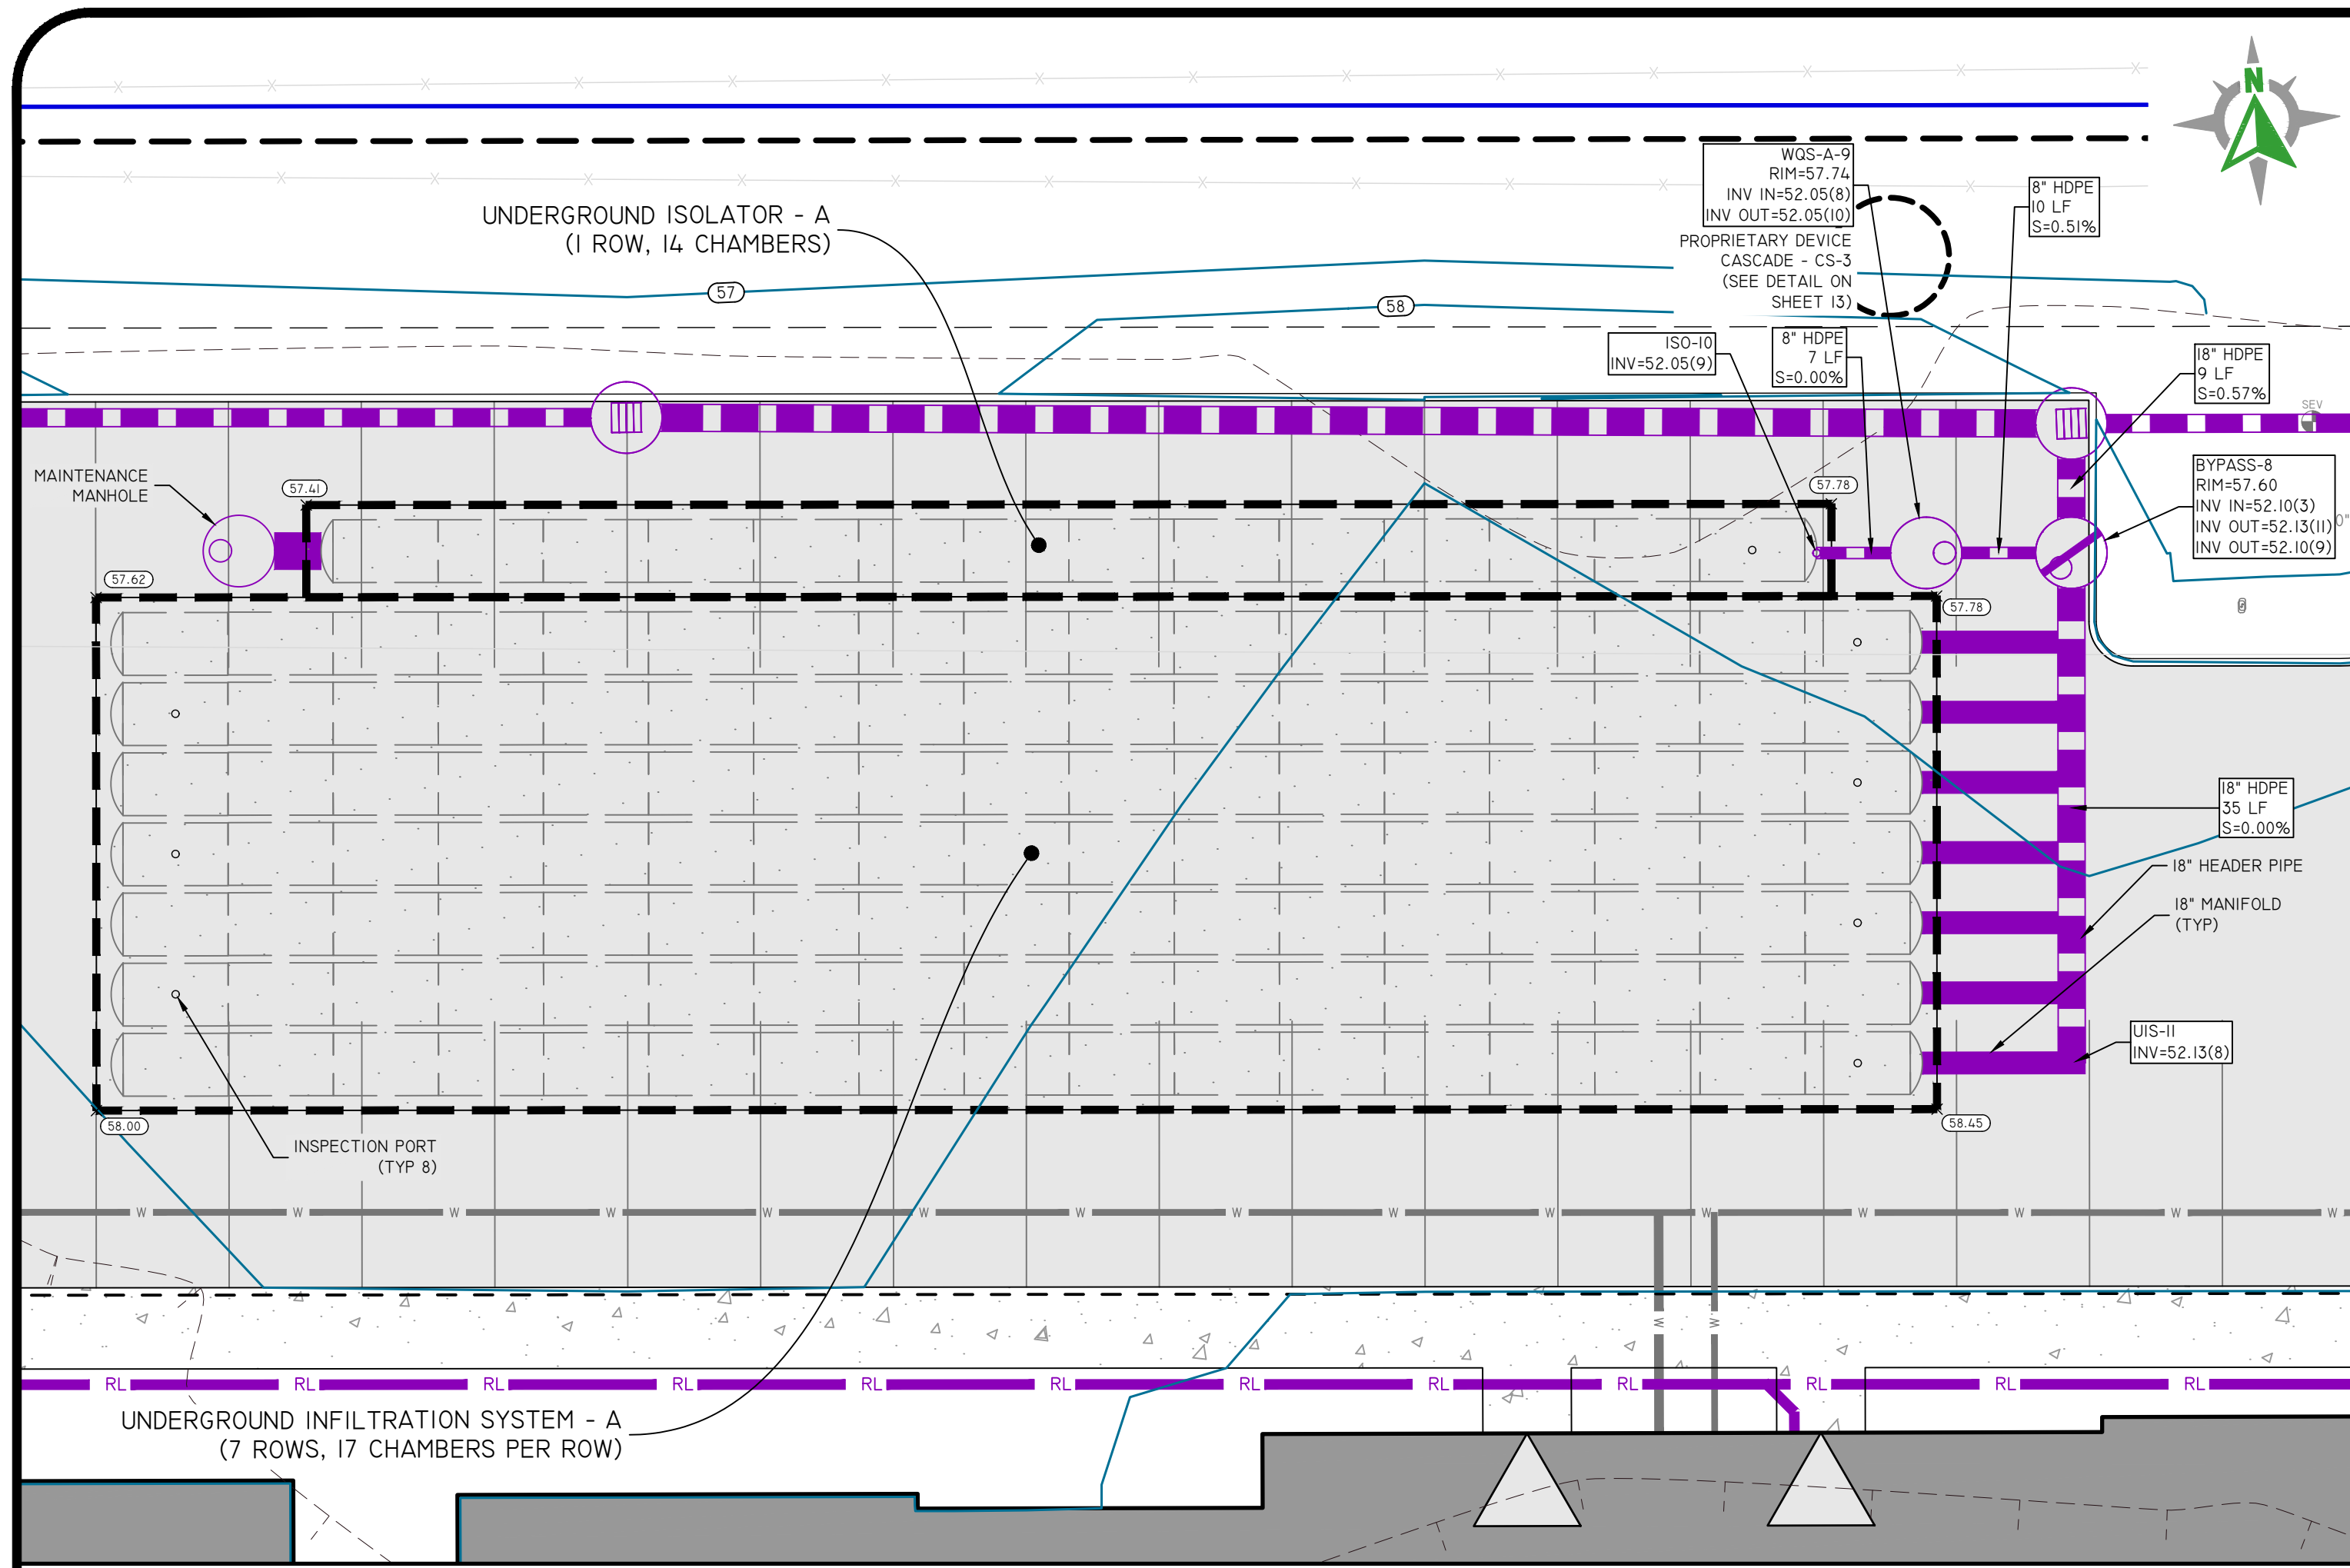


BYPASS-8 (4\"/>

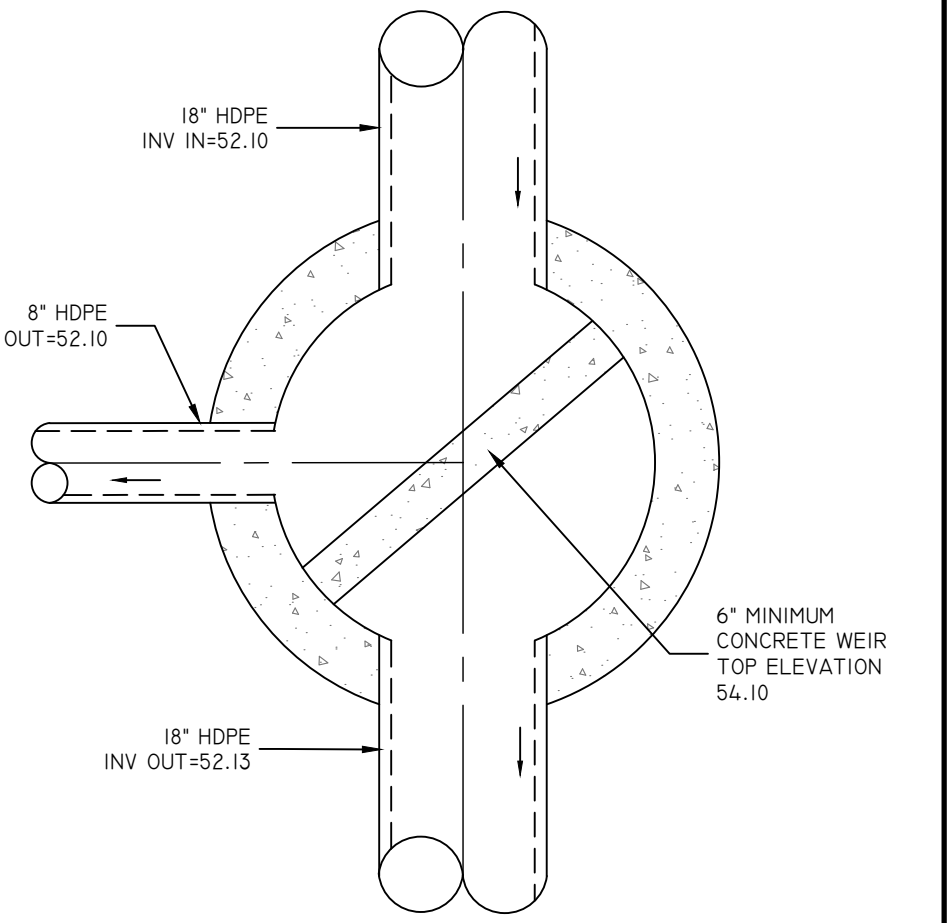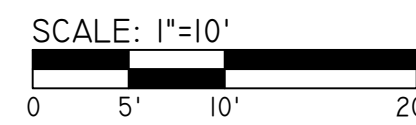


STORMTECH ISOLATOR ROW MAINTENANCE DETAIL (SINGLE ISO ROW)

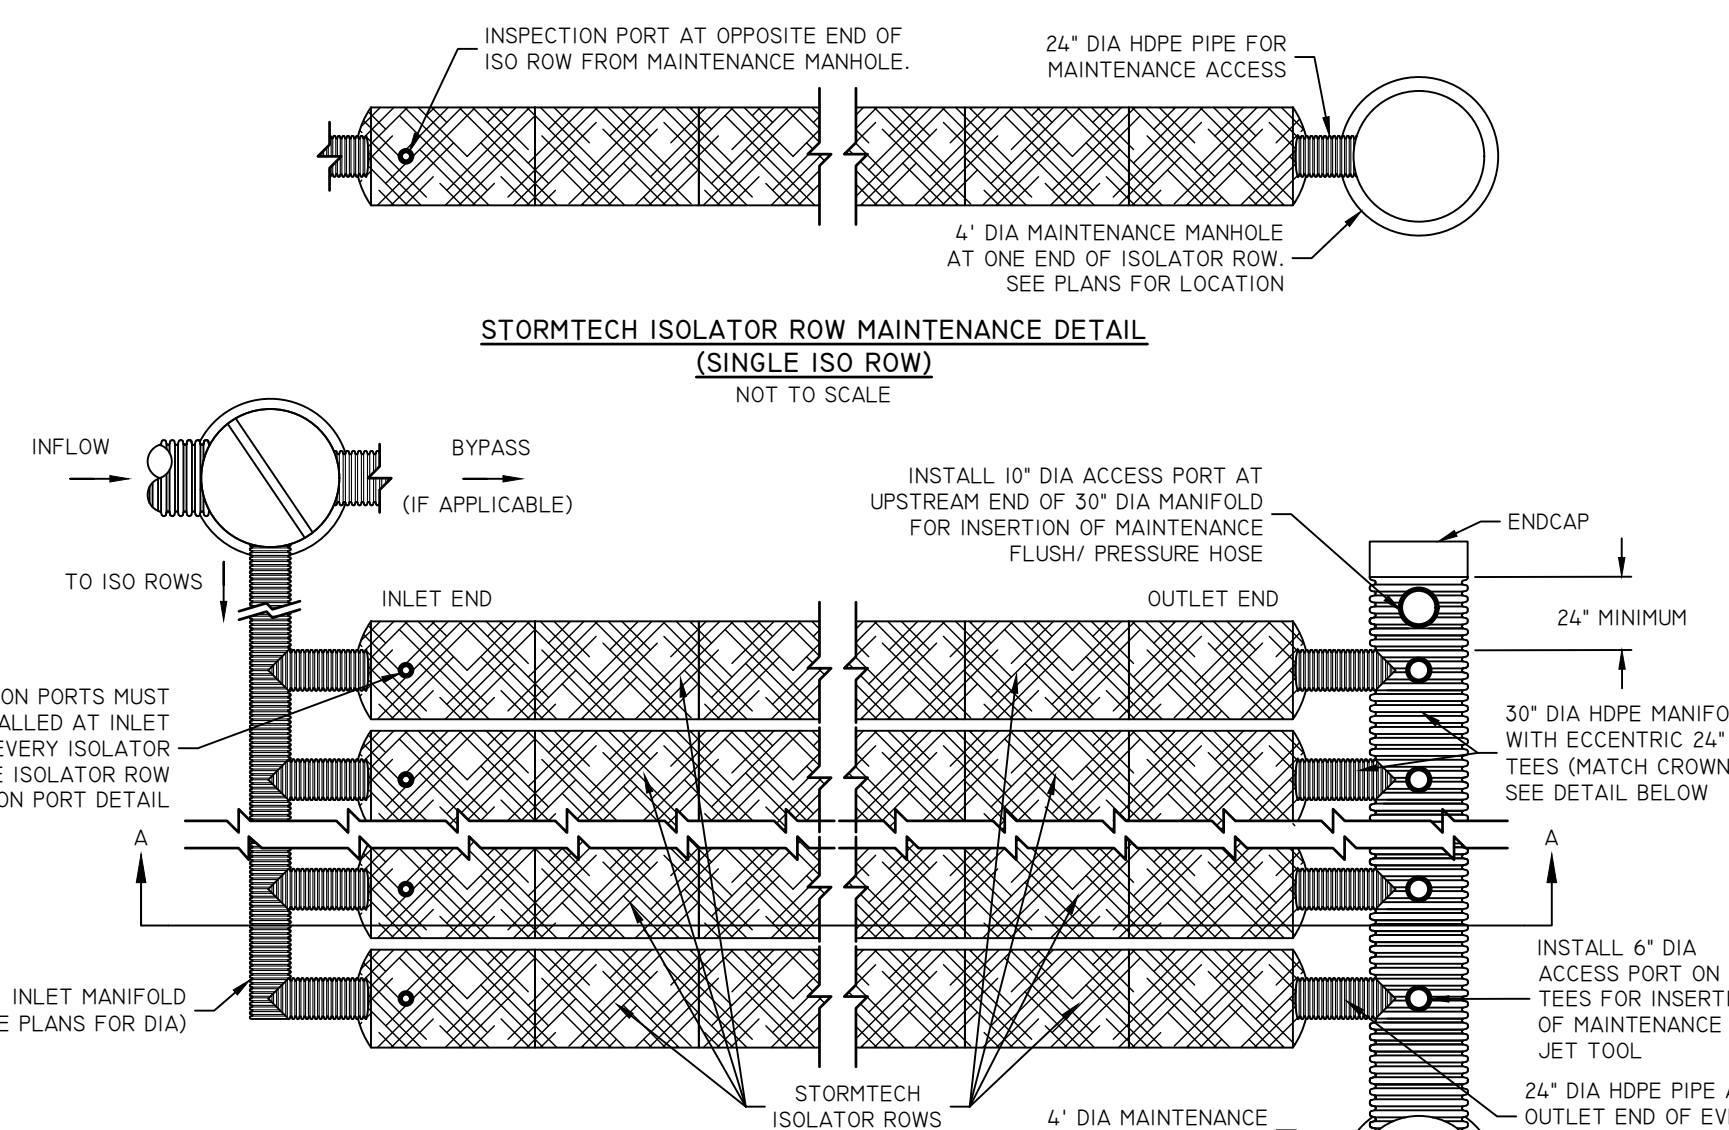

STORMTECH ISOLATOR ROW DETAIL (SC-740)

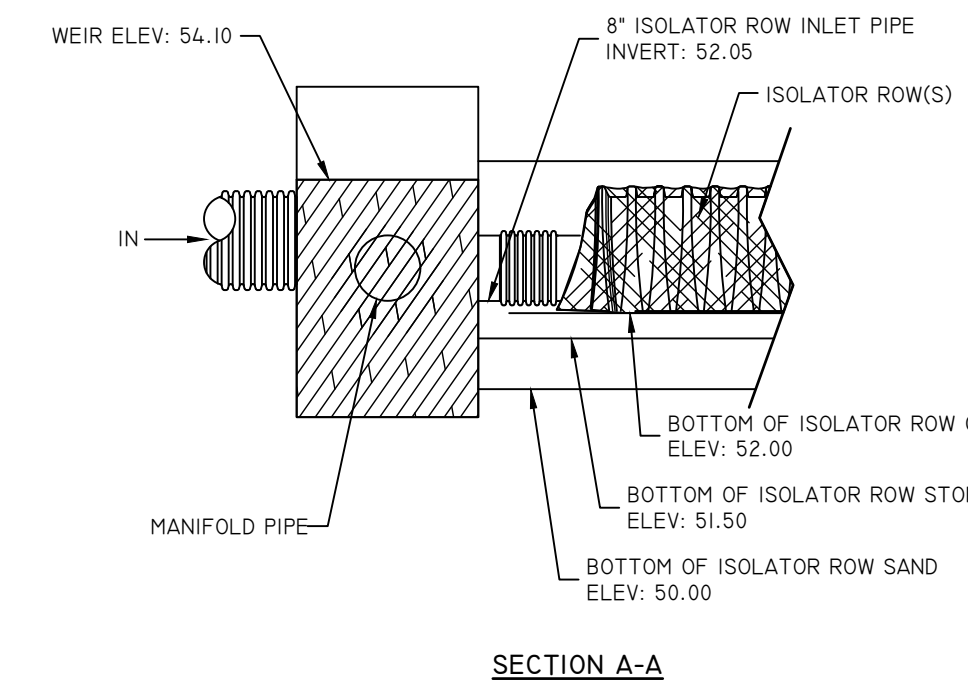


SECTION A-A

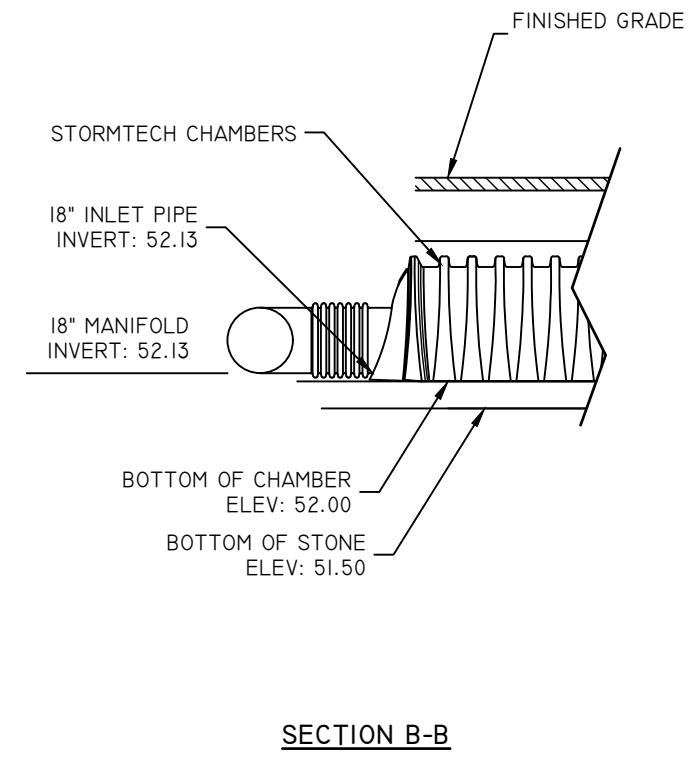

SECTION B-B


STORMTECH ELEVATIONS

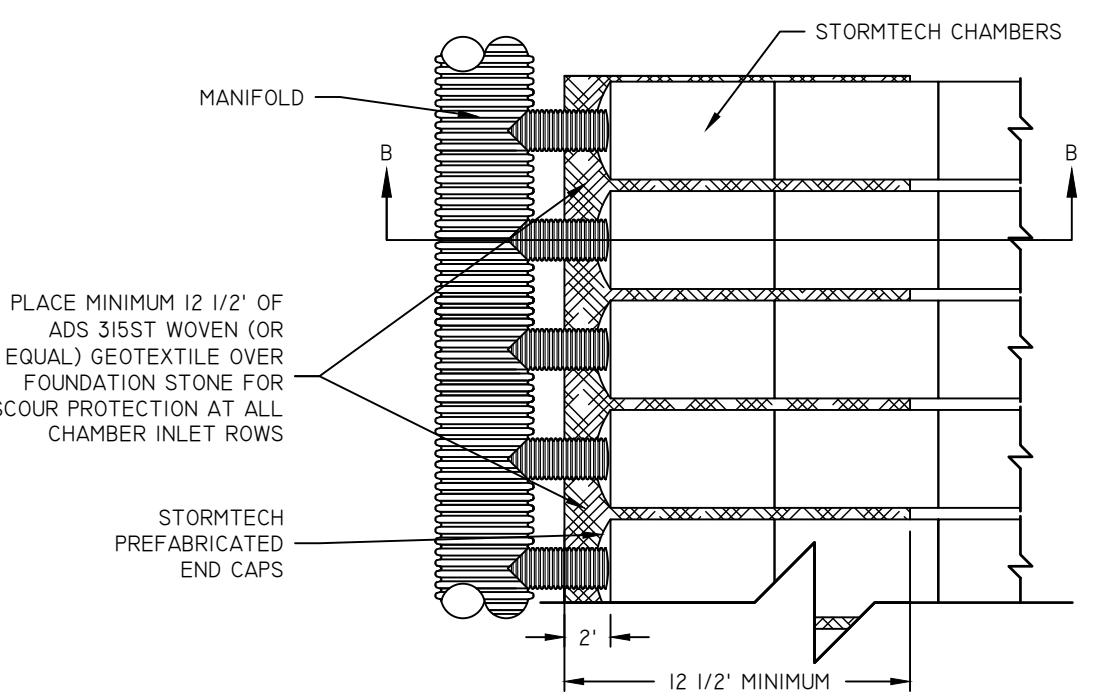

STORMTECH MANIFOLD DETAIL


CHAMBERS SHALL MEET ASTM F2418 "STANDARD SPECIFICATION FOR POLYPROPYLENE (PP) CORRUGATED WALL STORMWATER COLLECTION CHAMBERS" OR ASTM F2922 "STANDARD SPECIFICATION FOR POLYETHYLENE (PE) CORRUGATED WALL STORMWATER COLLECTION CHAMBERS".

- NOTES:**
- THIS CROSS SECTION DETAILS THE REQUIREMENTS NECESSARY TO SATISFY THE LOAD FACTORS SPECIFIED IN THE AASHTO LRFD BRIDGE DESIGN SPECIFICATIONS SECTION 12.12 FOR EARTH AND LIVE LOADS USING STORMTECH CHAMBERS. SEE APPLICABLE STORMTECH CONSTRUCTION GUIDES AND ALL APPLICABLE DOCUMENTS FOR SPECIFIC MATERIAL REQUIREMENTS.
 - SEE LATEST STORMTECH DESIGN MANUAL FOR CURRENT REQUIREMENTS.
 - ALL STORMTECH CHAMBERS AND ASSOCIATED/ ANCILLARY COMPONENTS MUST BE INSTALLED PER MANUFACTURER RECOMMENDATIONS AND THESE PLANS. CONTRACTOR TO NOTIFY DESIGN ENGINEER OF ANY DISCREPANCIES PRIOR TO INSTALLATION.

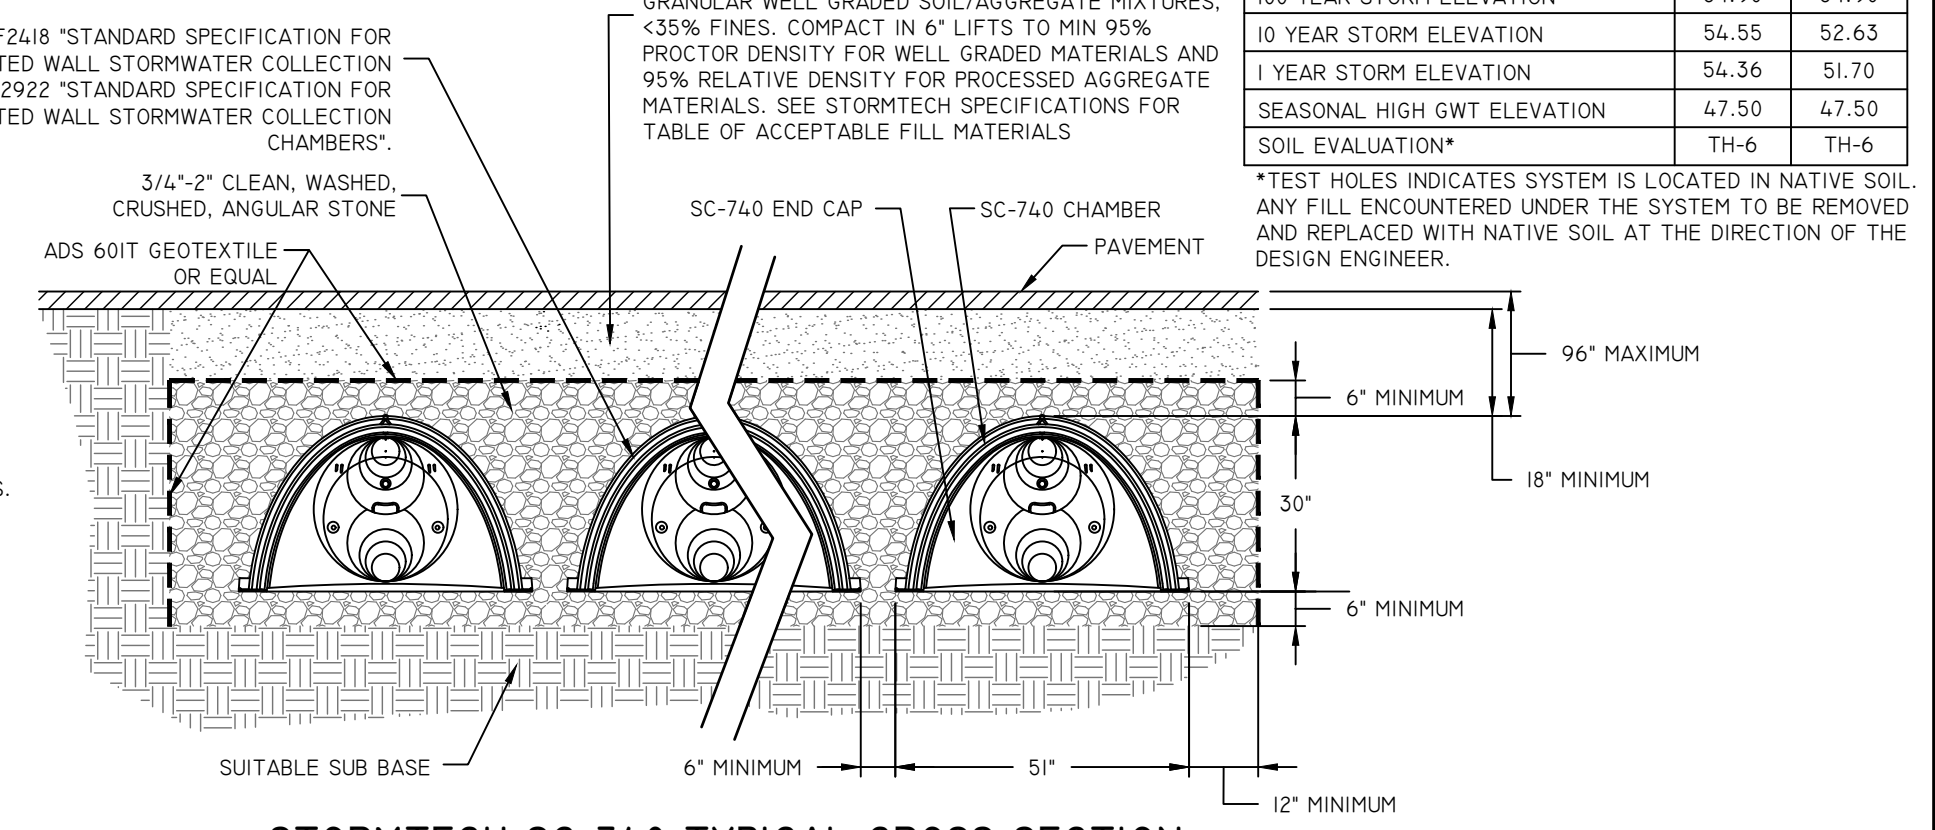

STORMTECH SC-740 TYPICAL CROSS SECTION

DESCRIPTION	ISO-A	UIS-A
TOP OF UIS STONE ELEVATION	55.00	55.00
BOTTOM OF UIS STONE ELEVATION	51.50	51.50
100 YEAR STORM ELEVATION	54.90	54.90
10 YEAR STORM ELEVATION	54.55	52.63
1 YEAR STORM ELEVATION	54.36	51.70
SEASONAL HIGH GWL ELEVATION	47.50	47.50
SOIL EVALUATION*	TH-6	TH-6

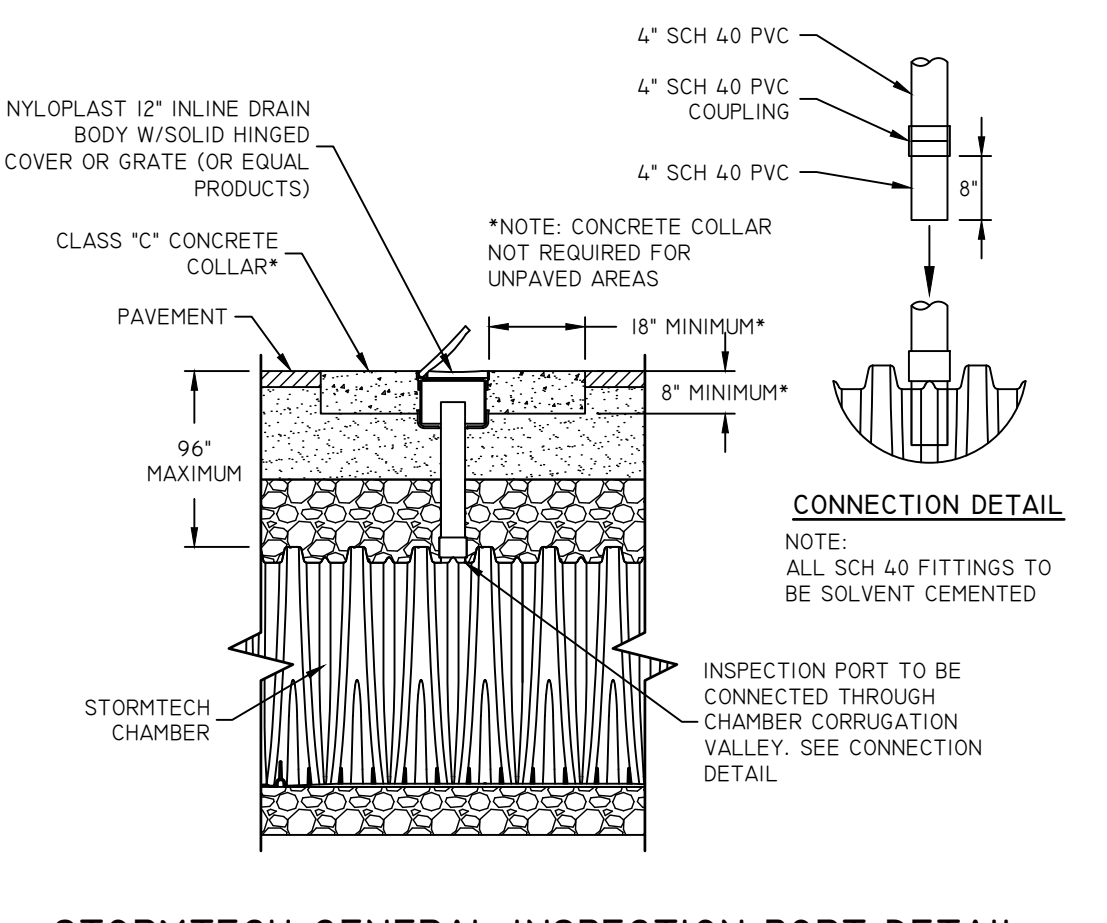

STORMTECH GENERAL INSPECTION PORT DETAIL

Diprete Engineering
 Two Starford Court Cranston, RI 02920
 Tel: 401-943-1000 Fax: 401-644-6006 www.diprete-eng.com

Boston • Providence • Newport

BRANDON D. CARR
 REGISTERED PROFESSIONAL ENGINEER
 CIVIL

THIS PLAN SET MUST NOT BE USED FOR CONSTRUCTION PURPOSES UNLESS IT IS APPROVED BY A REGISTERED PROFESSIONAL ENGINEER OF DIPRETE ENGINEERING.

DIPRETE ENGINEERING, INC. STANDARD PLANS DIVISION
 REGISTERED PROFESSIONAL ENGINEER OF DIPRETE ENGINEERING, INC.
 THE CONTRACTOR IS RESPONSIBLE FOR ALL OF THE MEASUREMENTS, METHODS, SAFETY PRECAUTIONS AND REQUIREMENTS AND OSHA DESIGN. DAMAGE IN THE IMPLEMENTATION OF THIS PLAN AND EXISTING UTILITIES SHOWN ON THIS PLAN ARE APPROXIMATE. DAMAGE TO EXISTING UTILITIES SHALL BE THE RESPONSIBILITY OF THE CONTRACTOR. SEE UTILITY NOTES ON SHEET 1.

NO.	DATE	DESCRIPTION	BY:	CHK:
1	05-24-2024	PRELIMINARY SUBMISSION	J.A.R.	J.A.R.
2	05-24-2024	RESPONSE TO RFI COMMENTS	J.A.R.	J.A.R.
3	05-24-2024	FINAL SUBMISSION	J.A.R.	J.A.R.

DESIGN BY: J.A.R.

UNDERGROUND INFILTRATION SYSTEM - A


POST ROAD APARTMENTS
 ASSessor'S PLAT 323 LOT 523
 WARWICK, RHODE ISLAND

PREPARED FOR:
SKYDRA DEVELOPMENT
 858 WASHINGTON STREET, SUITE #305, DEDHAM, MA 02026
 TEL: 781-451-5600



DESIGN BY: J.A.R.

REVISIONS:
 1. 05-24-2024: PRELIMINARY SUBMISSION
 2. 05-24-2024: RESPONSE TO RFI COMMENTS
 3. 05-24-2024: FINAL SUBMISSION


DATE: 05-24-2024
 DESCRIPTION: UNDERGROUND INFILTRATION SYSTEM FOR POST ROAD APARTMENTS
 DRAWN BY: J.A.R.

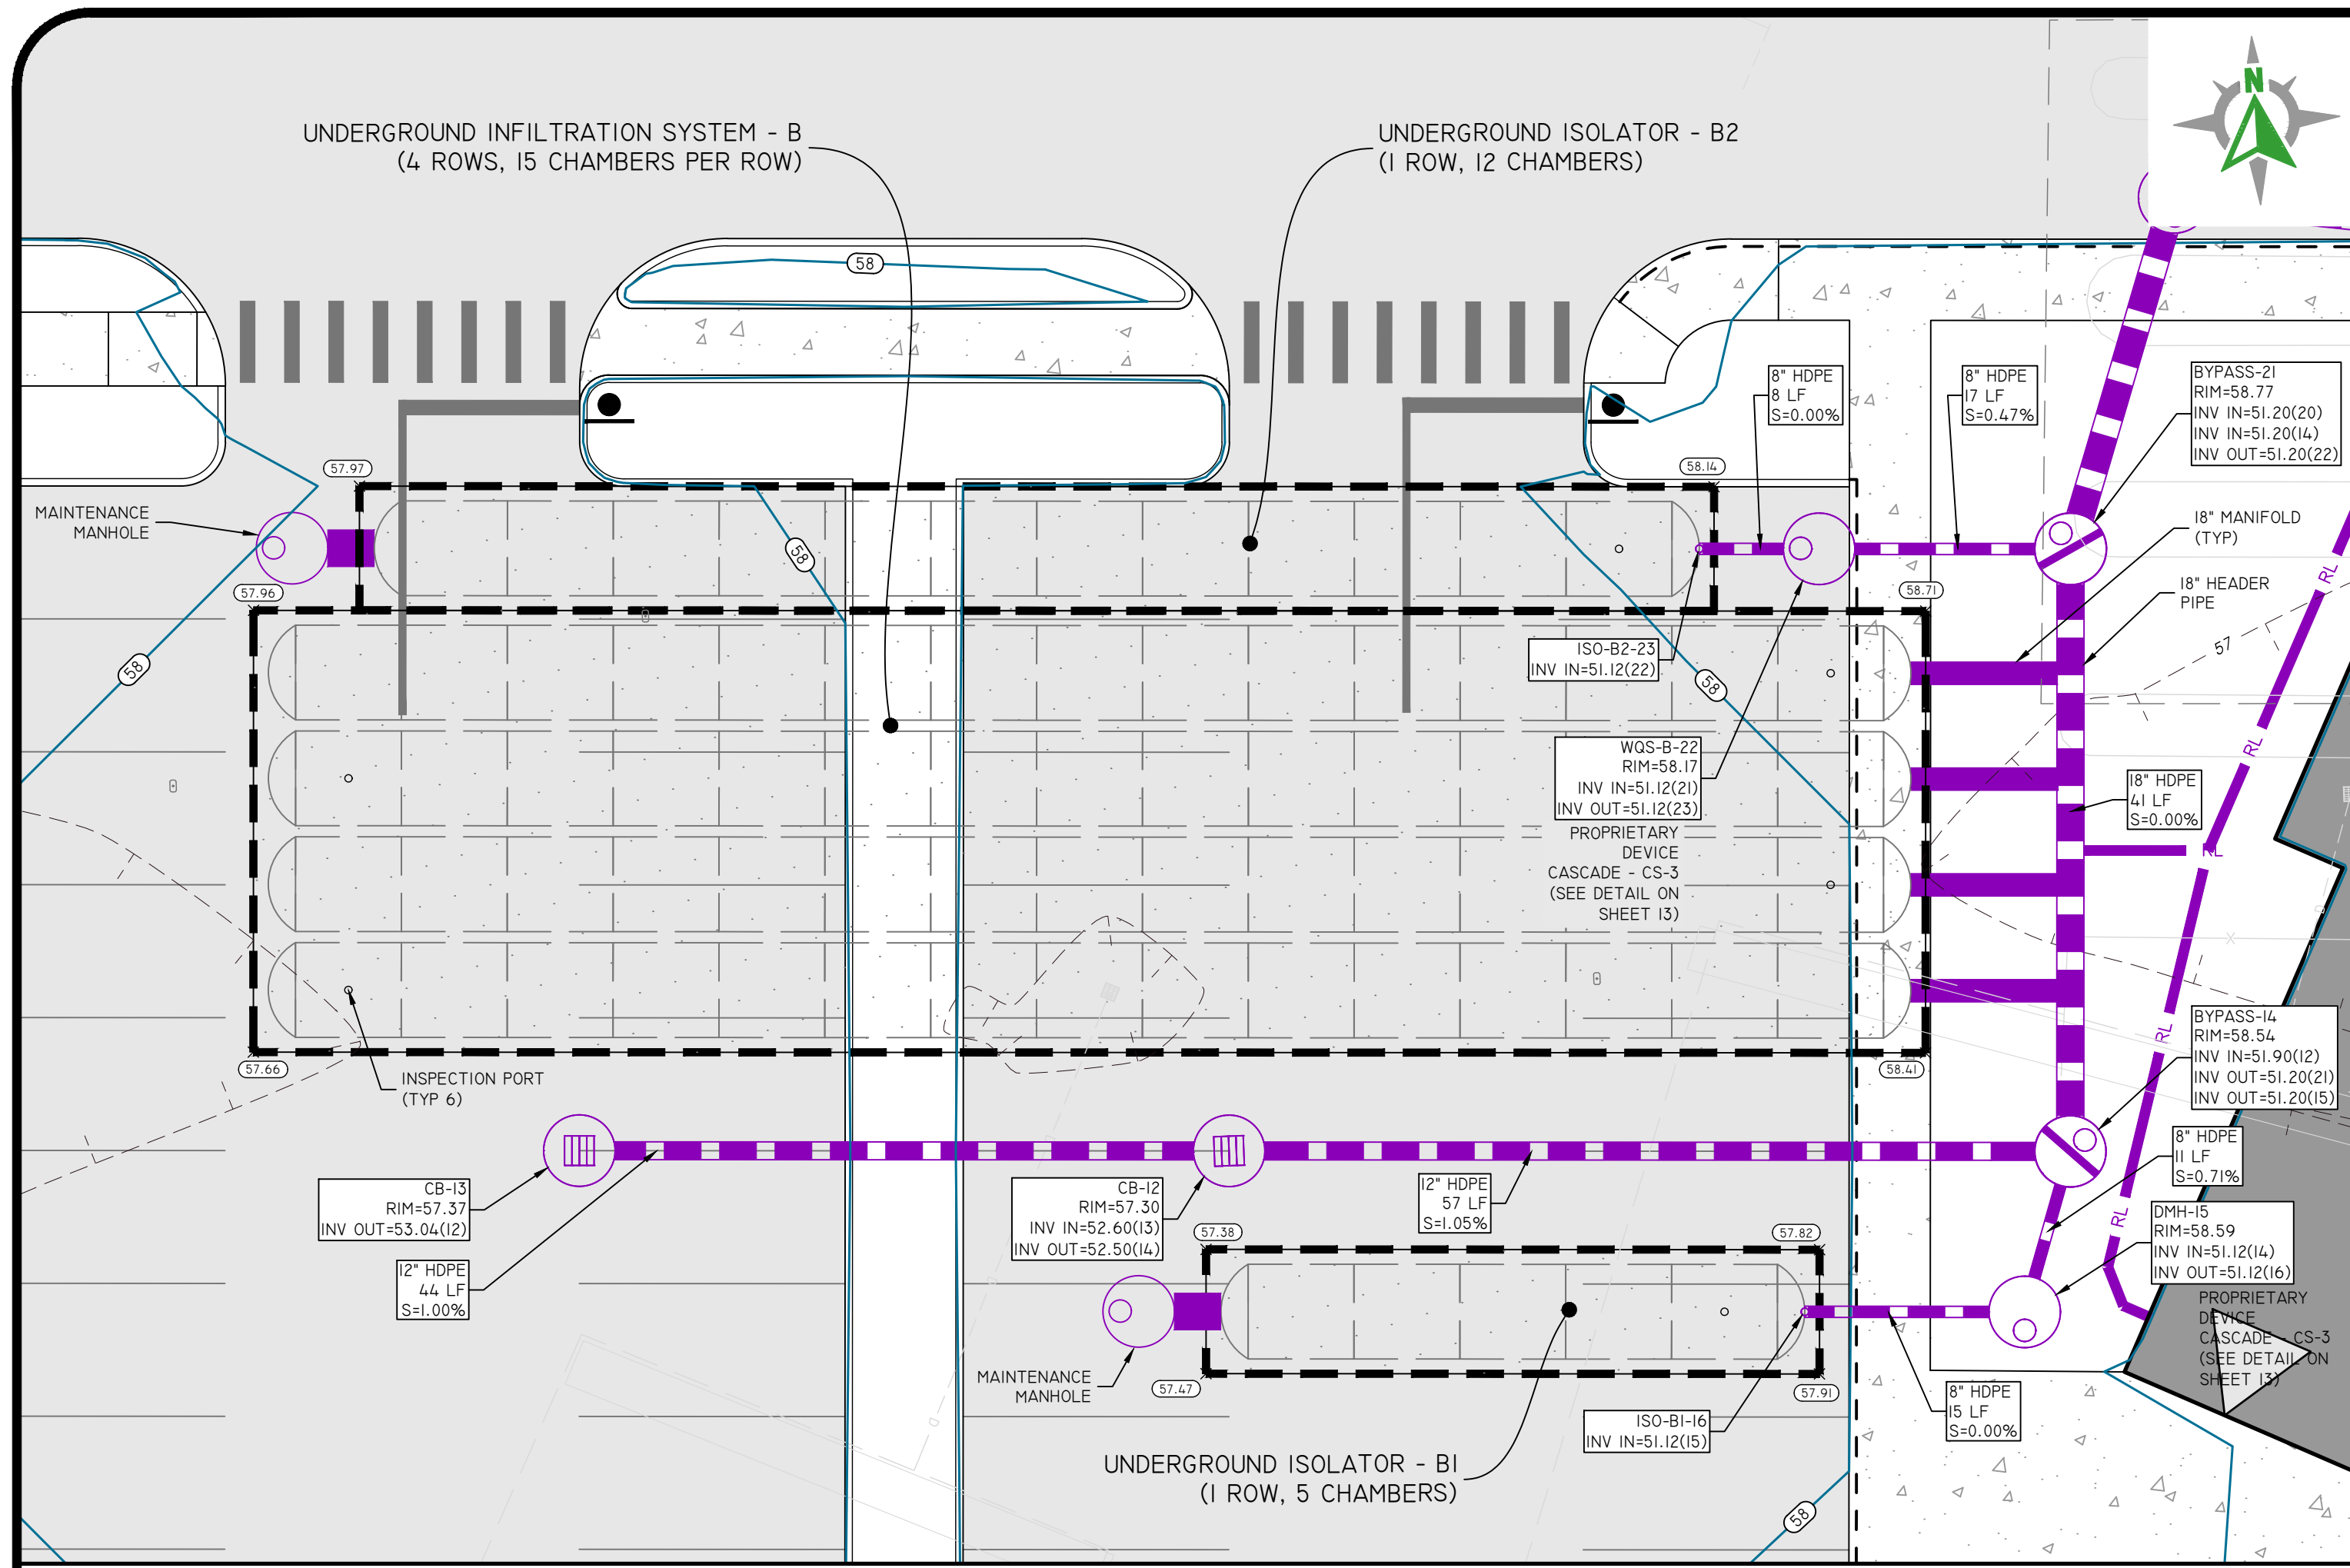


UNDERGROUND INFILTRATION SYSTEM - B (UIS-B)

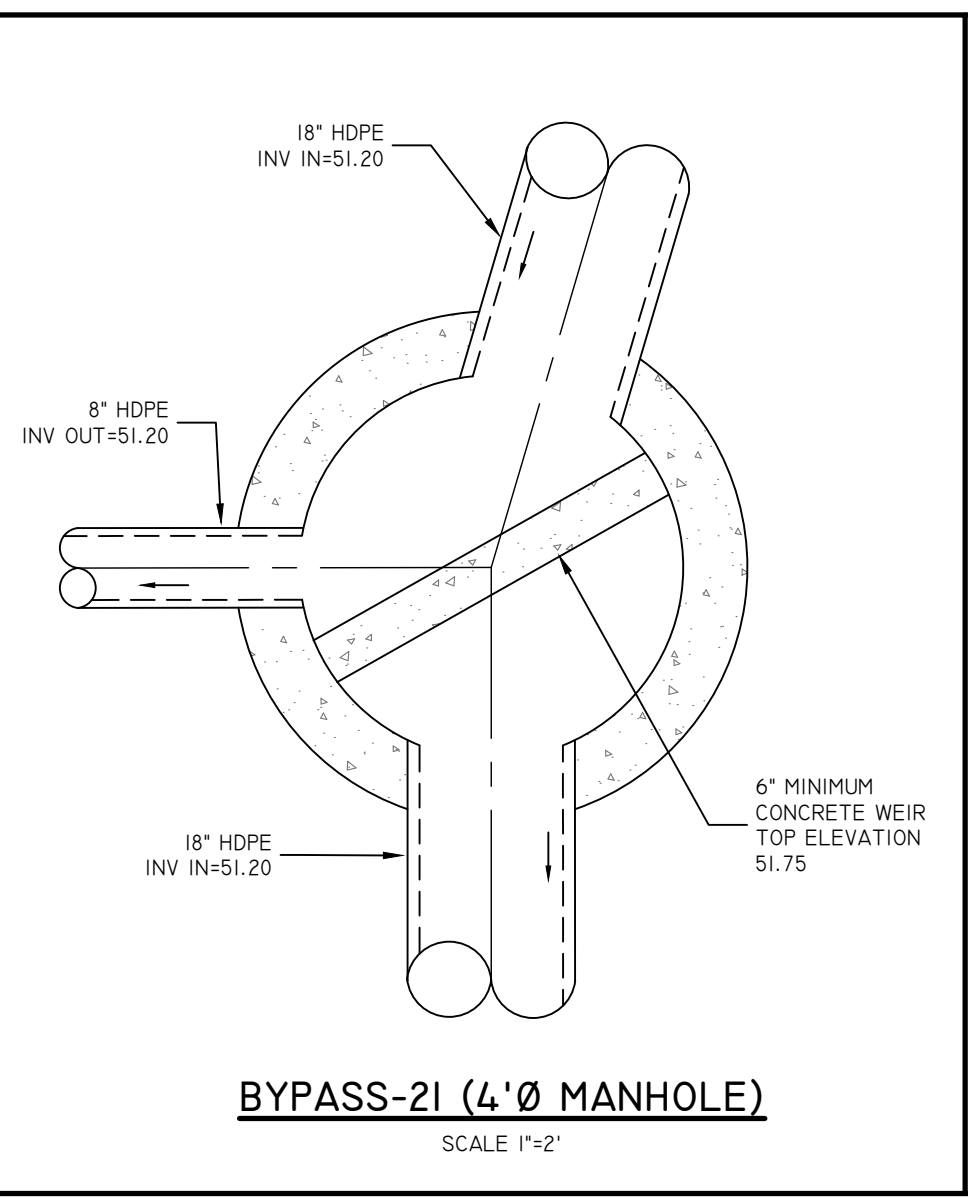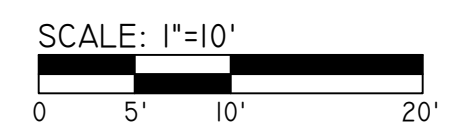


BYPASS-21 (4' Ø MANHOLE)

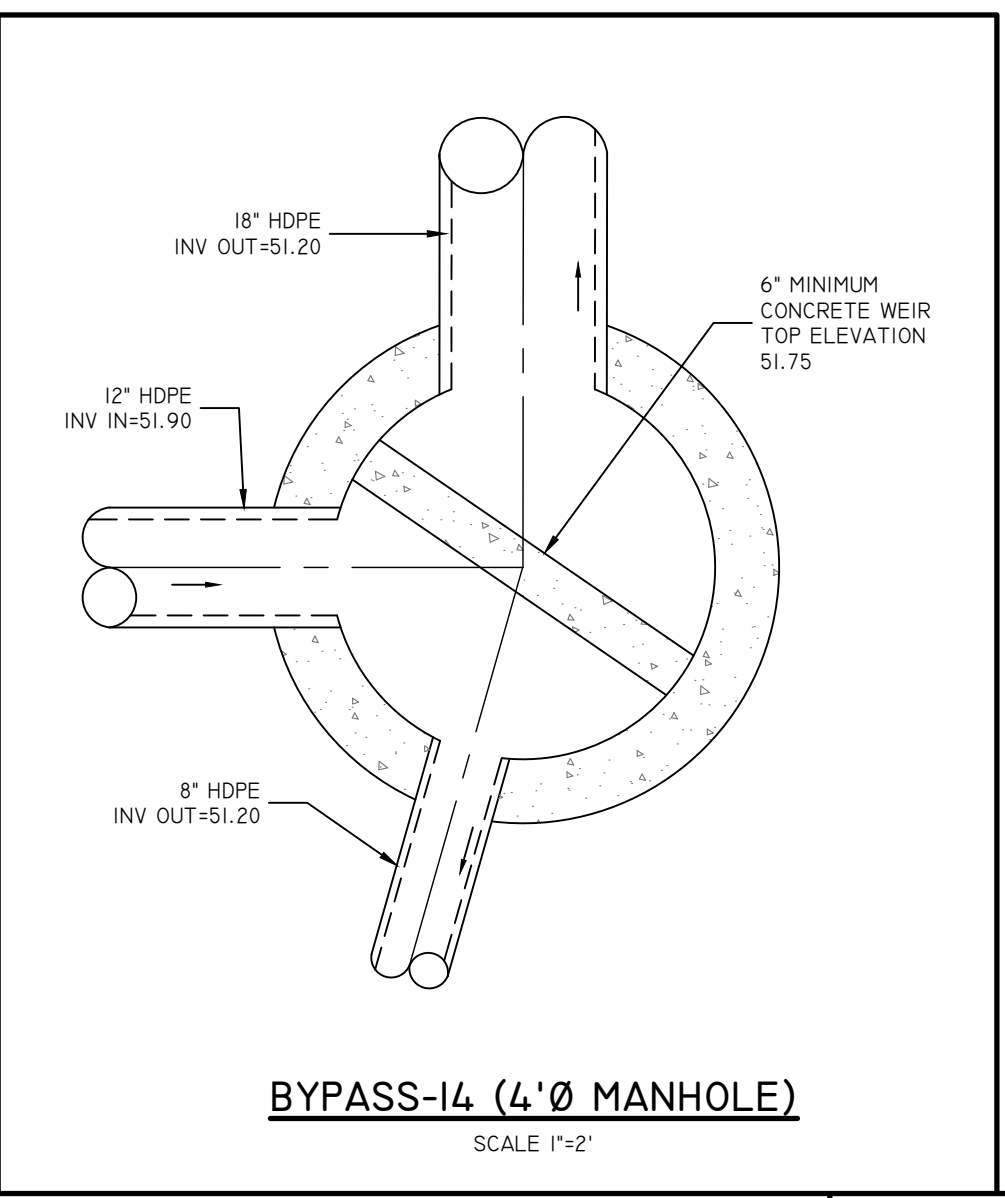


BYPASS-14 (4' Ø MANHOLE)

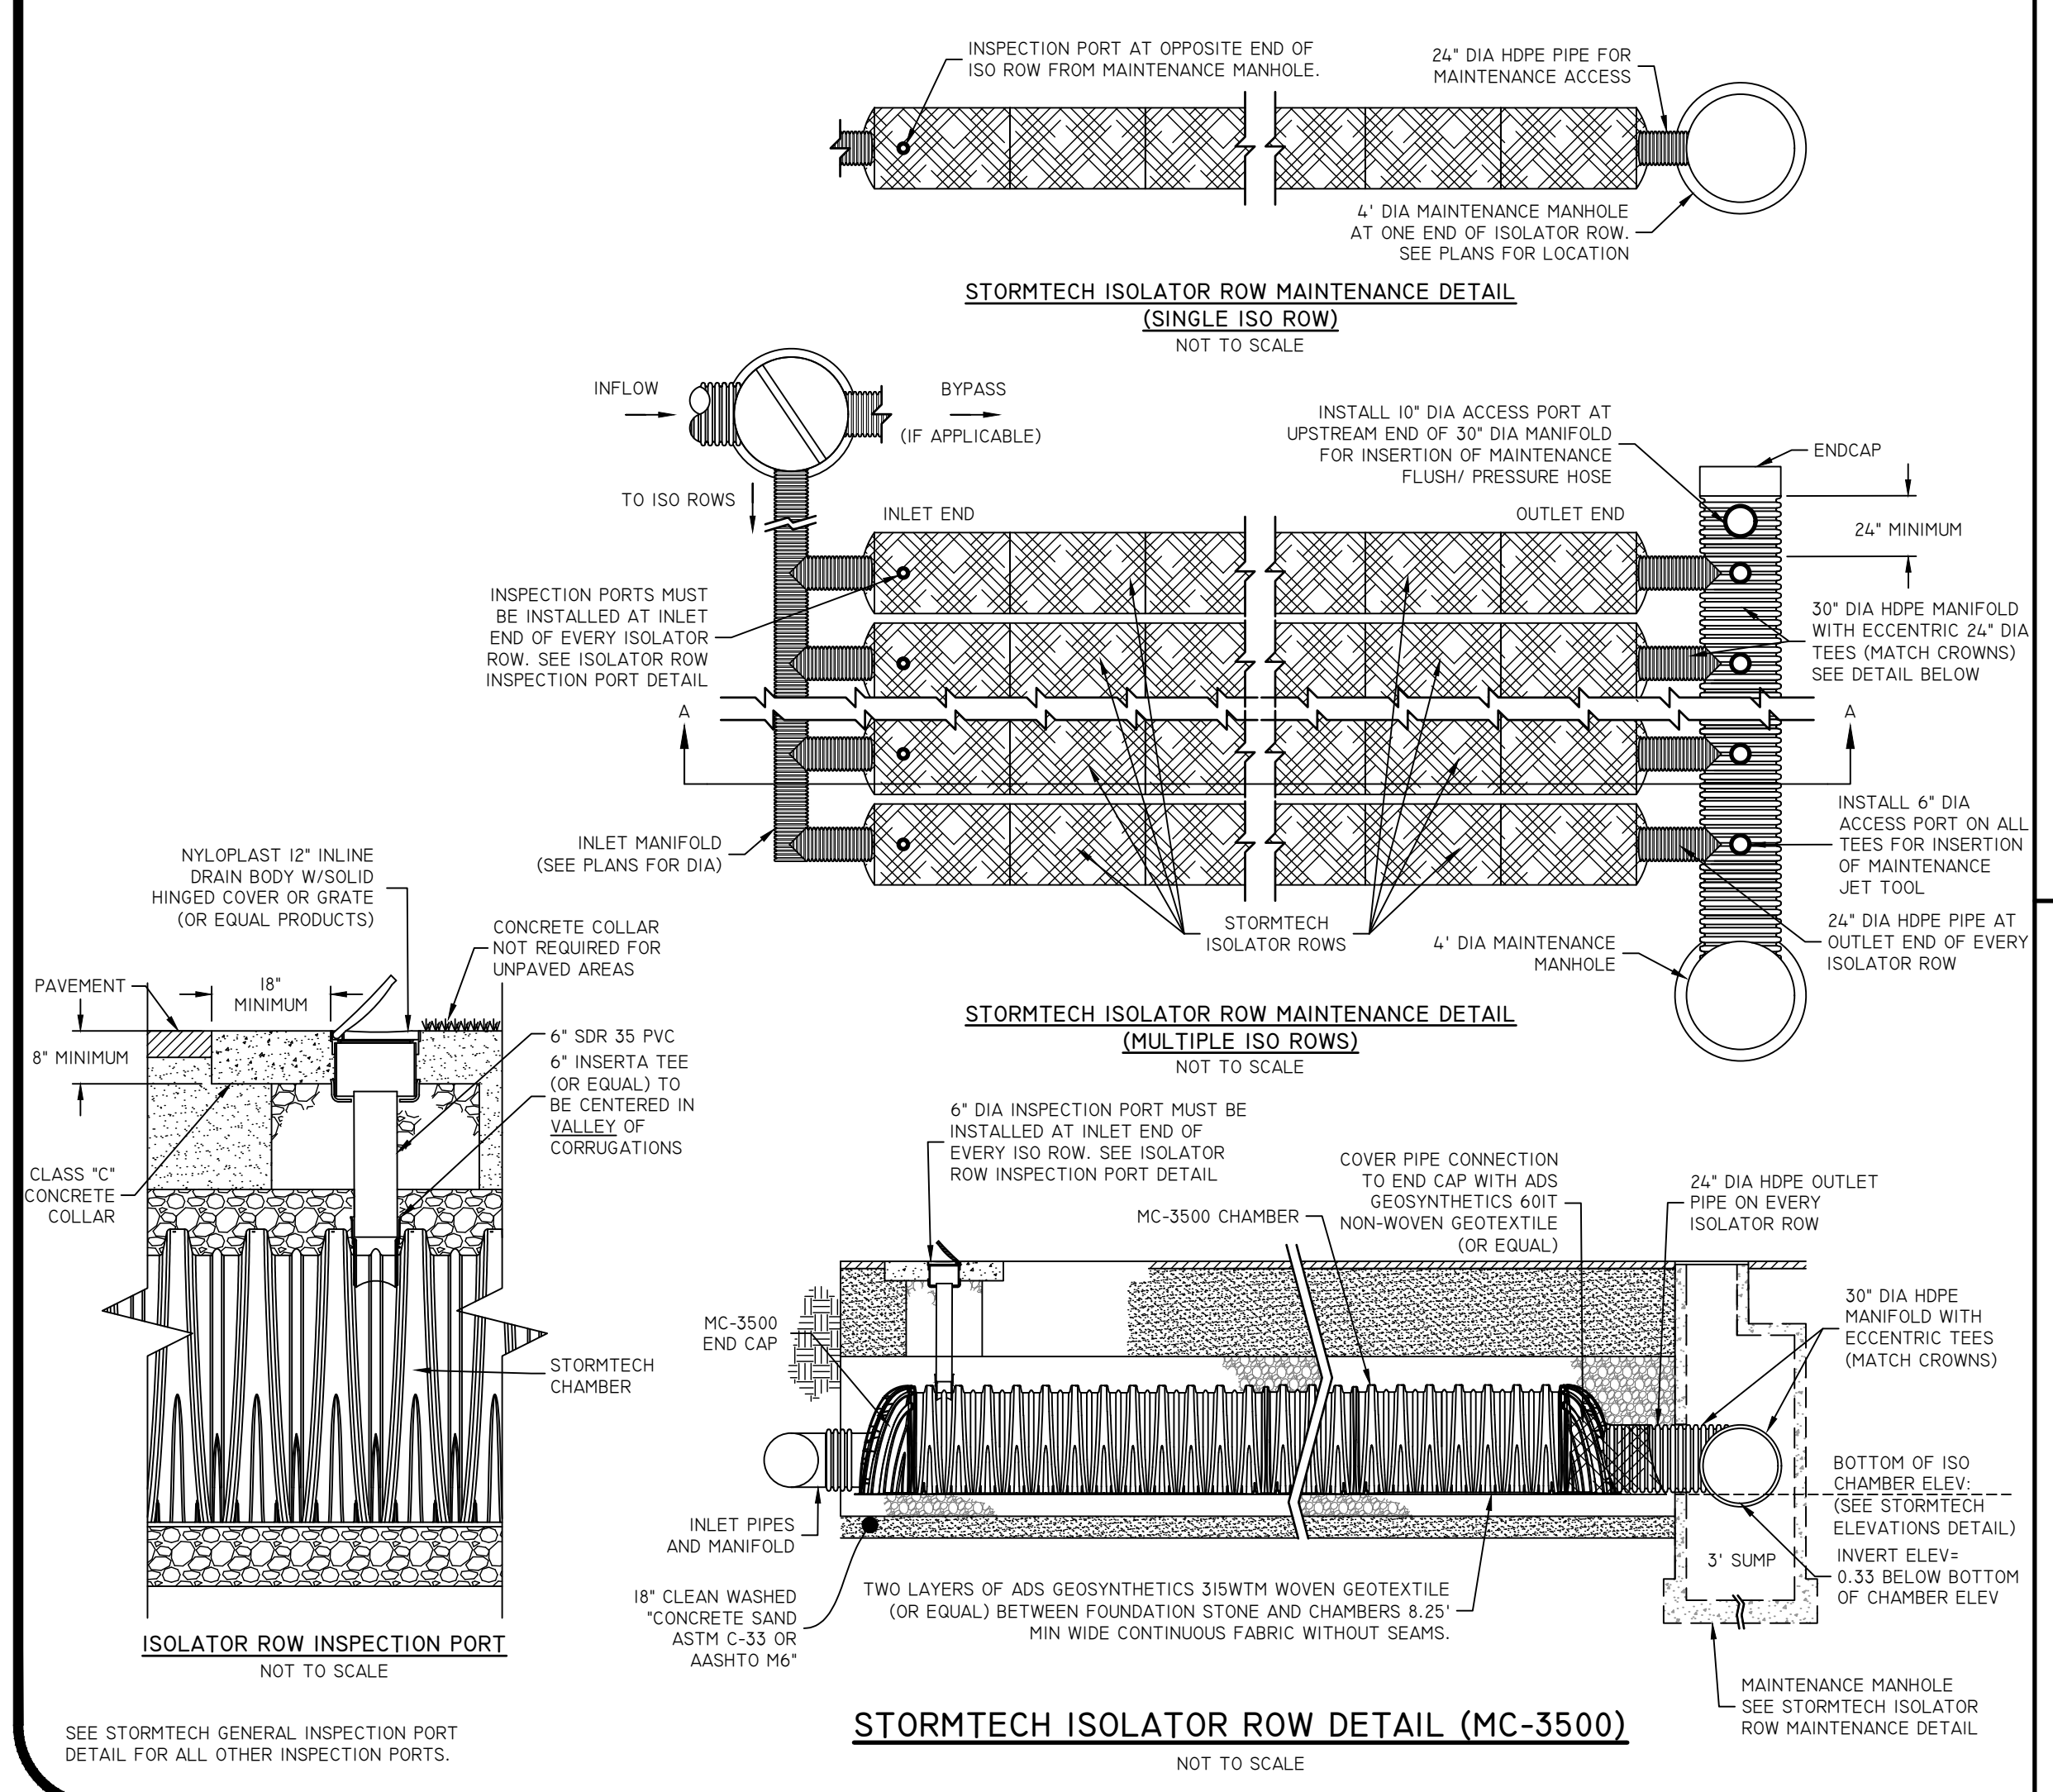


STORMTECH ISOLATOR ROW MAINTENANCE DETAIL (SINGLE ISO ROW)

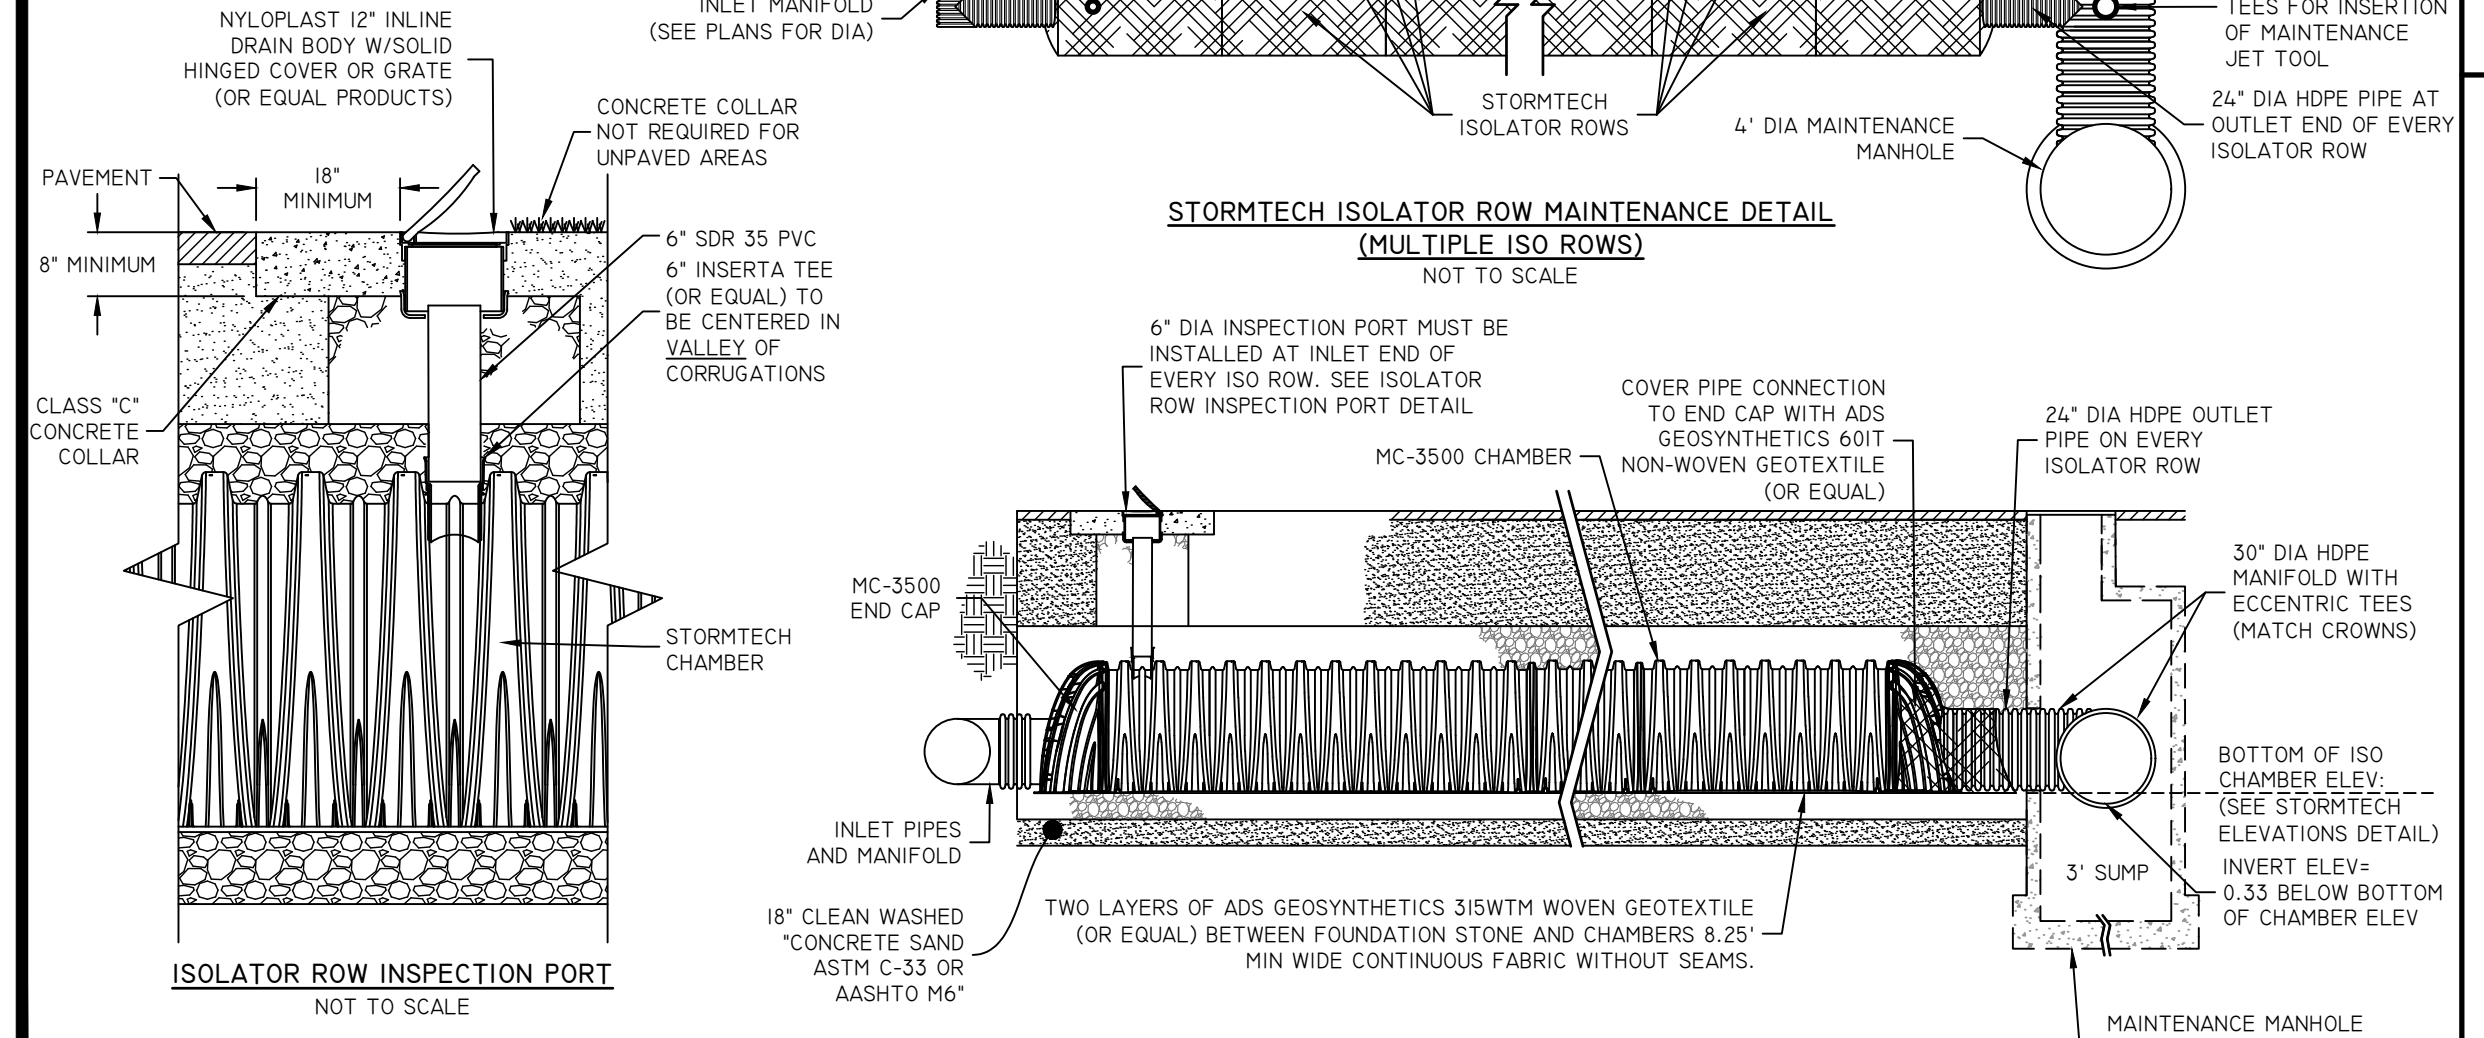


STORMTECH ISOLATOR ROW MAINTENANCE DETAIL (MULTIPLE ISO ROWS)

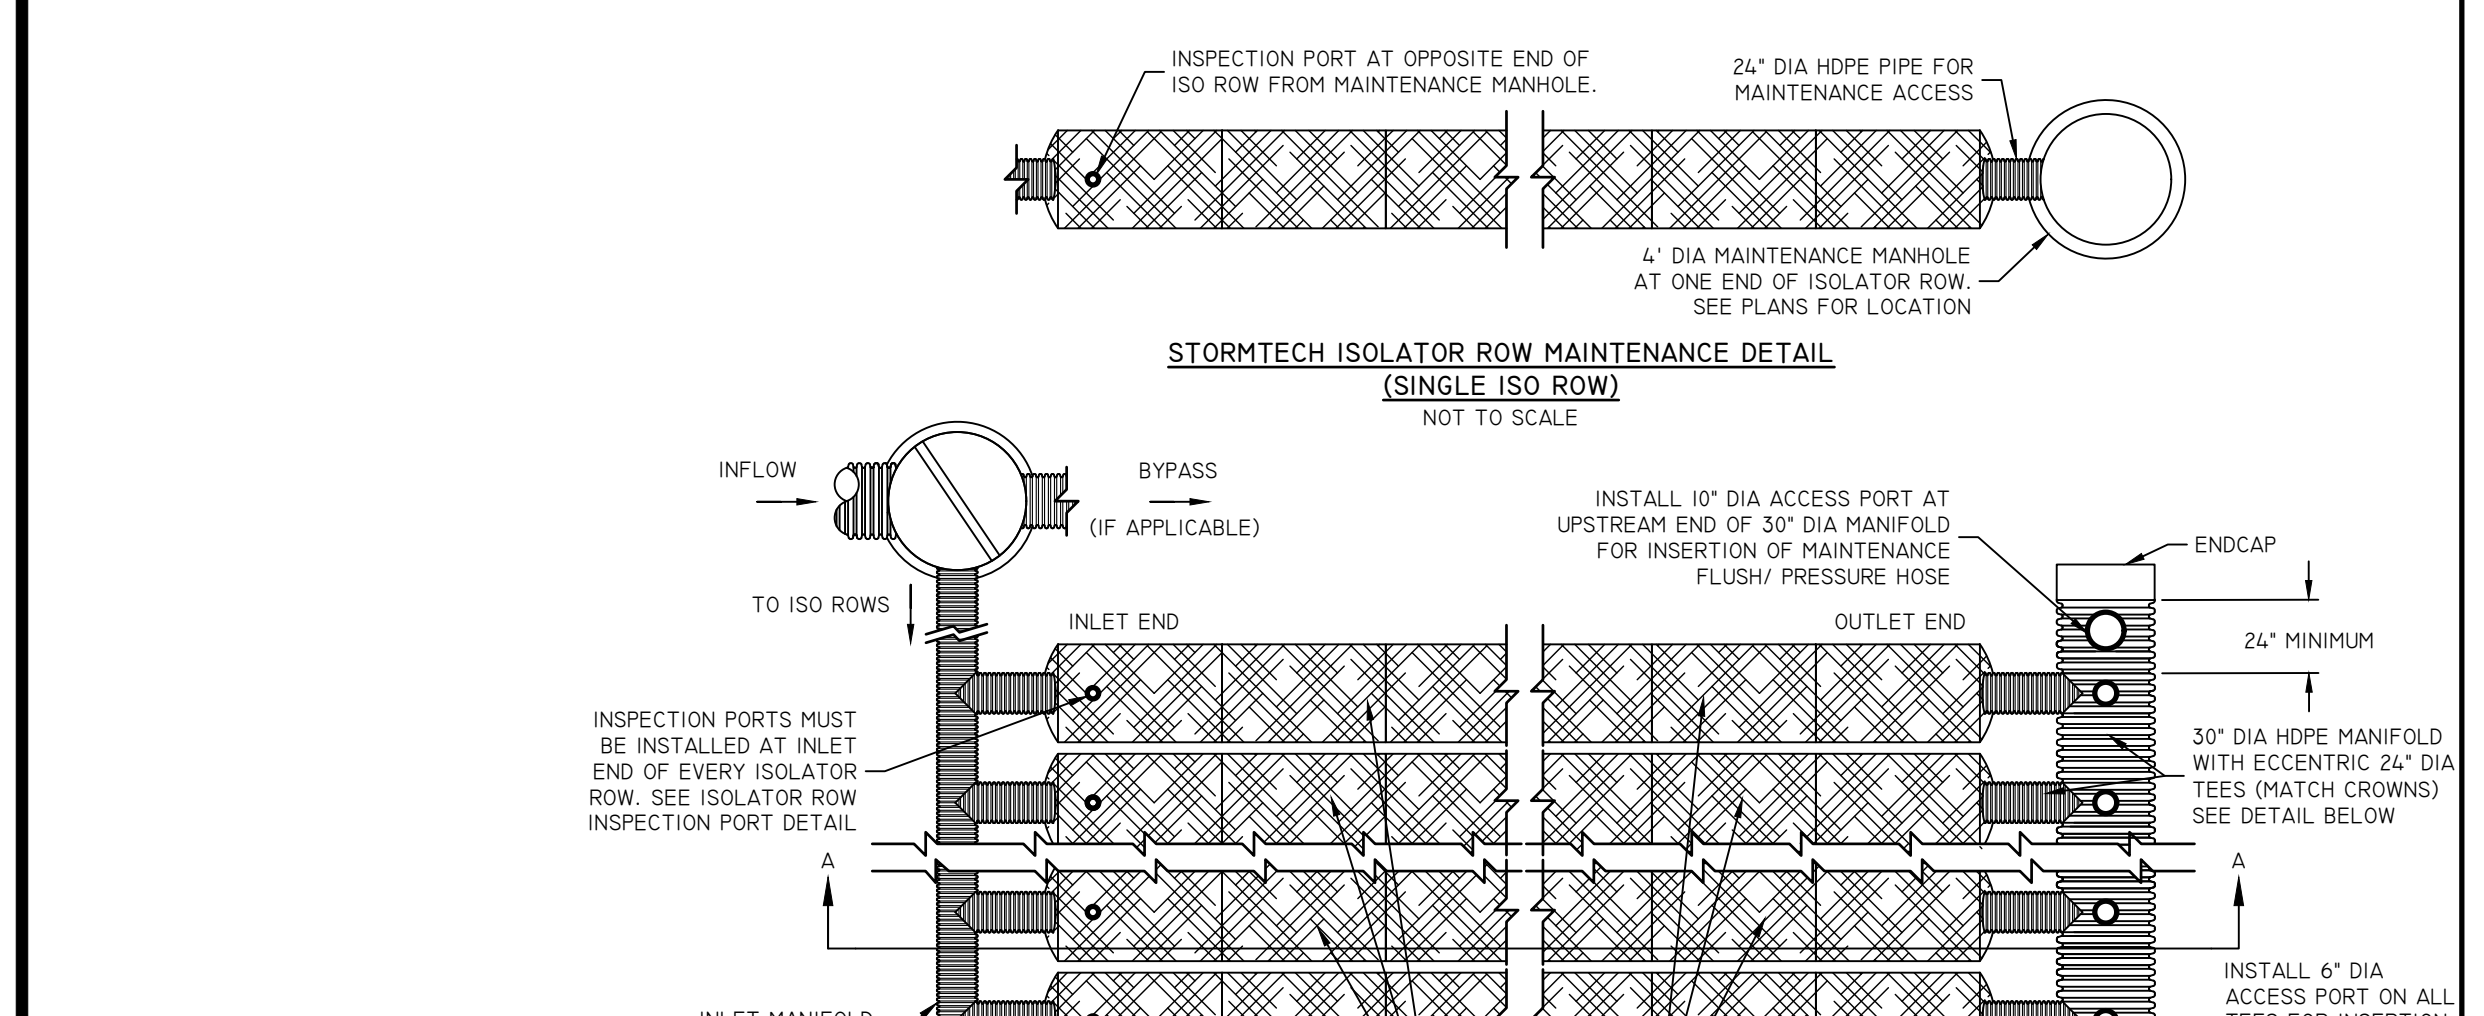


STORMTECH ISOLATOR ROW DETAIL (MC-3500)

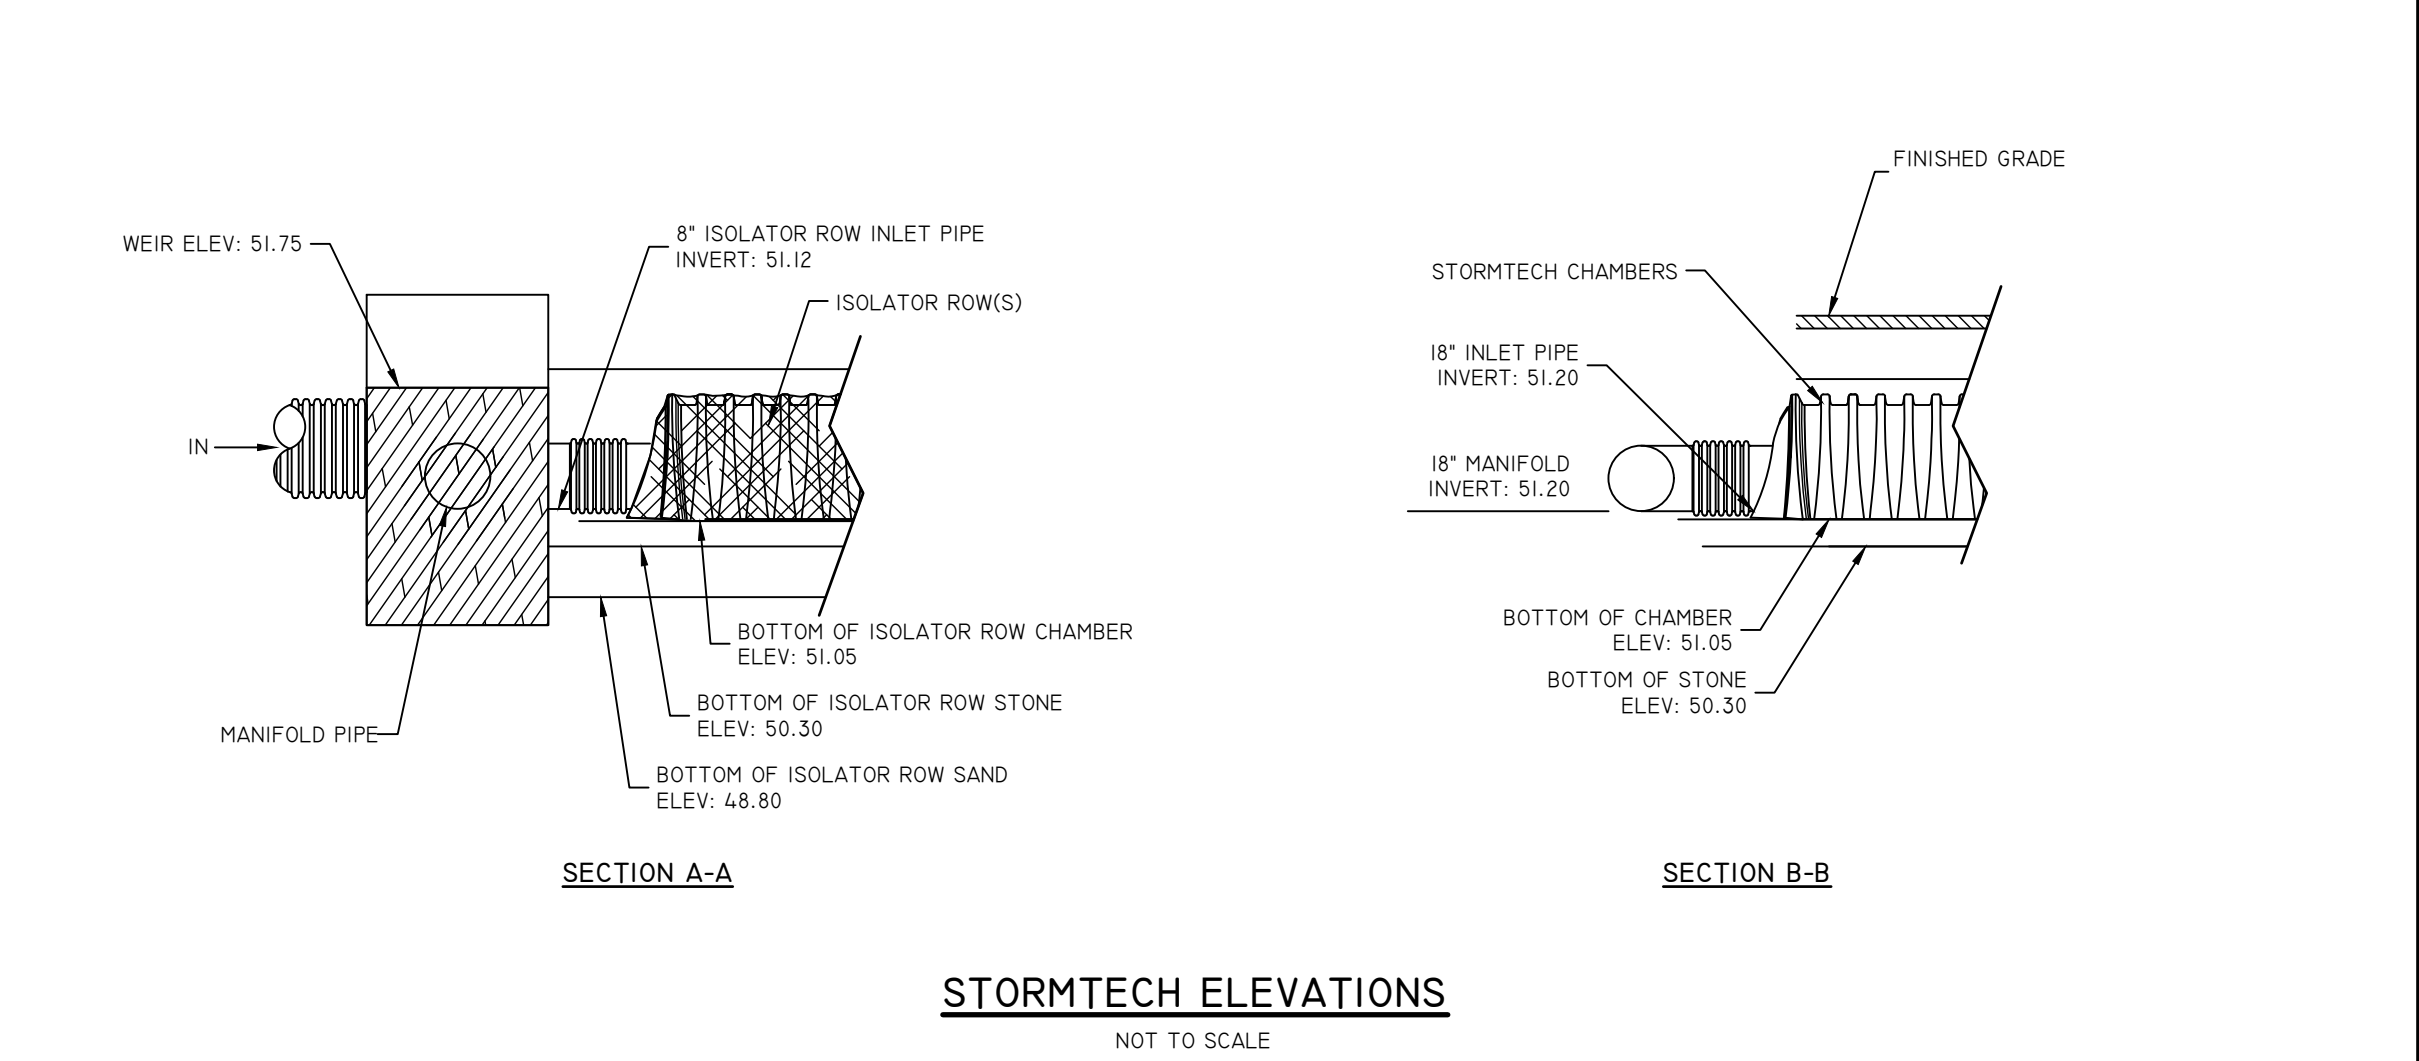


STORMTECH ELEVATIONS

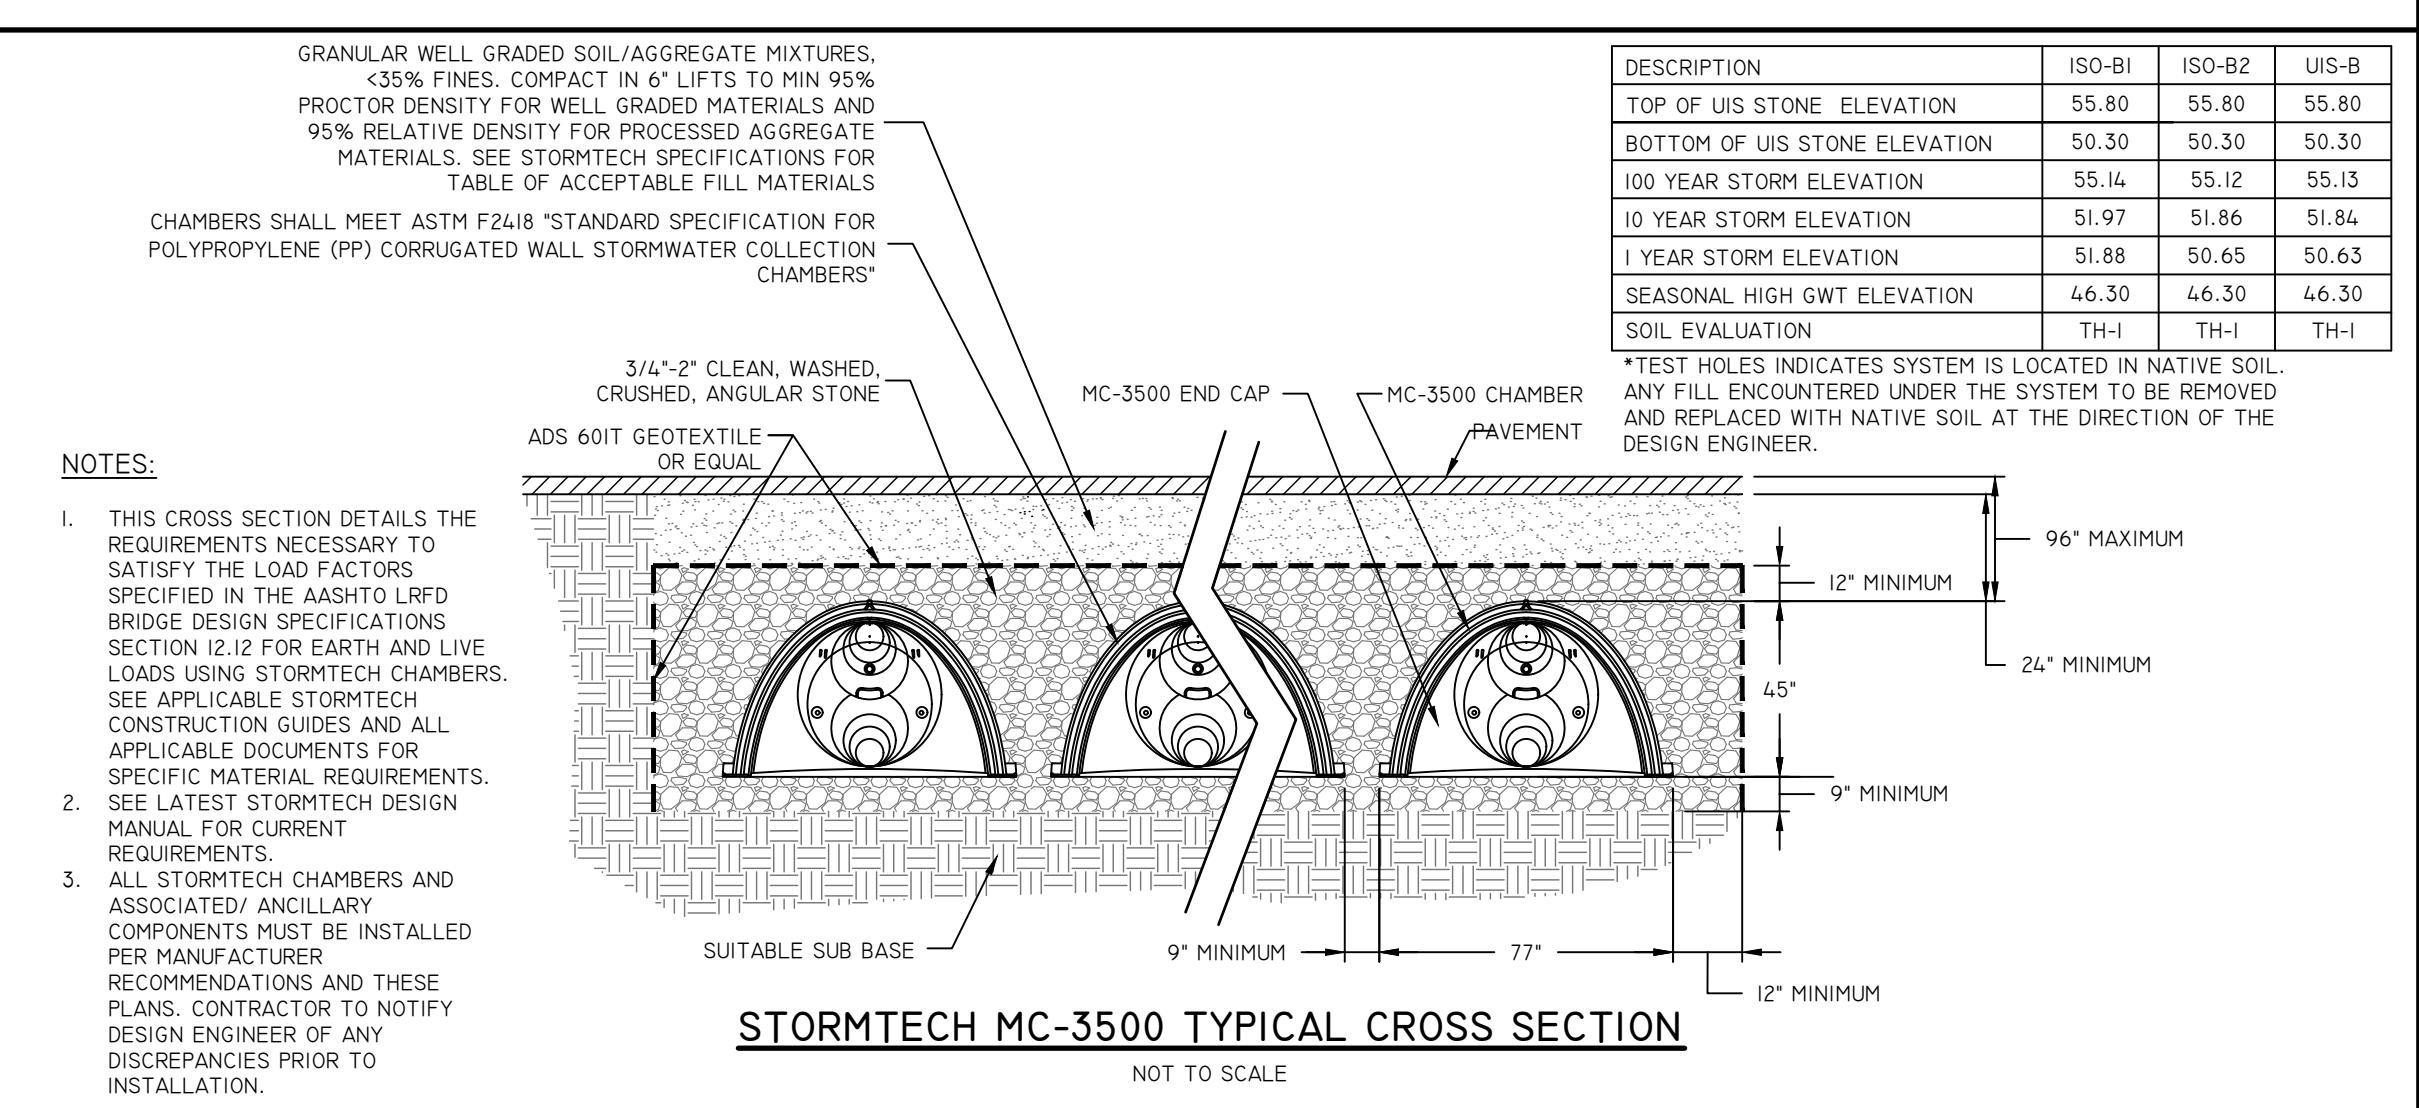

STORMTECH MC-3500 TYPICAL CROSS SECTION

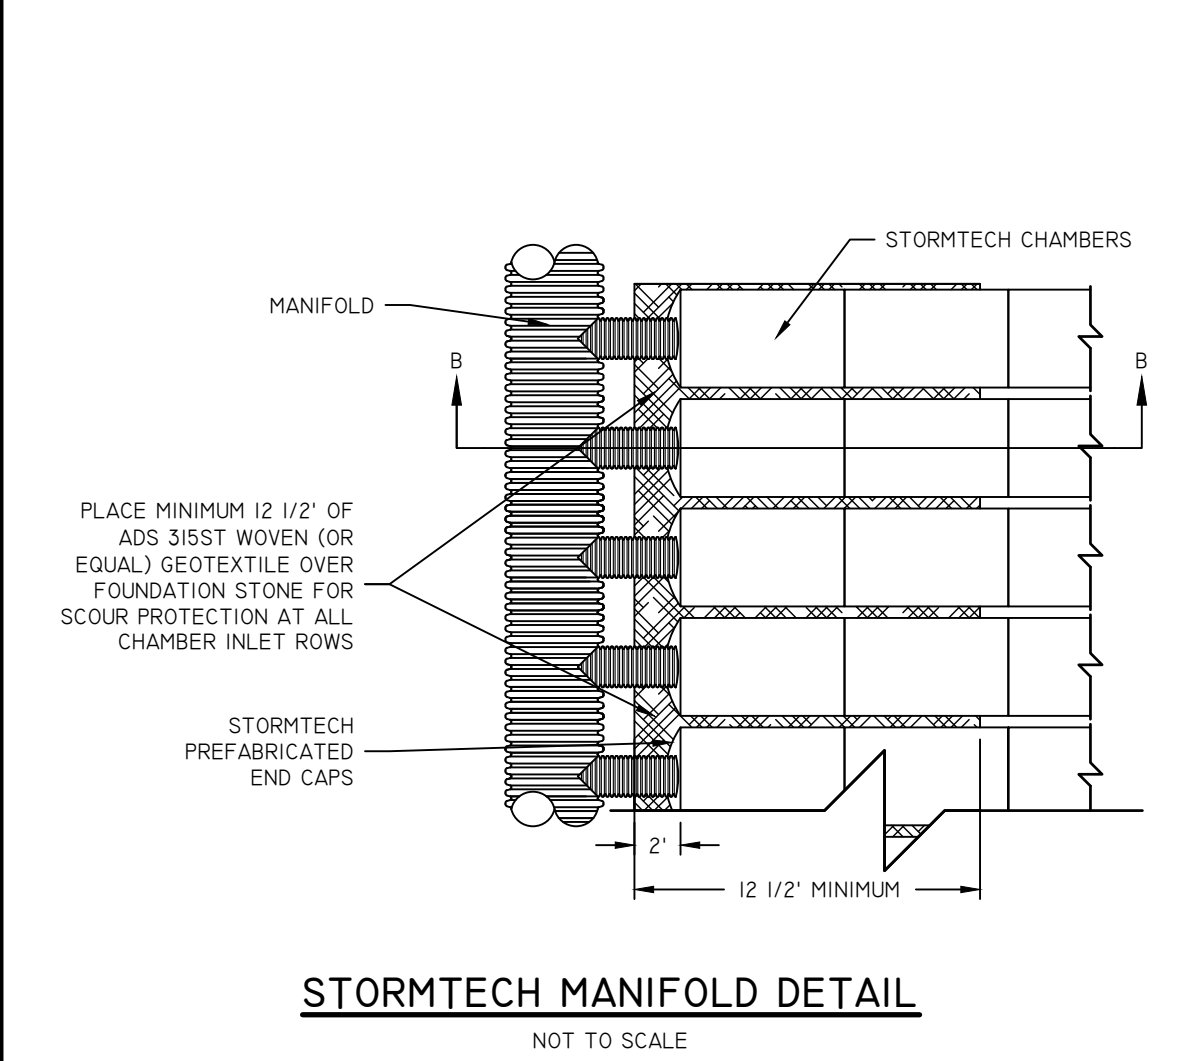

STORMTECH MANIFOLD DETAIL

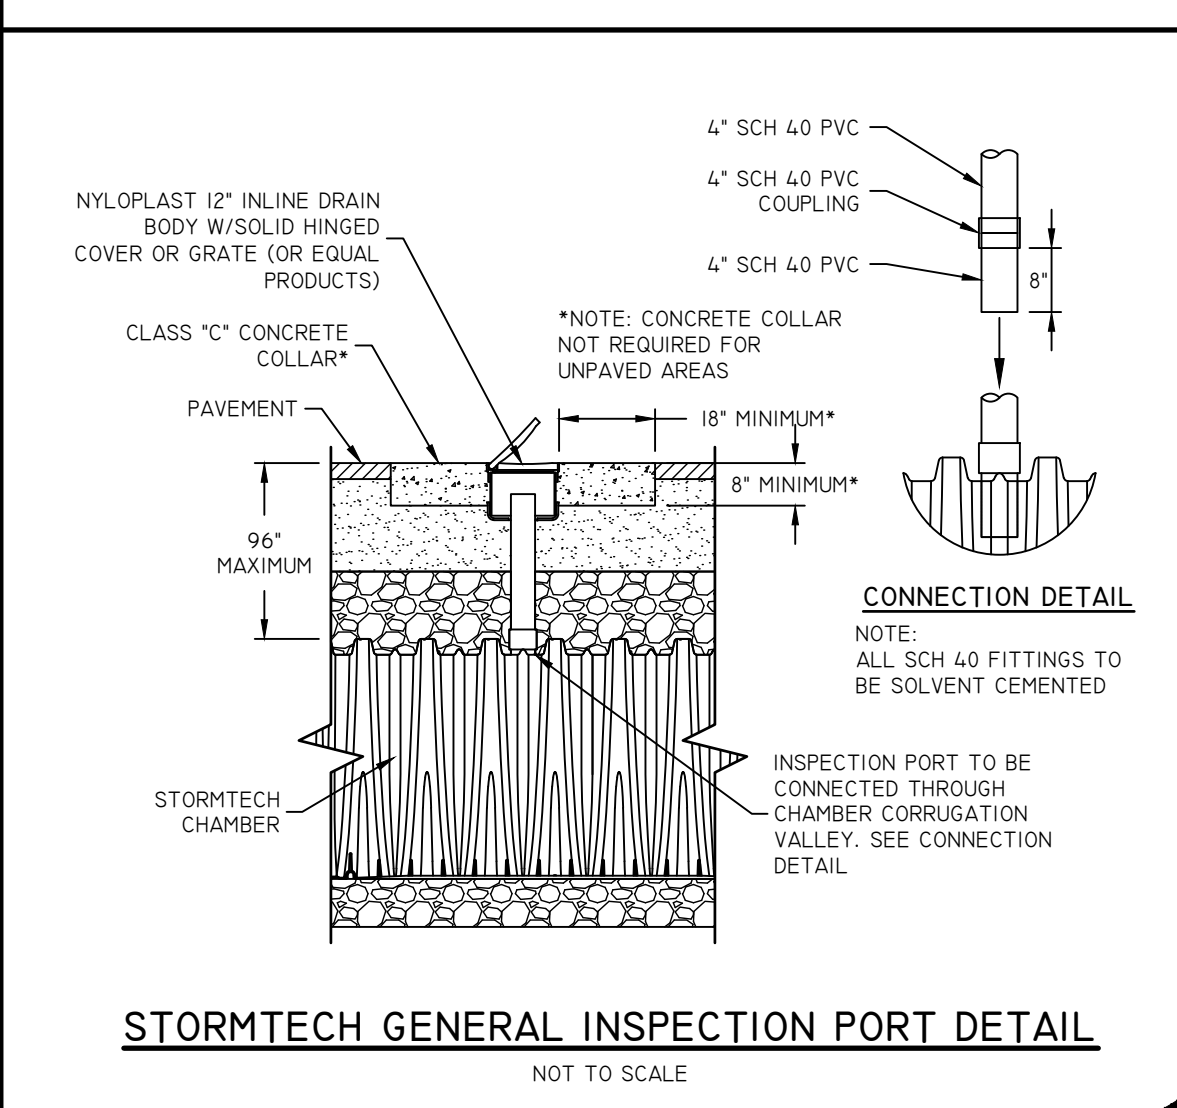

STORMTECH GENERAL INSPECTION PORT DETAIL

Diprete Engineering
 Two Stafford Court Cranston, RI 02920
 tel 401-943-1000 fax 401-644-6006 www.diprete-eng.com

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BRANDON D. CARR
 REGISTERED PROFESSIONAL ENGINEER
 CIVIL

THIS PLAN SET MUST NOT BE USED FOR CONSTRUCTION PURPOSES UNLESS IT IS APPROVED BY A REGISTERED PROFESSIONAL ENGINEER OF DIPRETE ENGINEERING.

DIPRETE ENGINEERING ON STAFFORDS PLANS HAS DESIGNATED BRANDON D. CARR AS THE REGISTERED PROFESSIONAL ENGINEER OF DIPRETE ENGINEERING. DIPRETE ENGINEERING IS NOT RESPONSIBLE FOR ANY ERRORS OR OMISSIONS IN THIS PLAN SET. THE CONTRACTOR IS RESPONSIBLE FOR ALL OF THE MEASUREMENTS, SURVEYING, AND FIELD DATA. DIPRETE ENGINEERING IS NOT RESPONSIBLE FOR ANY ERRORS OR OMISSIONS IN THIS PLAN SET. THE CONTRACTOR IS RESPONSIBLE FOR ALL OF THE MEASUREMENTS, SURVEYING, AND FIELD DATA. DIPRETE ENGINEERING IS NOT RESPONSIBLE FOR ANY ERRORS OR OMISSIONS IN THIS PLAN SET. THE CONTRACTOR IS RESPONSIBLE FOR ALL OF THE MEASUREMENTS, SURVEYING, AND FIELD DATA.



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3	05-24-2024	FINAL SUBMISSION	J.A.R.	J.A.R.

DESIGN BY: J.A.R.


UNDERGROUND INFILTRATION SYSTEM - B
POST ROAD APARTMENTS
 ASSessor'S PLAT 323 LOT 523
 WARWICK, RHODE ISLAND

PREPARED FOR:
SKYDRA DEVELOPMENT
 858 WASHINGTON STREET, SUITE #305, DEDHAM, MA 02026
 TEL 781-451-5600

DESIGN BY: J.A.R.

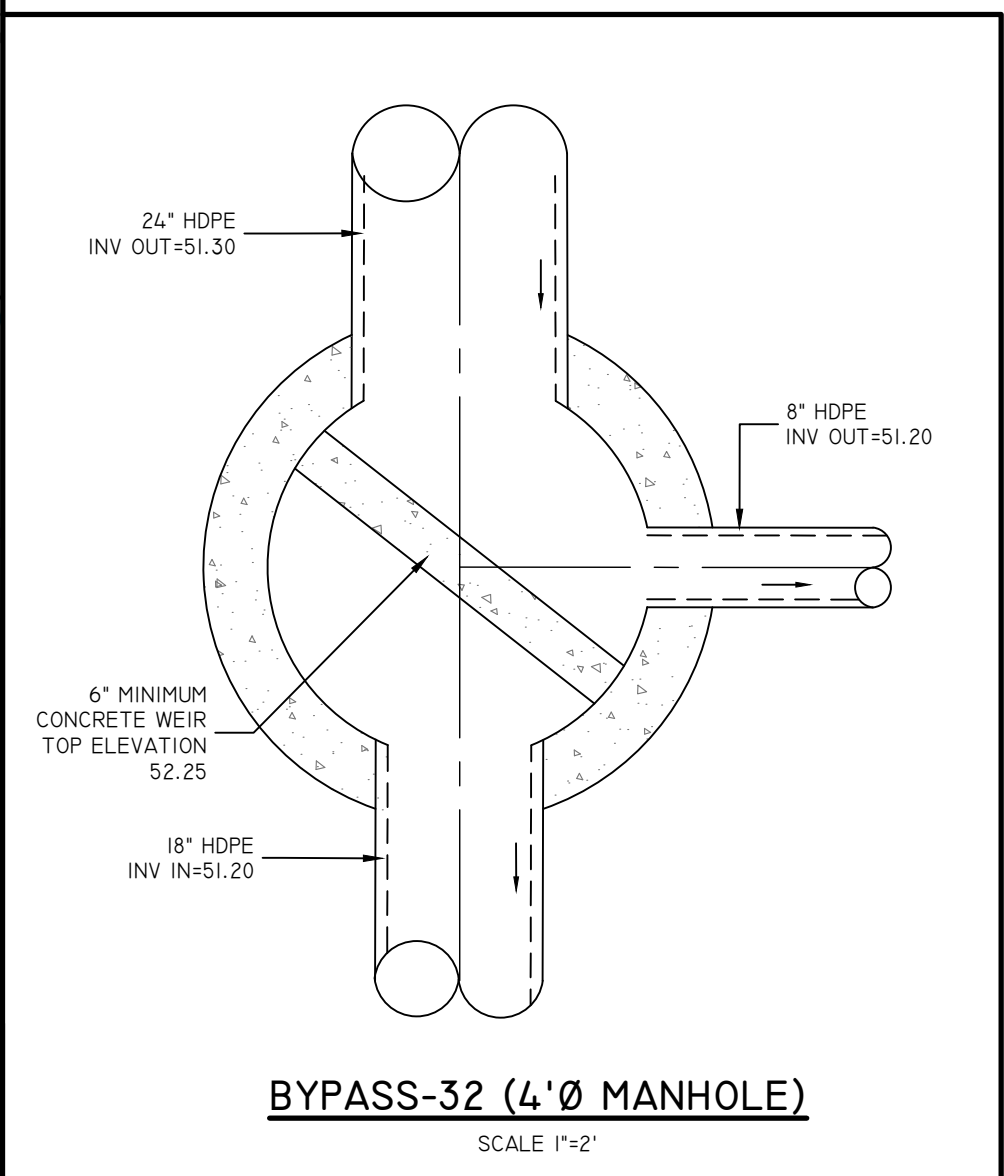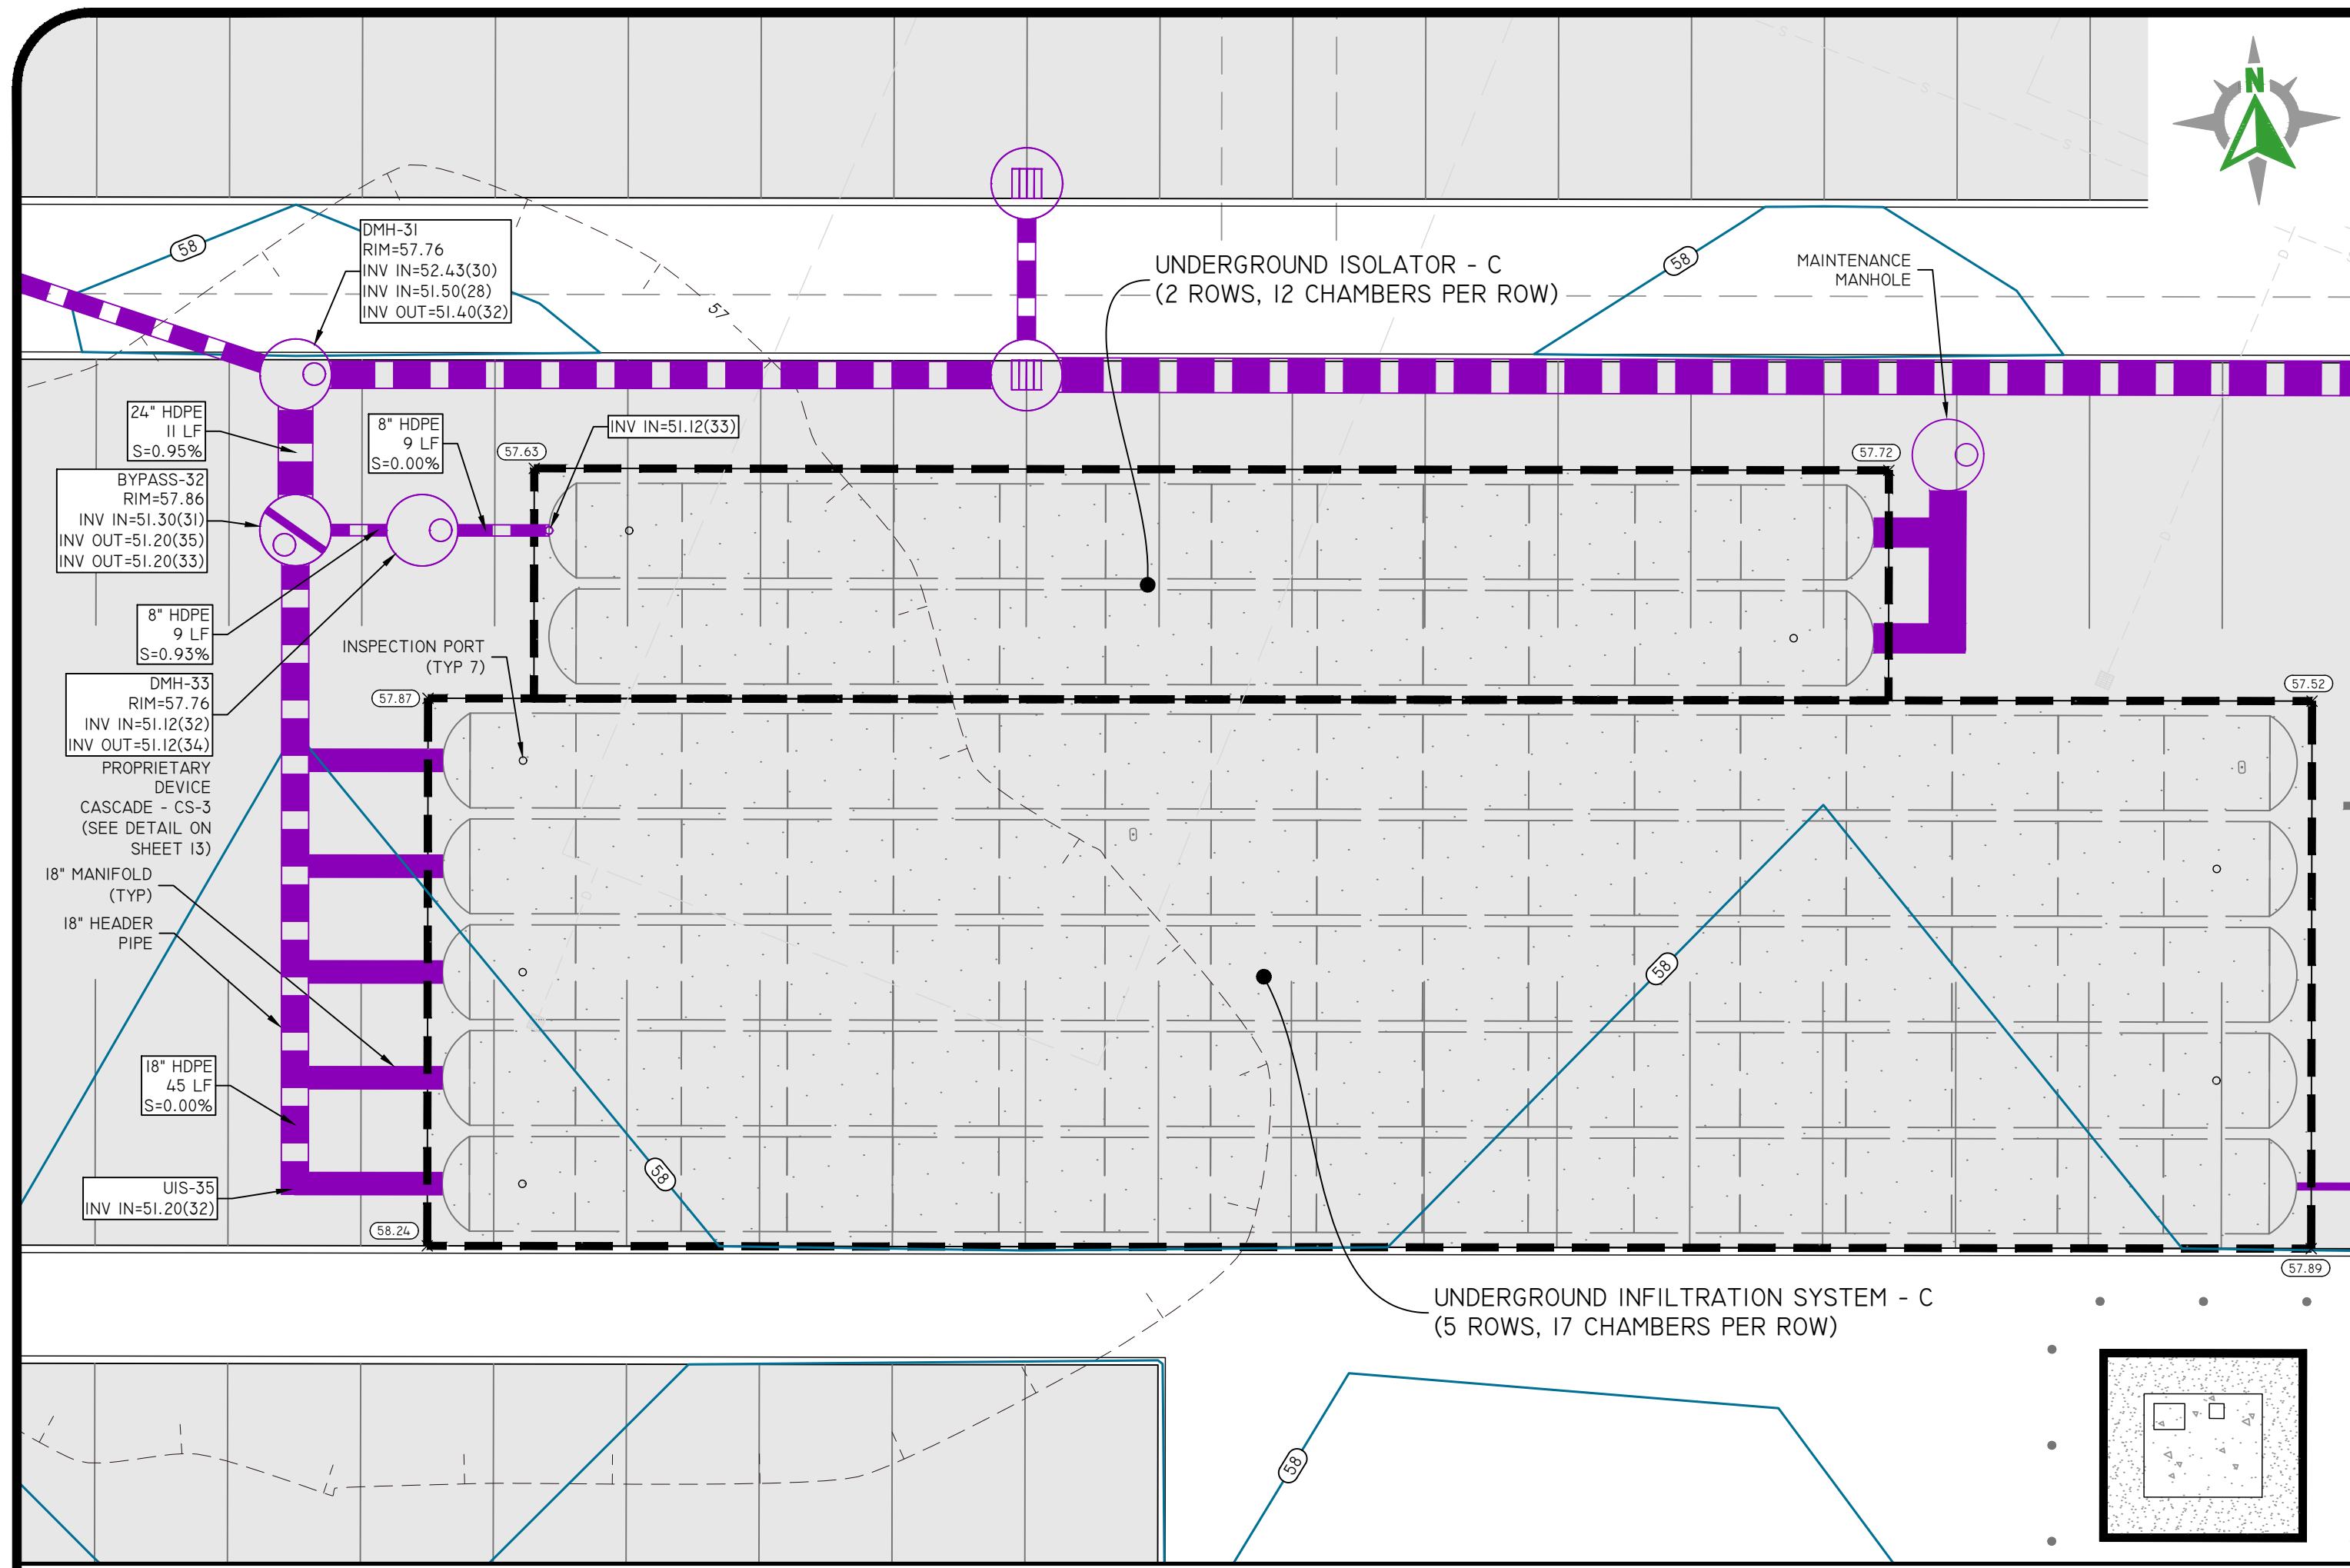


UNDERGROUND INFILTRATION SYSTEM - C (UIS-C)

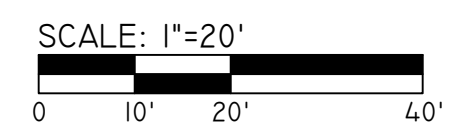

BYPASS-32 (4'Ø MANHOLE)


SCALE: 1"=2'

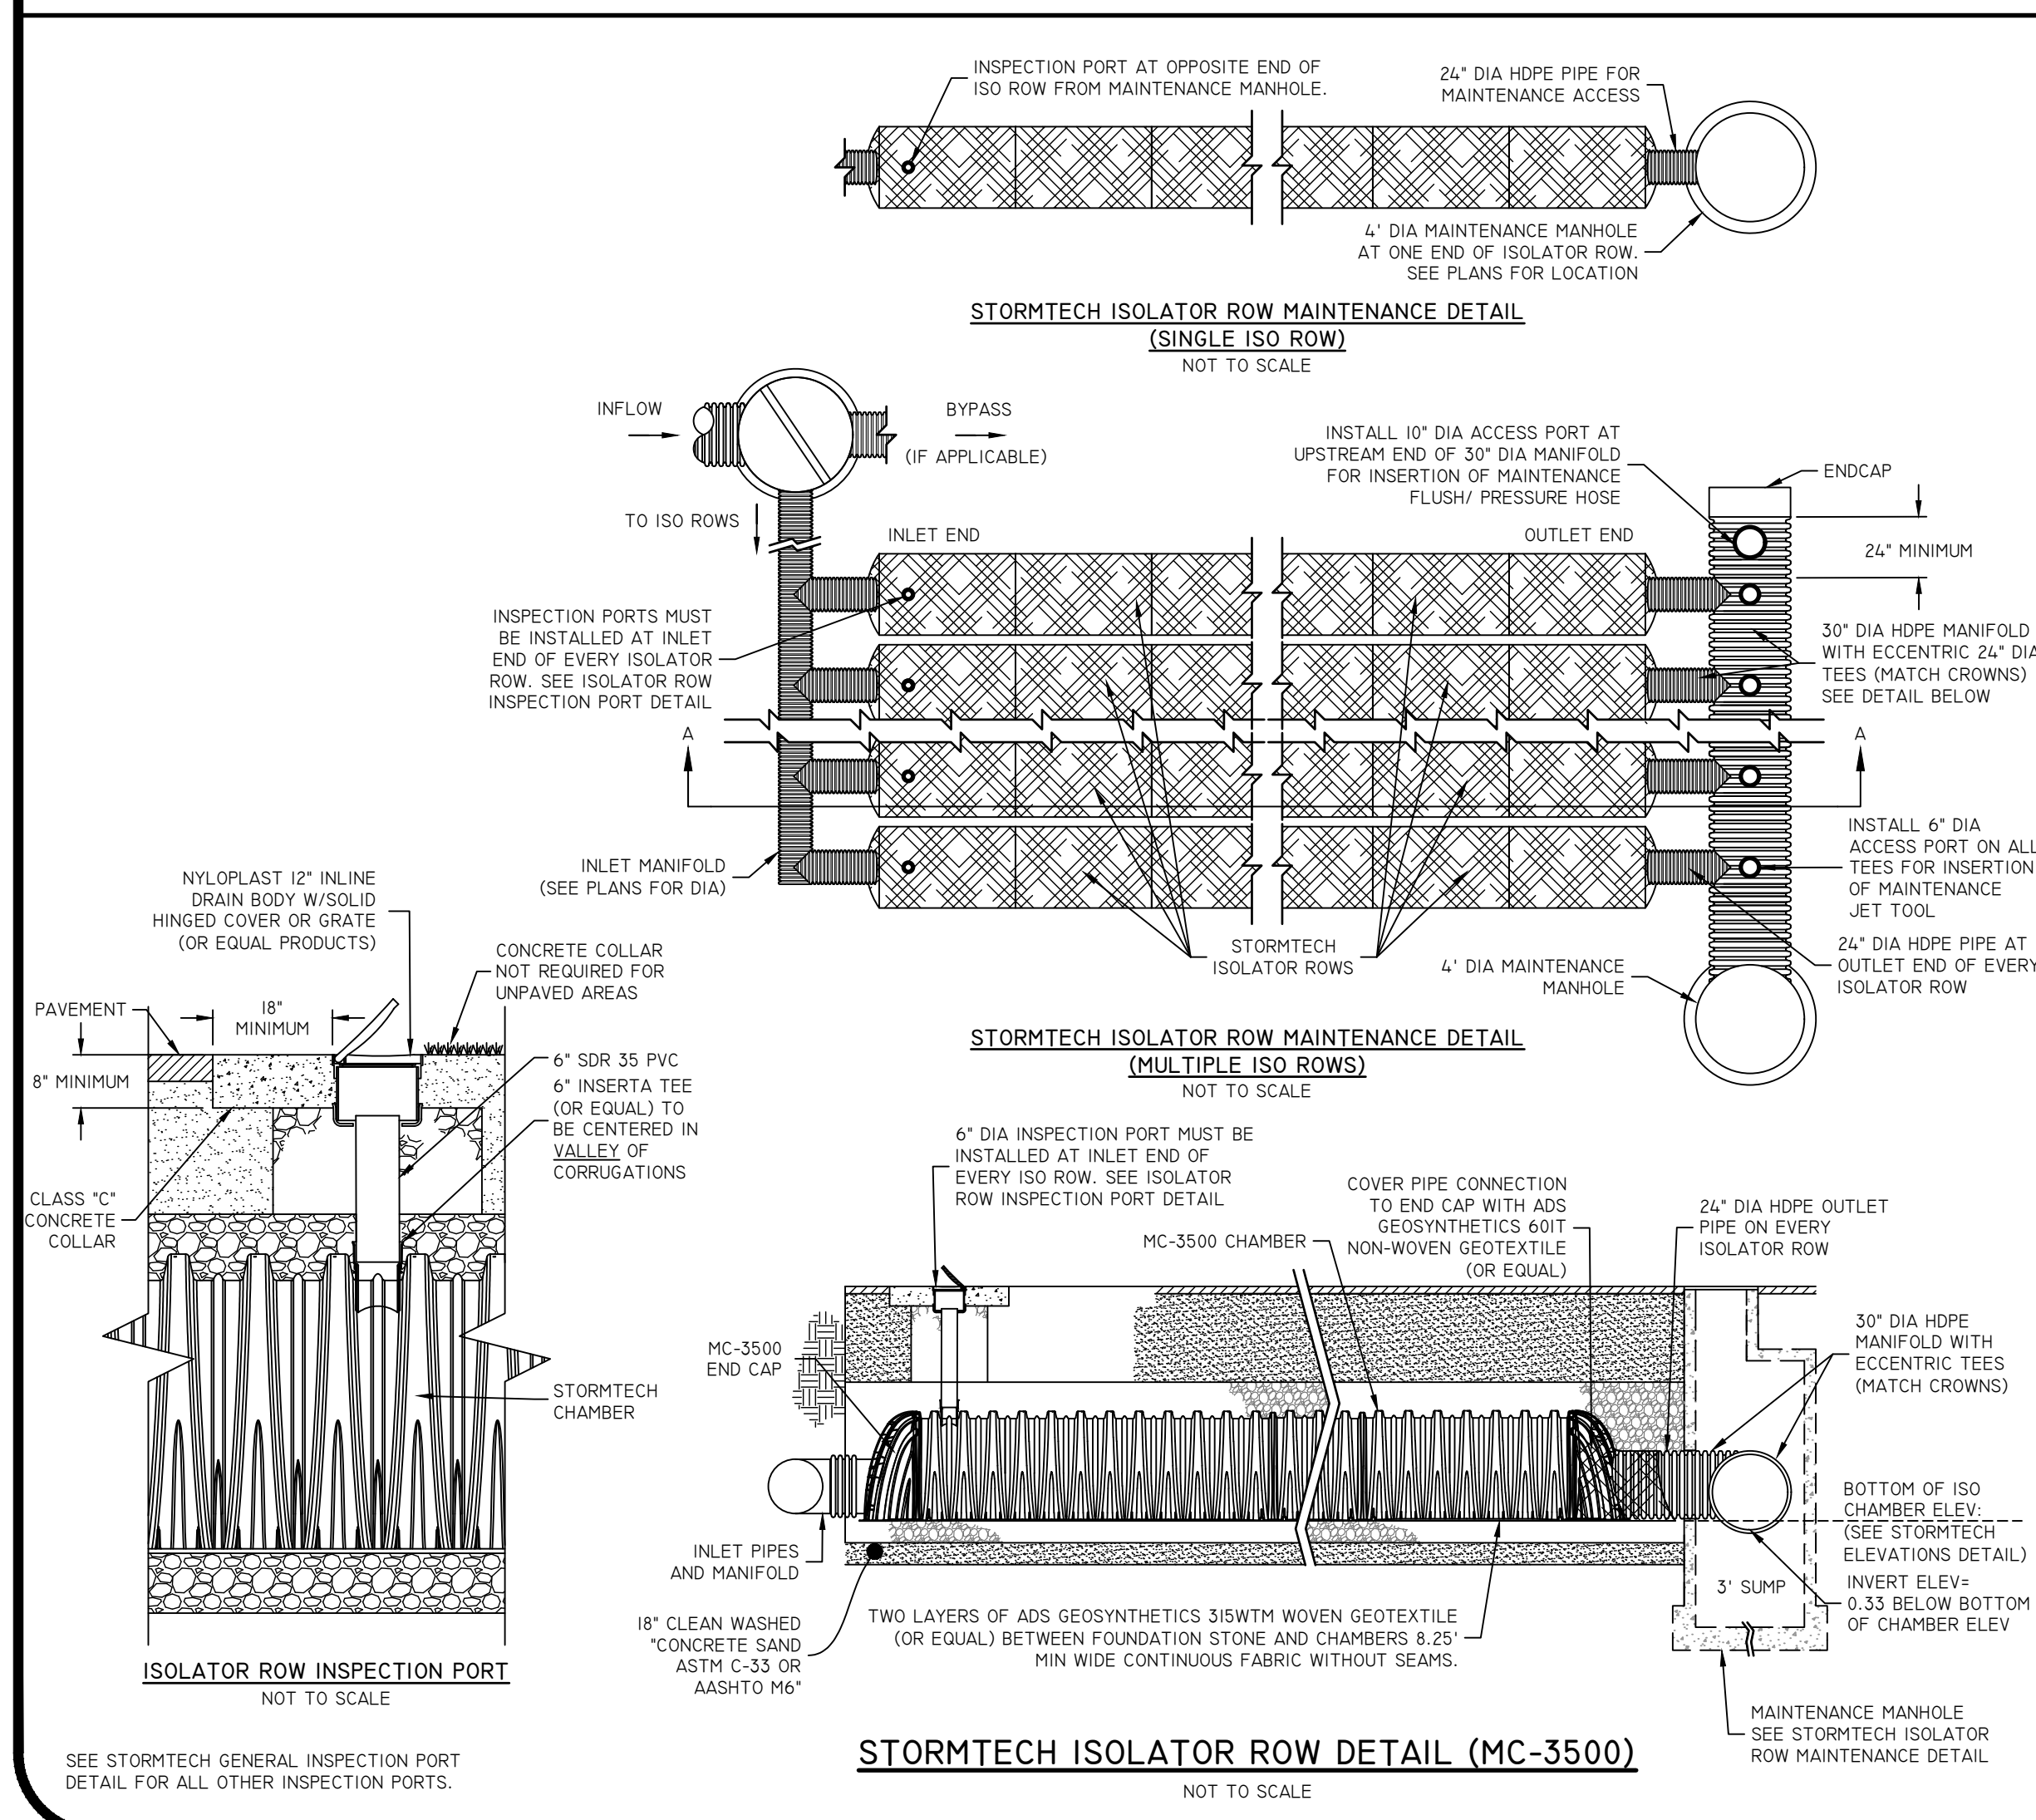


STORMTECH ISOLATOR ROW DETAIL (MC-3500)

STORMTECH ELEVATIONS

DESCRIPTION	ISO-C	UIS-C
TOP OF UIS STONE ELEVATION	55.80	55.80
BOTTOM OF UIS STONE ELEVATION	50.50	50.30
100 YEAR STORM ELEVATION	55.70	55.73
10 YEAR STORM ELEVATION	52.54	51.99
1 YEAR STORM ELEVATION	52.28	50.45
SEASONAL HIGH GWT ELEVATION	45.80	45.80
SOIL EVALUATION	TH-2	TH-2

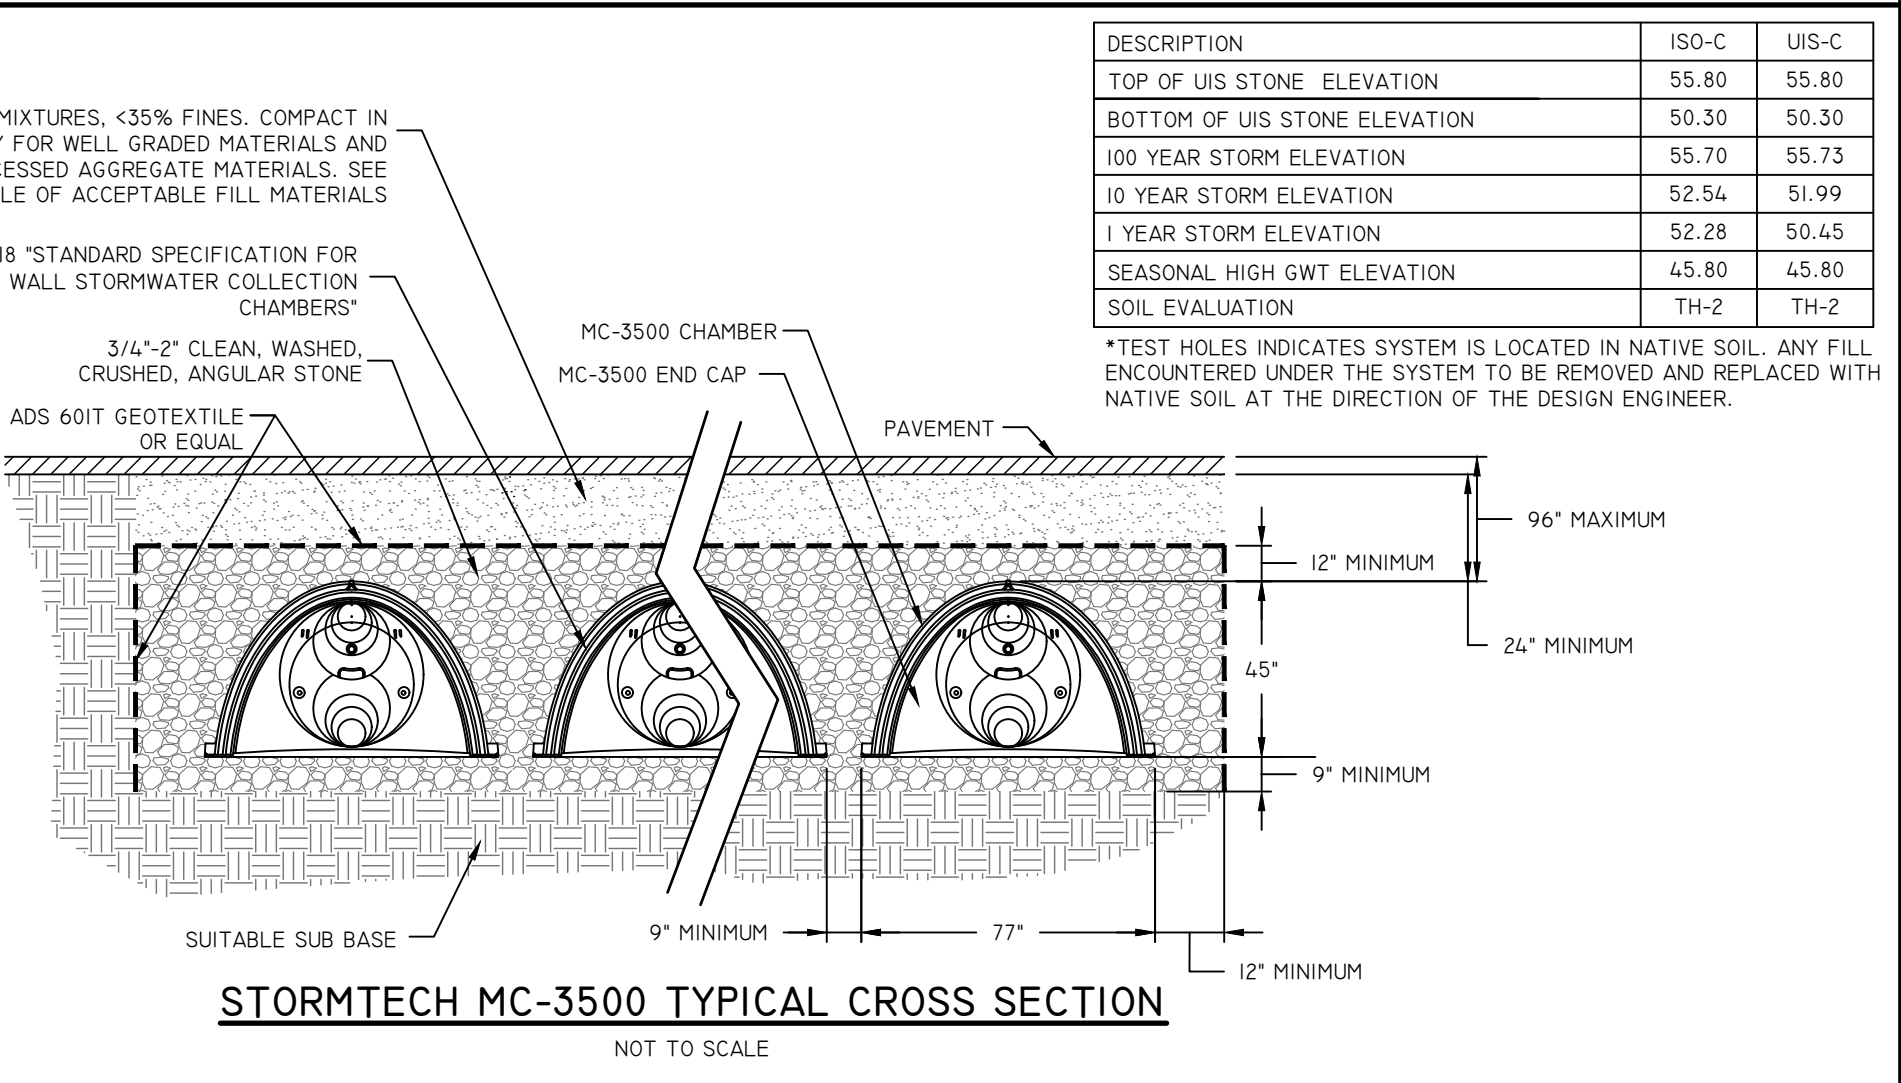

STORMTECH MC-3500 TYPICAL CROSS SECTION

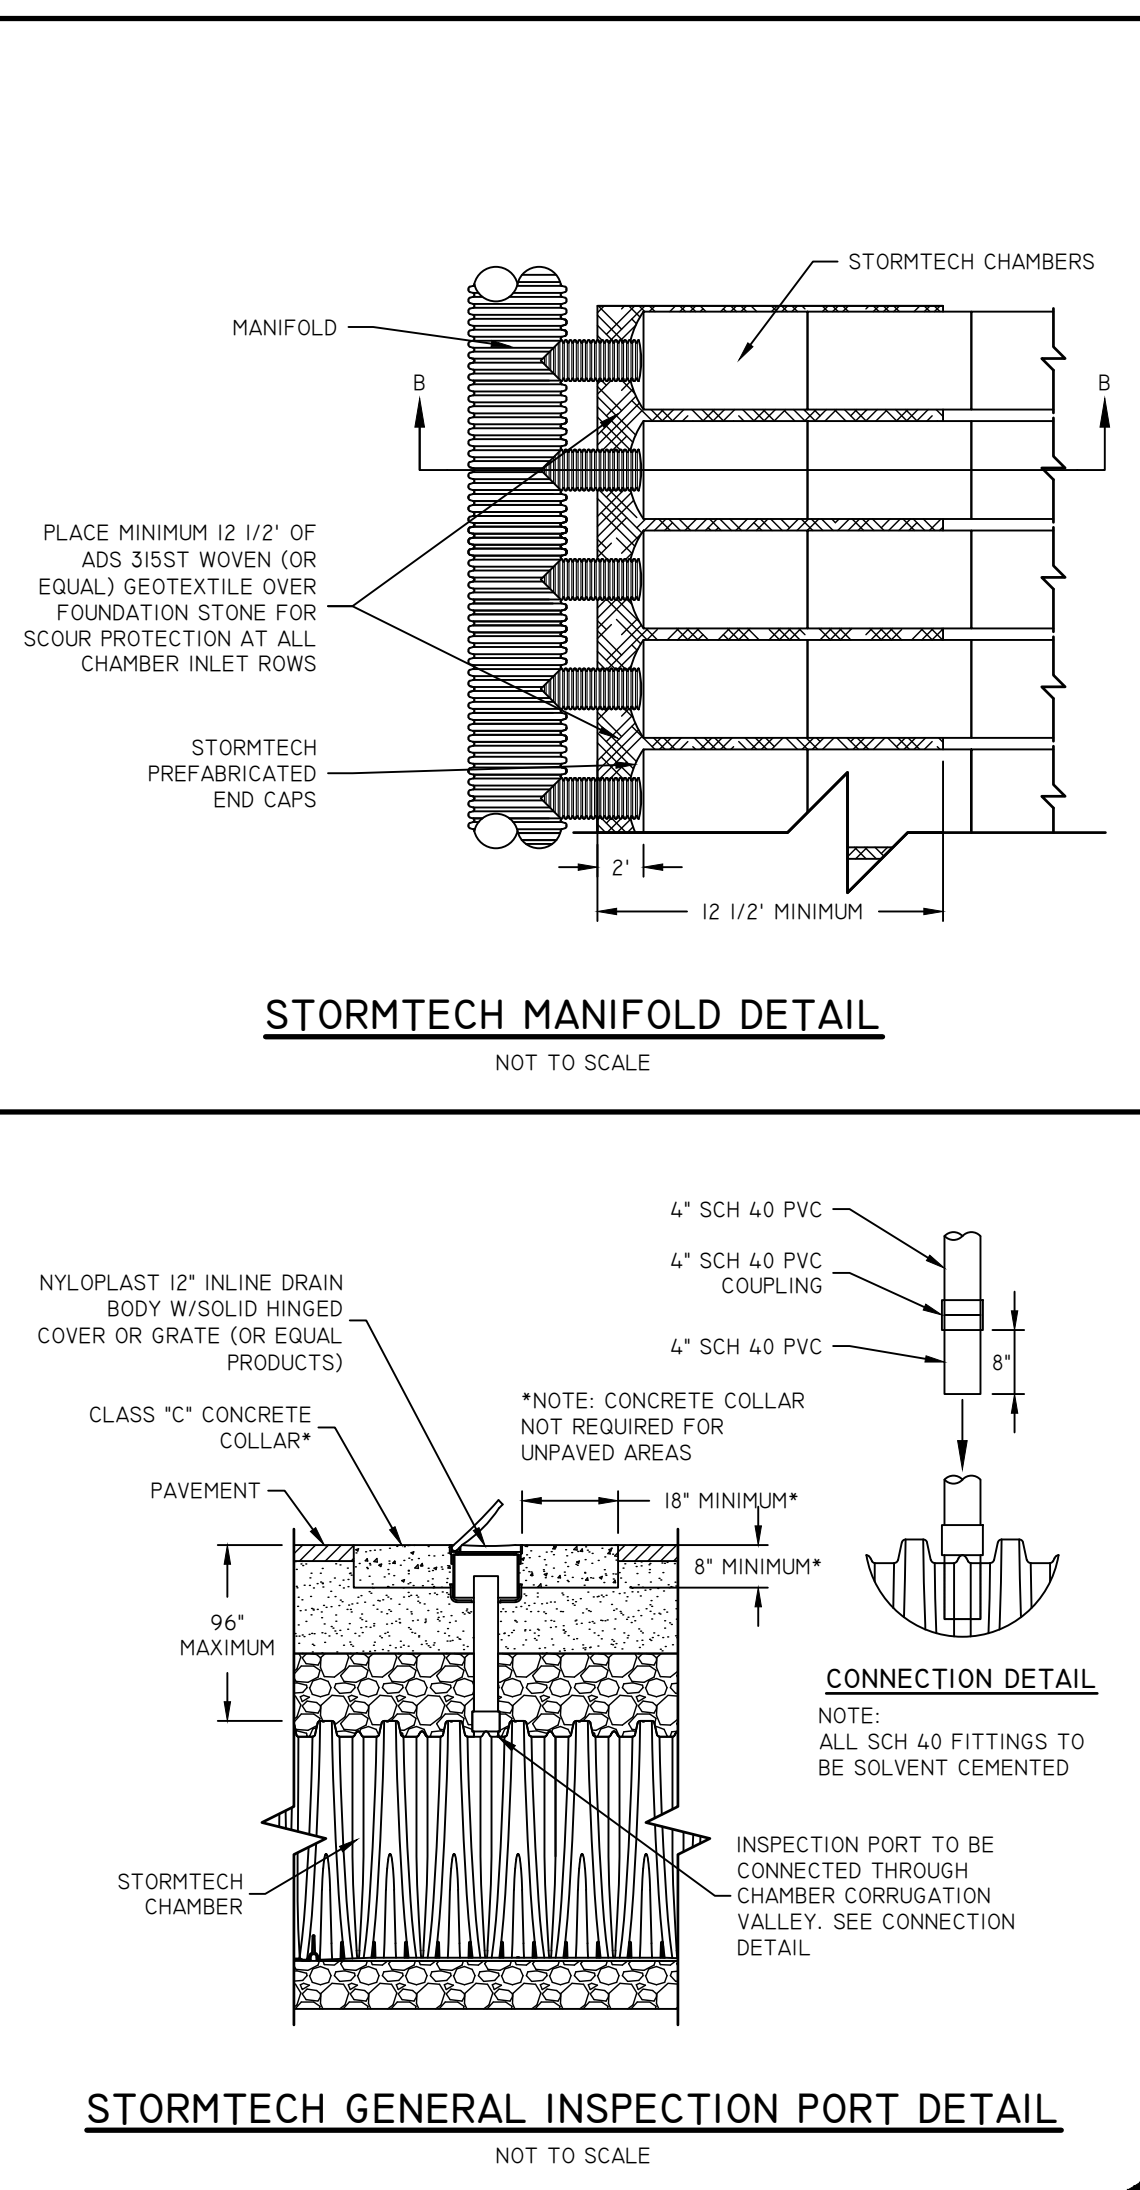

STORMTECH MANIFOLD DETAIL

STORMTECH GENERAL INSPECTION PORT DETAIL

2. DEHAMPROJECTS\2625-018 POST ROAD 2109 AUTOCAD DRAWINGS\2625-018-BPMS.DWG PLOTTED: 5/24/2023

Diprete Engineering
Two Starford Court Cranston, RI 02920
tel: 401-943-1000 fax: 401-664-6006 www.diprete-eng.com

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BRANDON D. CARR

REGISTERED PROFESSIONAL ENGINEER CIVIL

THIS PLAN SET MUST NOT BE USED FOR CONSTRUCTION PURPOSES UNLESS IT IS APPROVED BY THE REGISTERED PROFESSIONAL ENGINEER OF DIPRETE ENGINEERING.

DIPRETE ENGINEERING ON STAFF: BRANDON D. CARR, REGISTERED PROFESSIONAL ENGINEER OF DIPRETE ENGINEERING. DIPRETE ENGINEERING IS AN EQUAL OPPORTUNITY EMPLOYER. THE CONTRACTOR IS RESPONSIBLE FOR ALL OF THE MEANS, METHODS, SAFETY PRECAUTIONS AND REQUIREMENTS AND OSHA DESIGN. LIABILITY IN THE IMPLEMENTATION OF THIS PLAN AND EXISTING UTILITIES SHOWN ON THIS PLAN ARE APPROXIMATE. FOR A COMPLETE LIST OF UTILITIES, CONTACT THE UTILITIES DEPARTMENT OF THE TOWN OF DEHAM, RI. SEE UTILITY NOTE ON SHEET 11.


NO.	DATE	DESCRIPTION	BY:	CHK:
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3	05-24-2023	FINAL SUBMISSION	J.A.R.	

DESIGN BY: J.A.R.



UNDERGROUND INFILTRATION SYSTEM - C
POST ROAD APARTMENTS
 ASSessor'S PLAT 323 LOT 523
 WARWICK, RHODE ISLAND

PREPARED FOR:
SKYDRA DEVELOPMENT
 858 WASHINGTON STREET, SUITE #305, DEHAM, RI 02026
 TEL: 781-451-5600

DATE: 05-24-2023
 PROJECT: 2625-018-BPMS
 DRAWN BY: J.A.R.

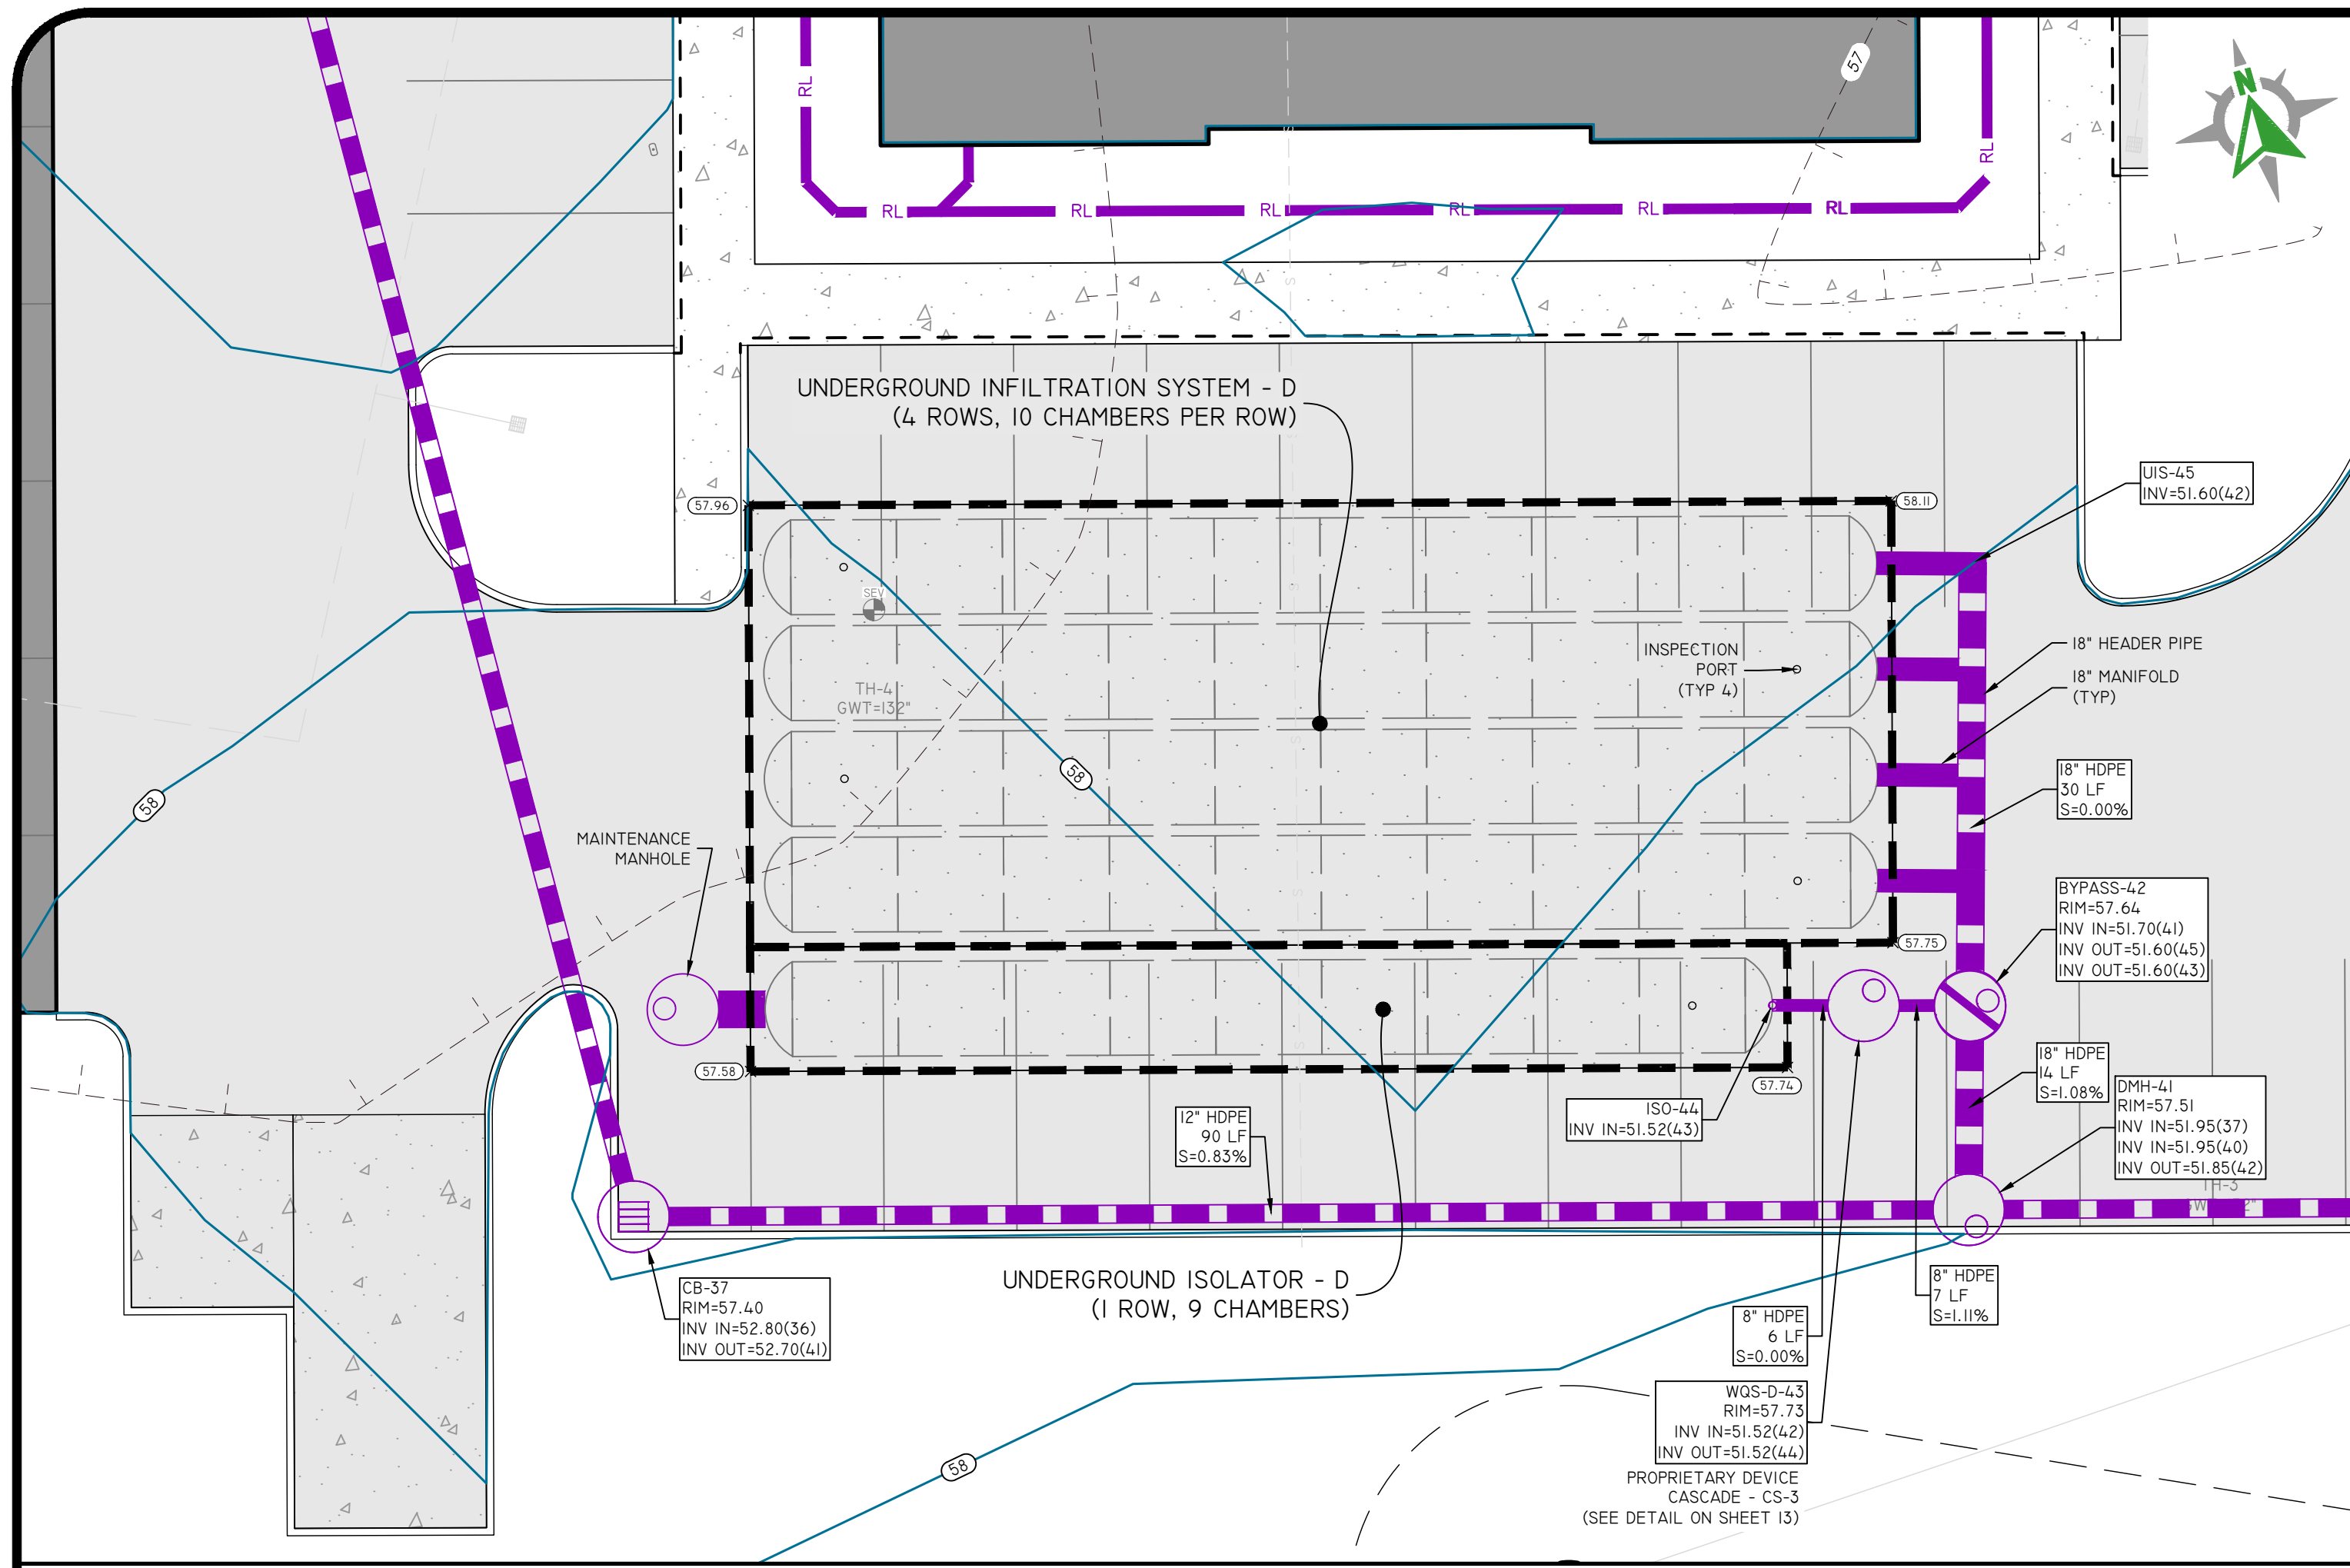


UNDERGROUND INFILTRATION SYSTEM - D (UIS-D)

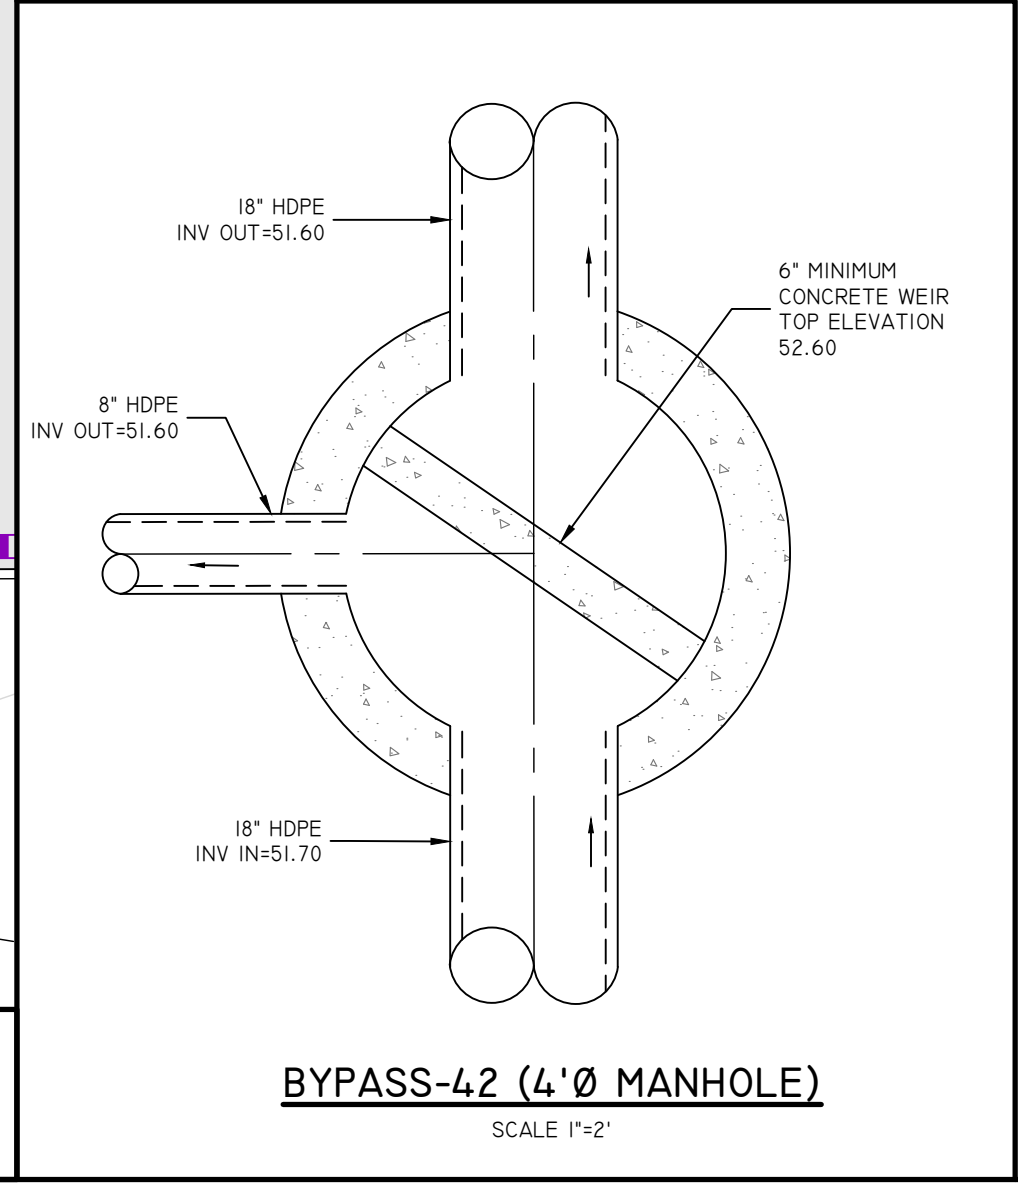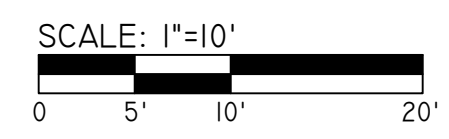


BYPASS-42 (4' Ø MANHOLE)

SCALE: 1"=2'

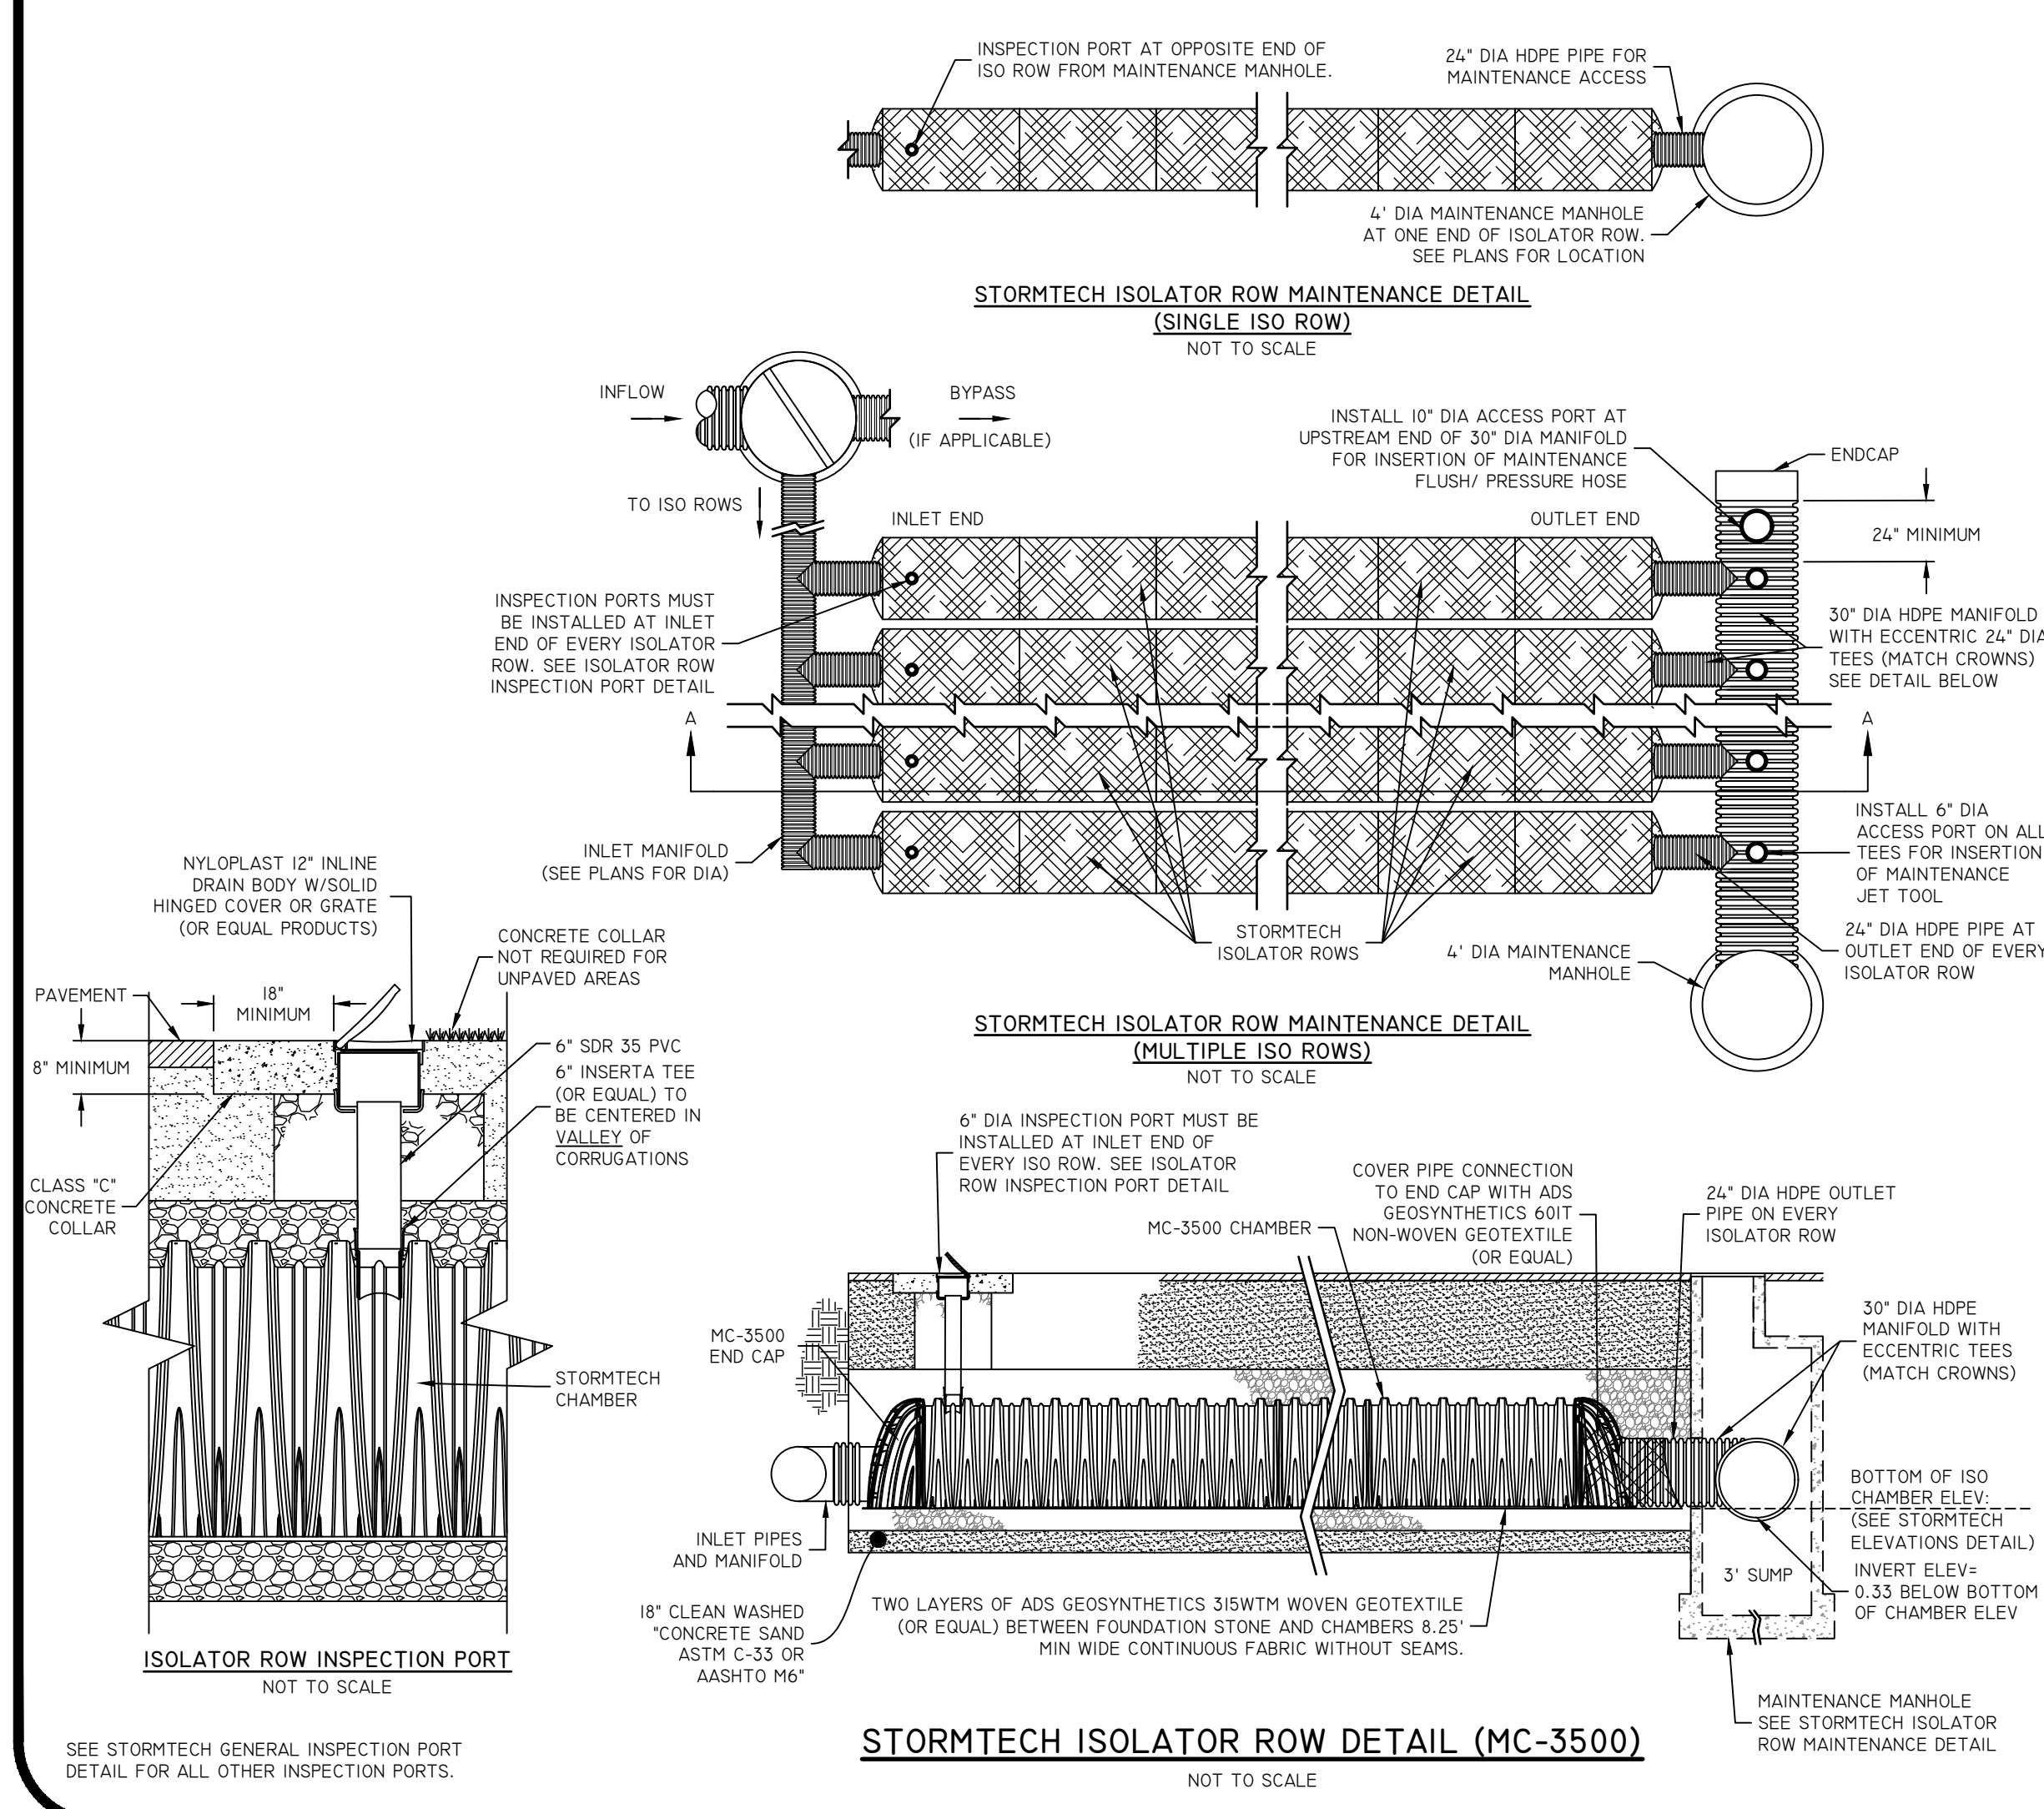


STORMTECH ISOLATOR ROW DETAIL (MC-3500)

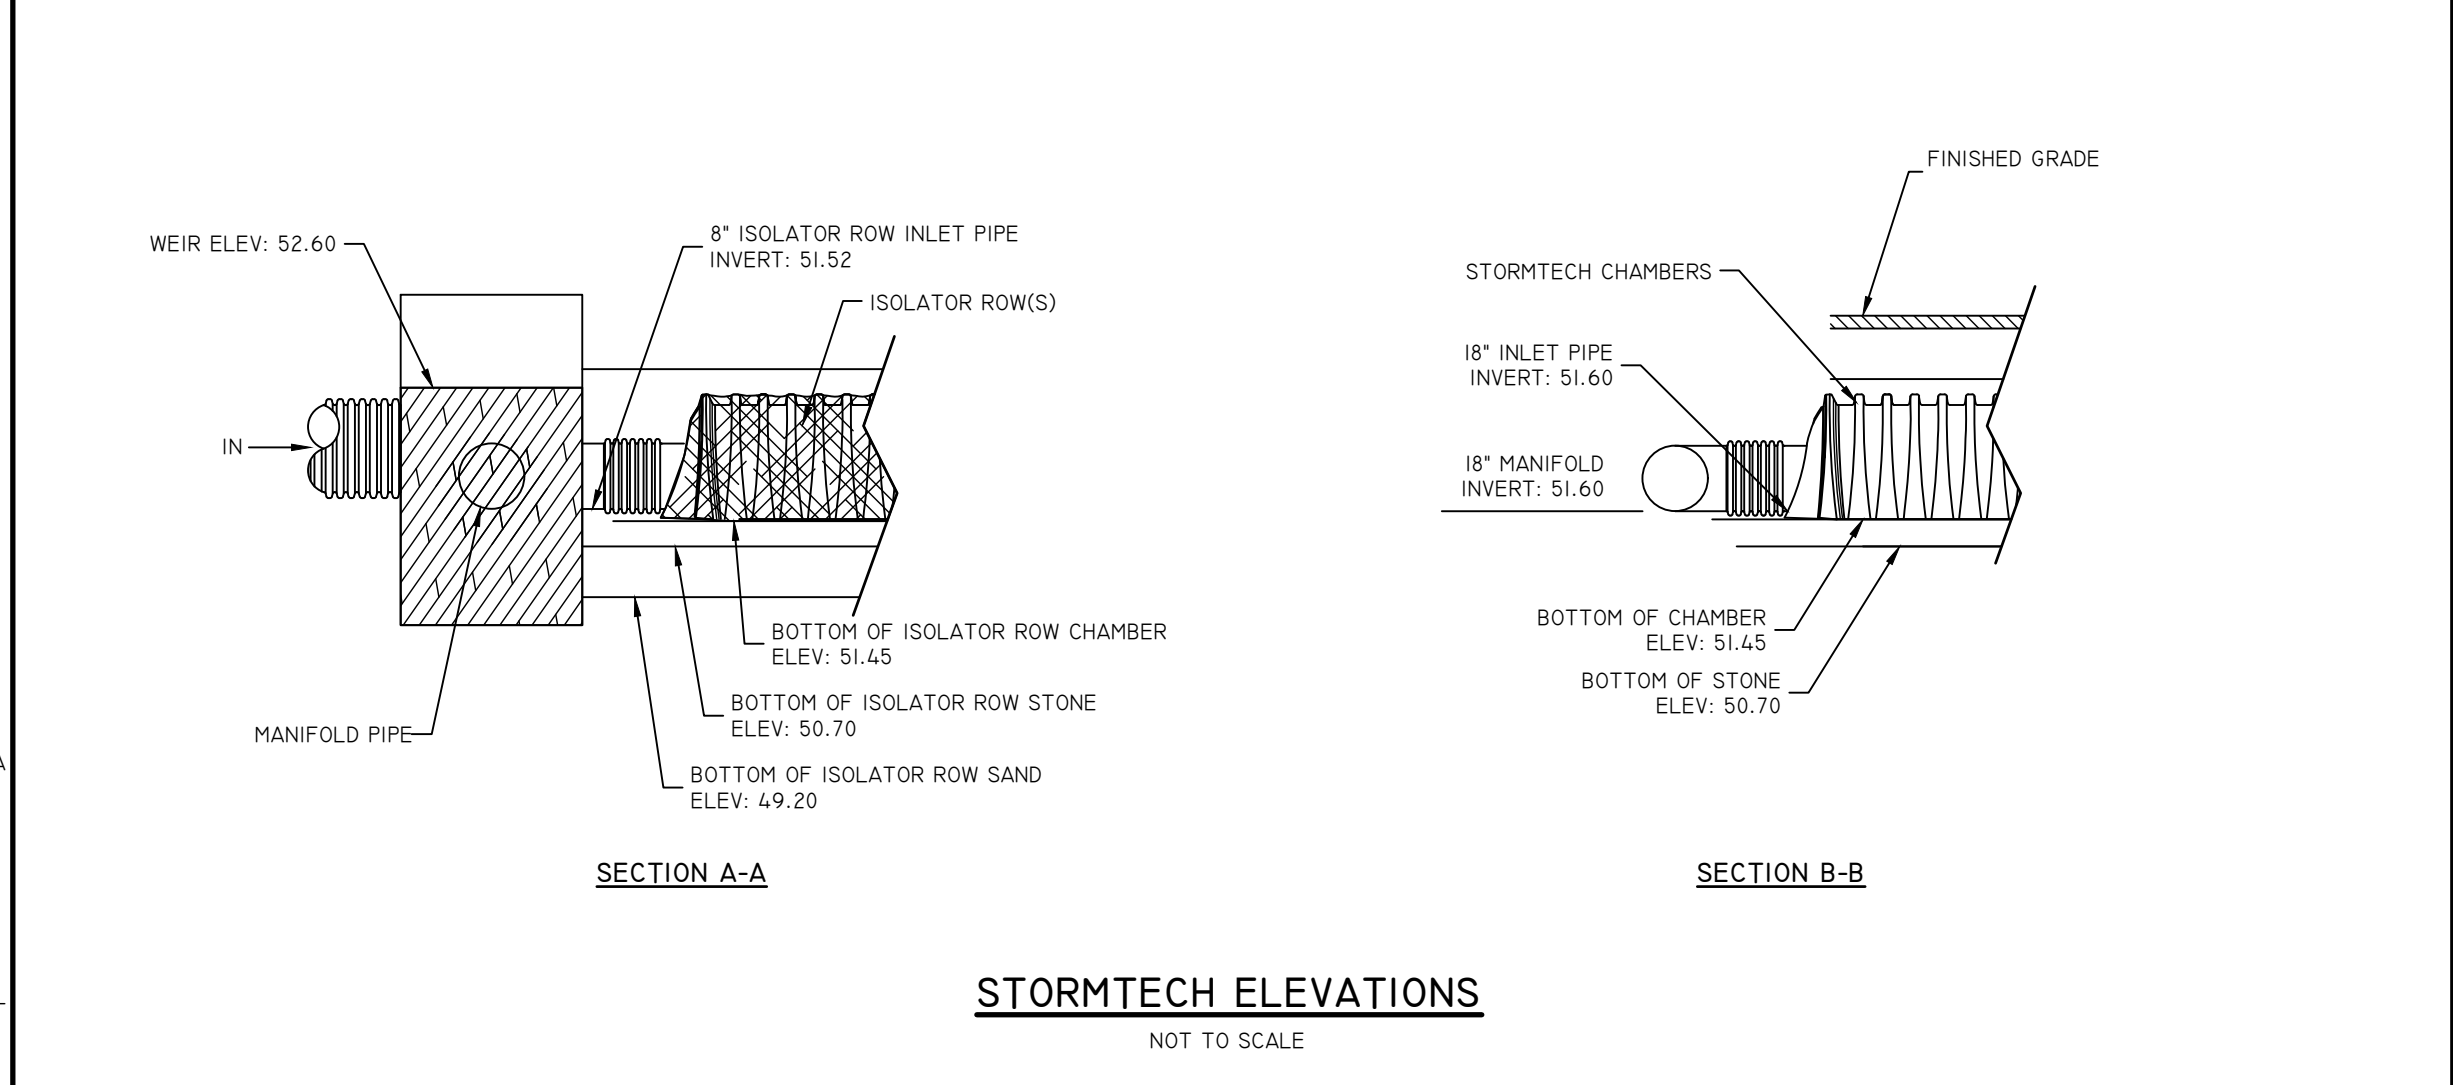


STORMTECH ELEVATIONS


DESCRIPTION	ISO-D	UIS-D
TOP OF UIS STONE	56.20	56.20
BOTTOM OF UIS STONE	50.70	50.70
100 YEAR STORM ELEVATION	55.30	55.31
10 YEAR STORM ELEVATION	52.97	52.48
1 YEAR STORM ELEVATION	52.77	51.04
SEASONAL HIGH GW ELEVATION	46.70	46.70
SOIL EVALUATION	TH-4	TH-4

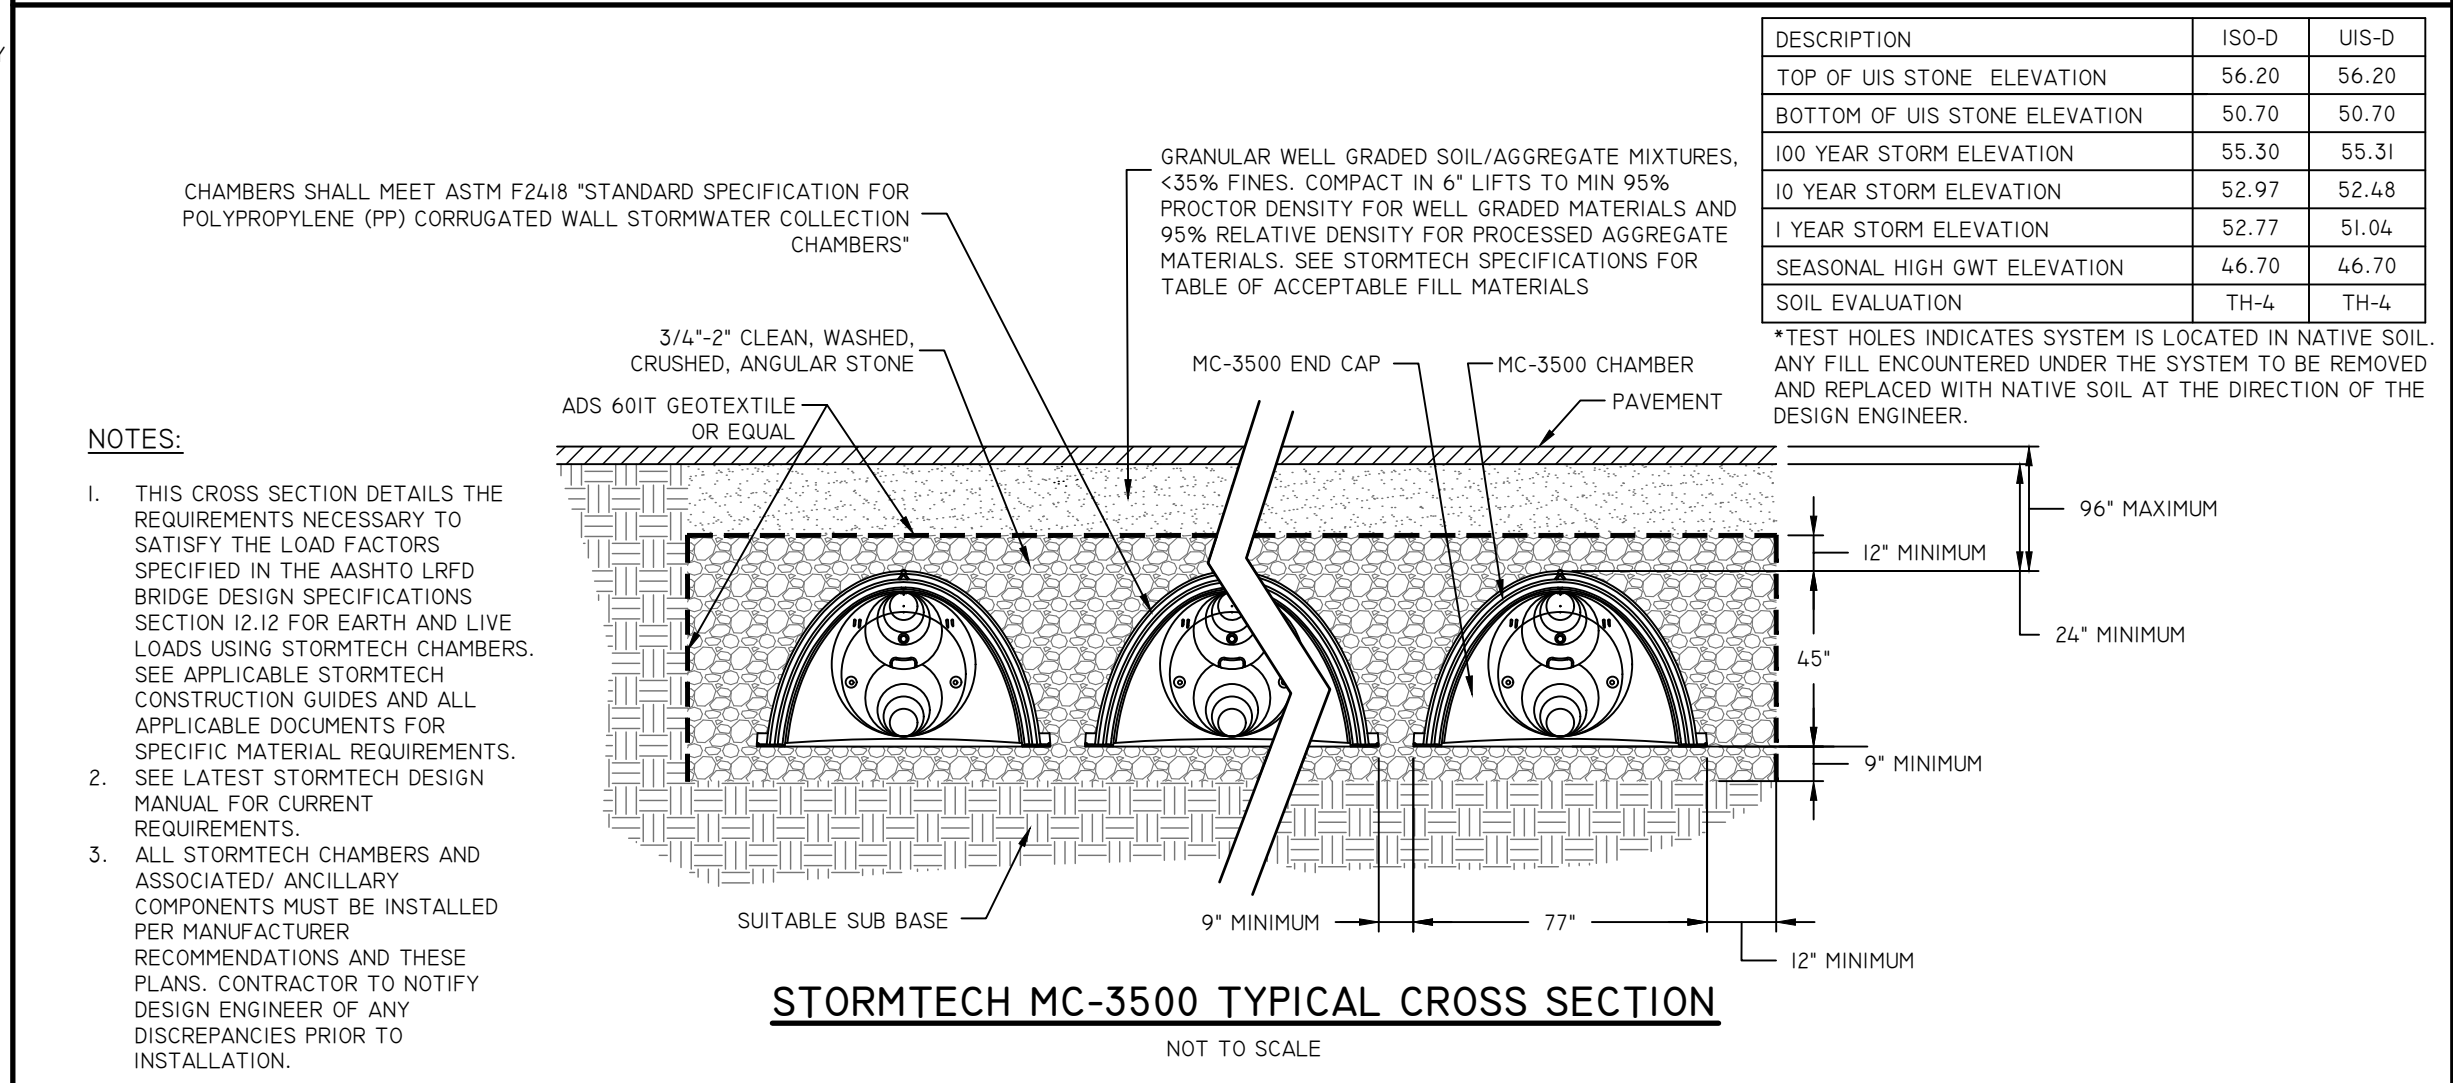

STORMTECH MC-3500 TYPICAL CROSS SECTION

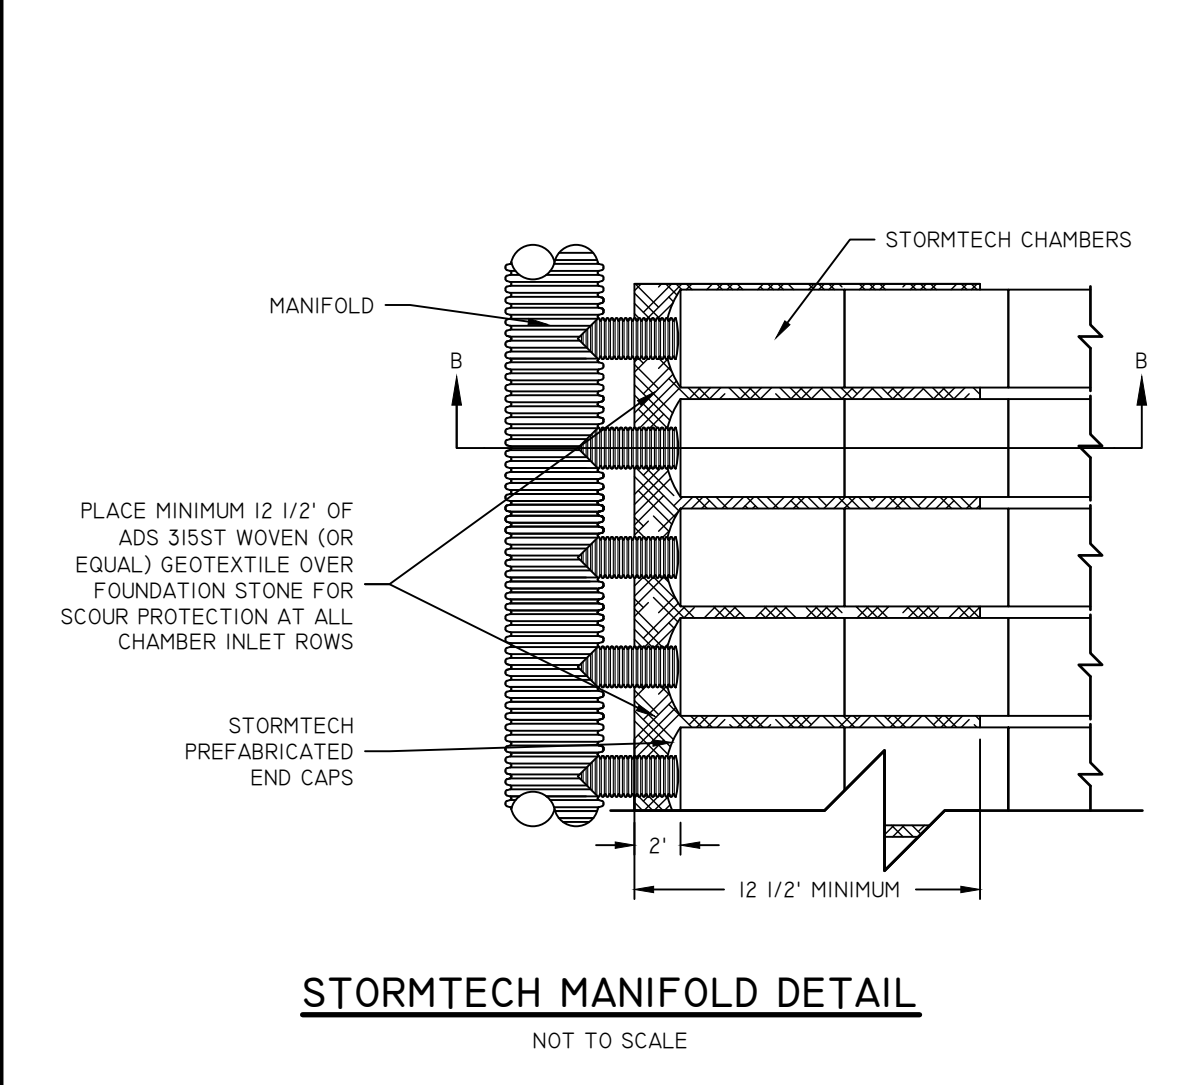

STORMTECH MANIFOLD DETAIL

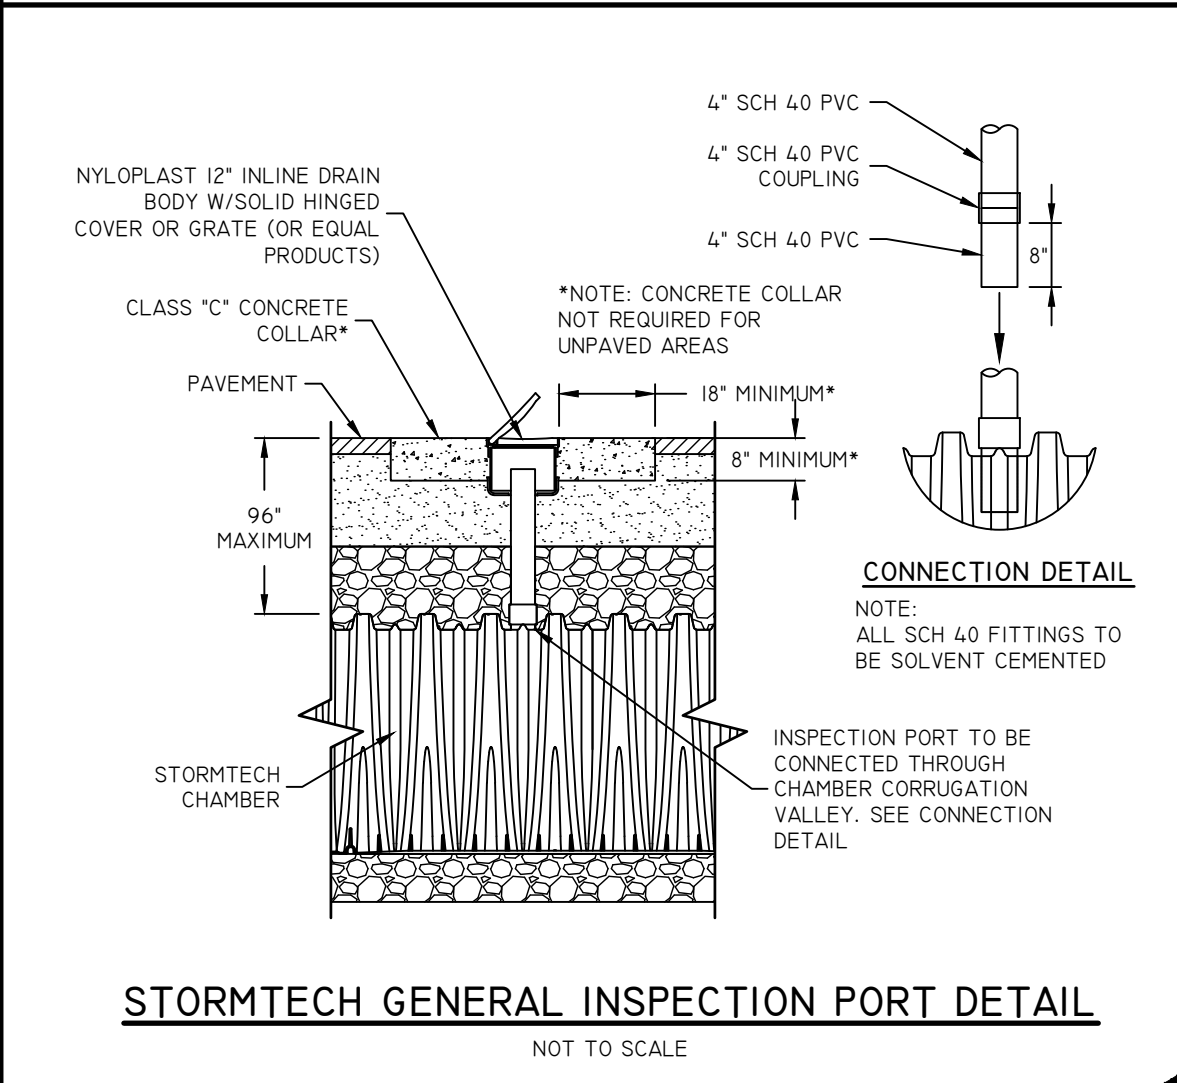

STORMTECH GENERAL INSPECTION PORT DETAIL

Diprete Engineering
 Two Stafford Court Cranston, RI 02920
 tel 401-943-1000 fax 401-644-6006 www.diprete-eng.com

Boston • Providence • Newport

BRANDON D. CARR
 REGISTERED PROFESSIONAL ENGINEER
 CIVIL

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DIPRETE ENGINEERING ON STAFF HAS REVIEWED THIS PLAN SET FOR CONFORMANCE WITH THE DESIGN, CONSTRUCTION, SAFETY, PRECAUTIONS AND REQUIREMENTS OF THE DESIGN. THE CONTRACTOR IS RESPONSIBLE FOR ALL OF THE DESIGN, CONSTRUCTION, SAFETY, PRECAUTIONS AND REQUIREMENTS OF THE DESIGN. EXISTING UTILITIES SHOWN ON THIS PLAN ARE APPROXIMATE. THE CONTRACTOR SHALL VERIFY THE LOCATION AND DEPTH OF ALL EXISTING UTILITIES PRIOR TO CONSTRUCTION. SEE UTILITY NOTES ON SHEET 1.


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DESIGN BY: J.A.R.


UNDERGROUND INFILTRATION SYSTEM - D
POST ROAD APARTMENTS
 ASSessor'S PLAT 323 LOT 523
 WARWICK, RHODE ISLAND

PREPARED FOR:
SKYDRA DEVELOPMENT
 858 WASHINGTON STREET, SUITE #305, DEDHAM, MA 02026
 TEL 781-451-5600

DESIGN BY: J.A.R.

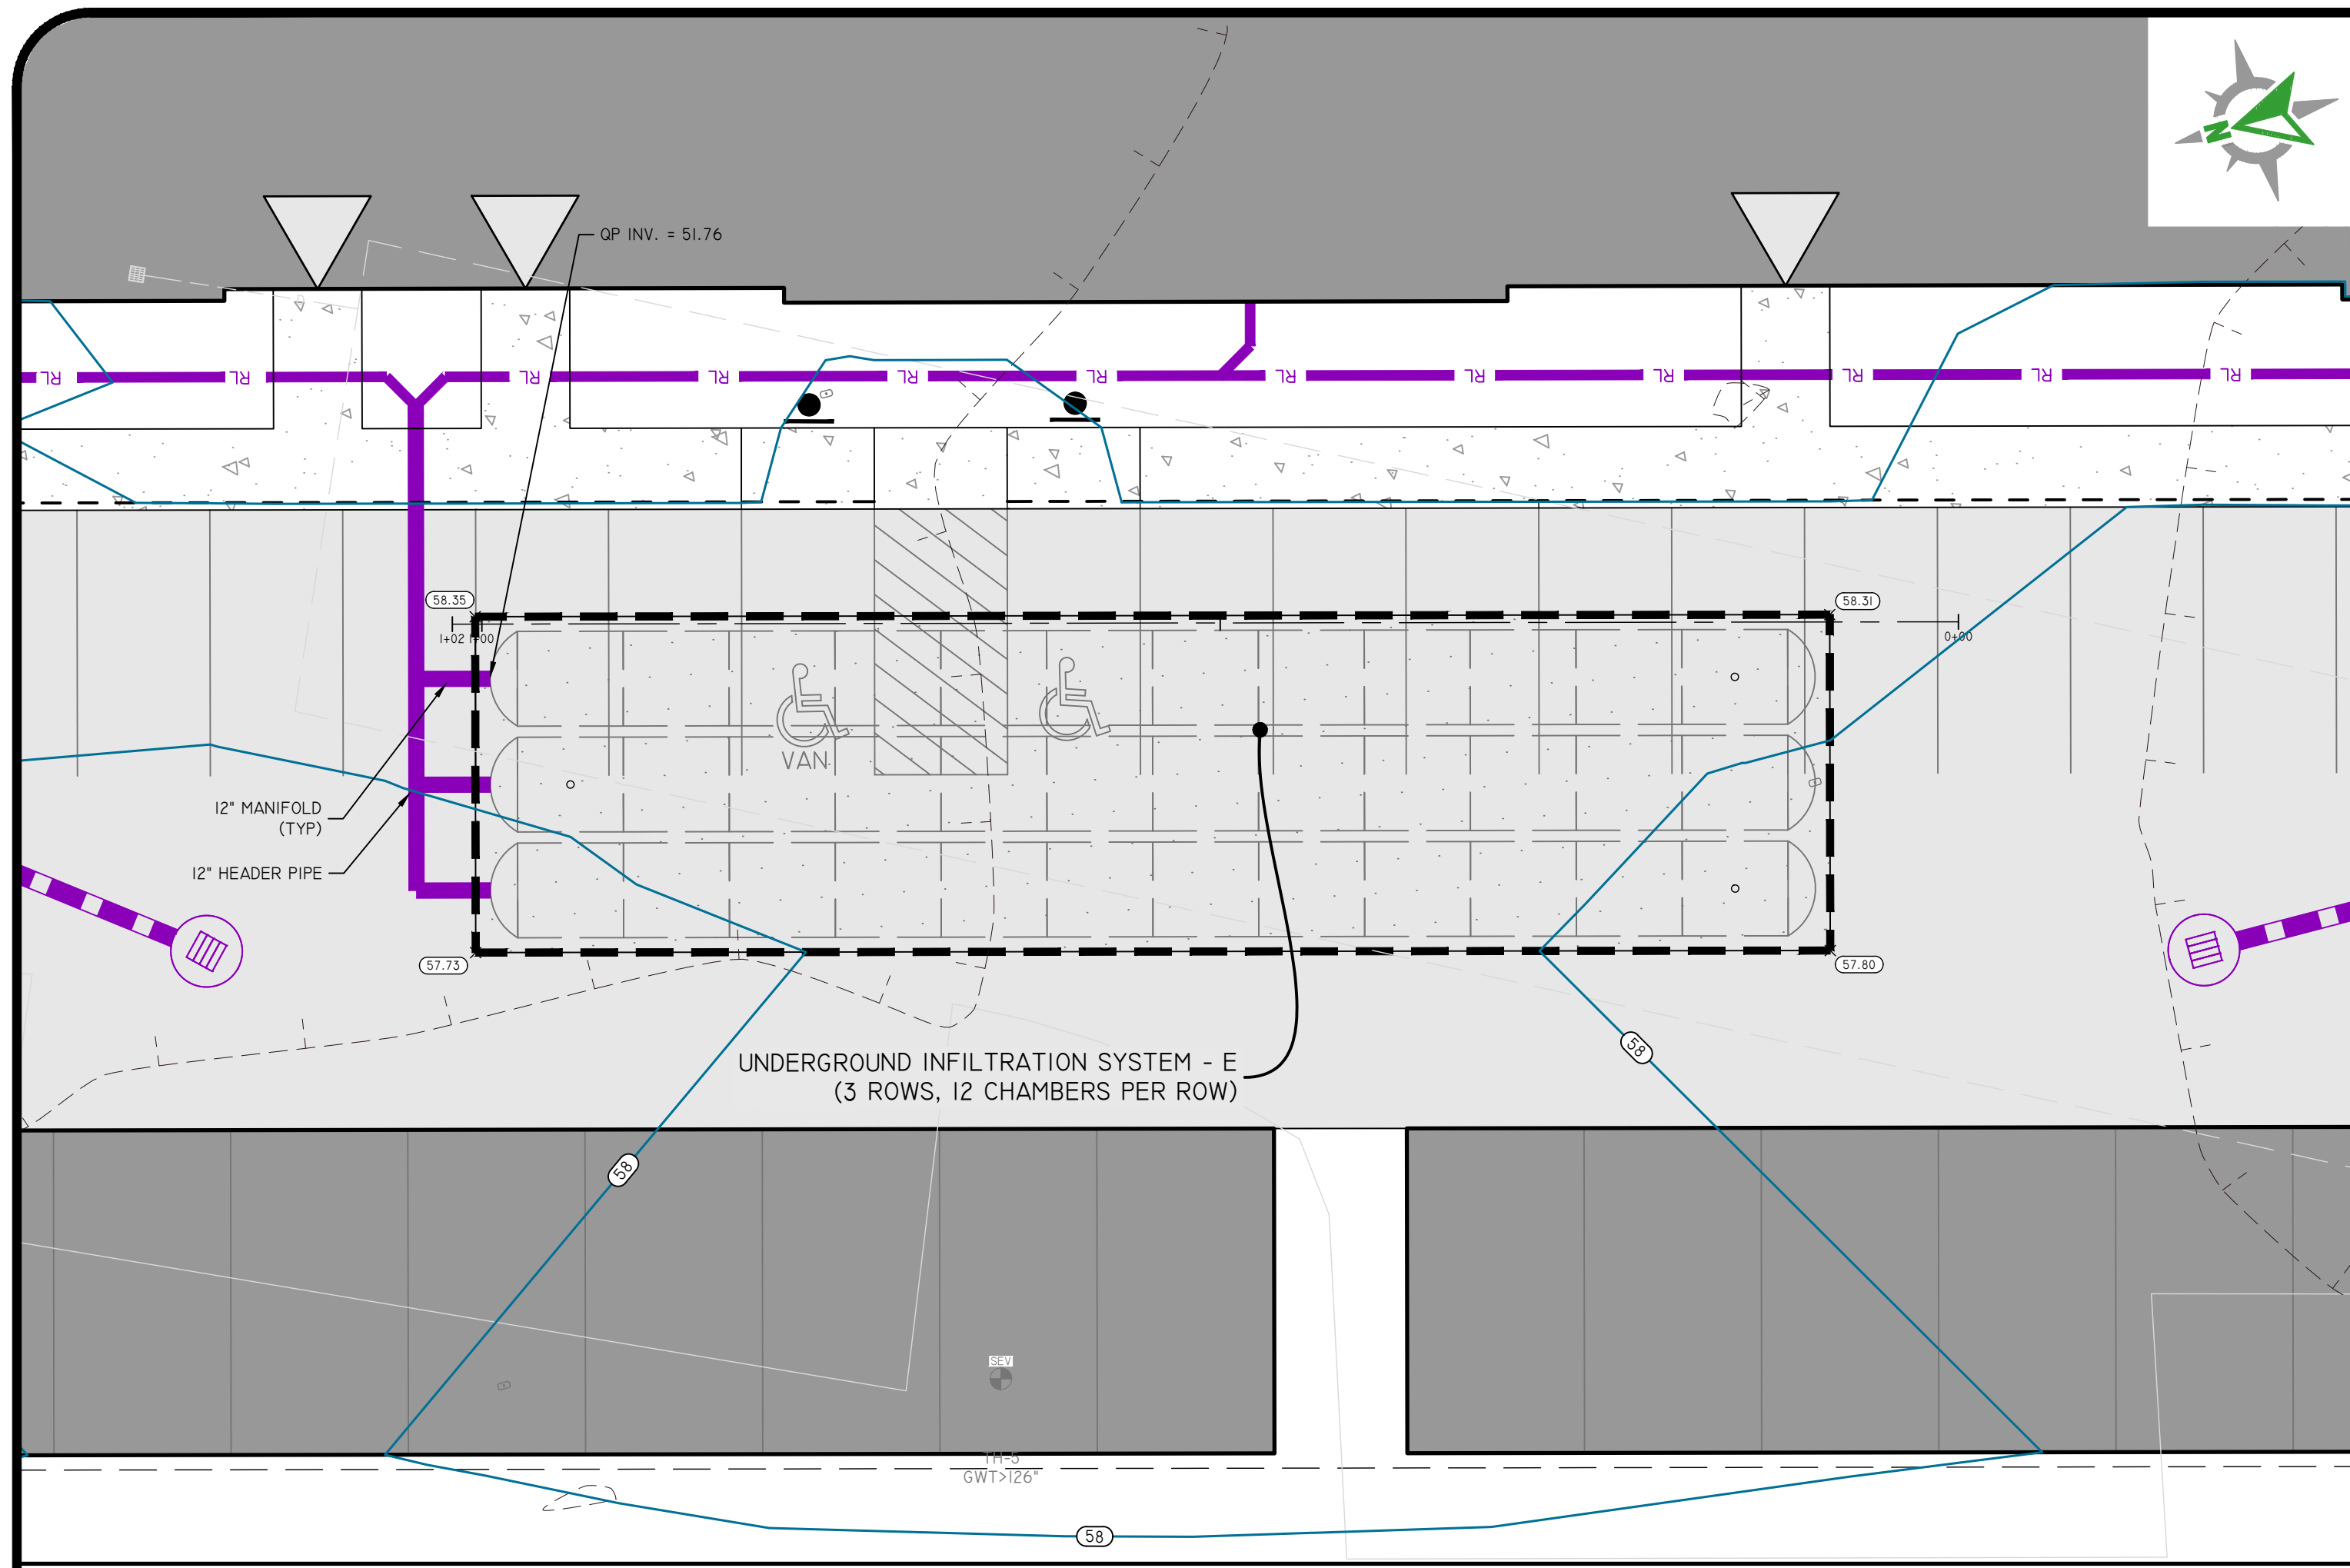

UNDERGROUND INFILTRATION SYSTEM - E (UIS-E)

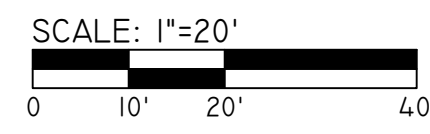

I:\COMMON\DRAWING\2023\CASCADE\23-011-DWG 8/18/2023 2:23 PM

PLAN VIEW B-B
NOT TO SCALE

CASCADE SEPARATOR DESIGN NOTES

THE STANDARD CS-3 CONFIGURATION IS SHOWN. ALTERNATE CONFIGURATIONS ARE AVAILABLE AND ARE LISTED BELOW. SOME CONFIGURATIONS MAY BE COMBINED TO SUIT SITE REQUIREMENTS.

CONFIGURATION DESCRIPTION	
GRATED INLET ONLY (NO INLET PIPE)	
GRATED INLET WITH INLET PIPE OR PIPES	
CURB INLET ONLY (NO INLET PIPE)	
CURB INLET WITH INLET PIPE OR PIPES	

ELEVATION A-A
NOT TO SCALE

SITE SPECIFIC DATA REQUIREMENTS

STRUCTURE ID	WATER QUALITY FLOW RATE (cfs [L/s])	PEAK FLOW RATE (cfs [L/s])	RETURN PERIOD OF PEAK FLOW (yrs)	RIM ELEVATION

PIPE DATA:	INVERT	MATERIAL	DIAMETER
INLET PIPE 1			
INLET PIPE 2			
OUTLET PIPE			

NOTES/SPECIAL REQUIREMENTS:

FRAME AND COVER
(DIAMETER VARIES)
NOT TO SCALE

GENERAL NOTES

- CONTECH TO PROVIDE ALL MATERIALS UNLESS NOTED OTHERWISE.
- FOR SITE SPECIFIC DRAWINGS WITH DETAILED STRUCTURE DIMENSIONS AND WEIGHT, PLEASE CONTACT YOUR CONTECH ENGINEERED SOLUTIONS LLC REPRESENTATIVE. www.contechES.com
- CASCADE SEPARATOR WATER QUALITY STRUCTURE SHALL BE IN ACCORDANCE WITH ALL DESIGN DATA AND INFORMATION CONTAINED IN THIS DRAWING. CONTRACTOR TO CONFIRM STRUCTURE MEETS REQUIREMENTS OF PROJECT.
- CASCADE SEPARATOR STRUCTURE SHALL MEET AASHTO H20D LOAD RATING, ASSUMING EARTH COVER OF 0' - 2' (0.10) AND GROUNDWATER ELEVATION AT, OR BELOW, THE OUTLET PIPE INVERT ELEVATION. ENGINEER OF RECORD TO CONFIRM ACTUAL GROUNDWATER ELEVATION. CASTINGS SHALL MEET AASHTO M306 AND BE CAST WITH THE CONTECH LOGO.
- CASCADE SEPARATOR STRUCTURE SHALL BE PRECAST CONCRETE CONFORMING TO ASTM C478 AND AASHTO LOAD FACTOR DESIGN METHOD.
- ALTERNATE UNITS ARE SHOWN IN MILLIMETERS [mm].


INSTALLATION NOTES

- ANY SUB-BASE, BACKFILL DEPTH, AND/OR ANTI-FLOTATION PROVISIONS ARE SITE-SPECIFIC DESIGN CONSIDERATIONS AND SHALL BE SPECIFIED BY ENGINEER OF RECORD.
- CONTRACTOR TO PROVIDE EQUIPMENT WITH SUFFICIENT LIFTING AND REACH CAPACITY TO LIFT AND SET THE CASCADE SEPARATOR MANHOLE STRUCTURE.
- CONTRACTOR TO INSTALL JOINT SEALANT BETWEEN ALL STRUCTURE SECTIONS AND ASSEMBLE STRUCTURE.
- CONTRACTOR TO PROVIDE, INSTALL, AND GROUT INLET AND OUTLET PIPE(S). MATCH PIPE INVERTS WITH ELEVATIONS SHOWN. ALL PIPE CENTERLINES TO MATCH PIPE OPENING CENTERLINES.
- CONTRACTOR TO TAKE APPROPRIATE MEASURES TO ASSURE UNIT IS WATER TIGHT, HOLDING WATER TO FLOWLINE INVERT MINIMUM. IT IS SUGGESTED THAT ALL JOINTS BELOW PIPE INVERTS ARE GROUTED.



CASCADE separator™

CONTECH ENGINEERED SOLUTIONS LLC
www.contechES.com
8025 Centre Pointe Dr., Suite 400, West Chester, OH 45380
900.338.1122 513.645.7000 513.645.7853 FAX


CS-3 CASCADE SEPARATOR STANDARD DETAIL

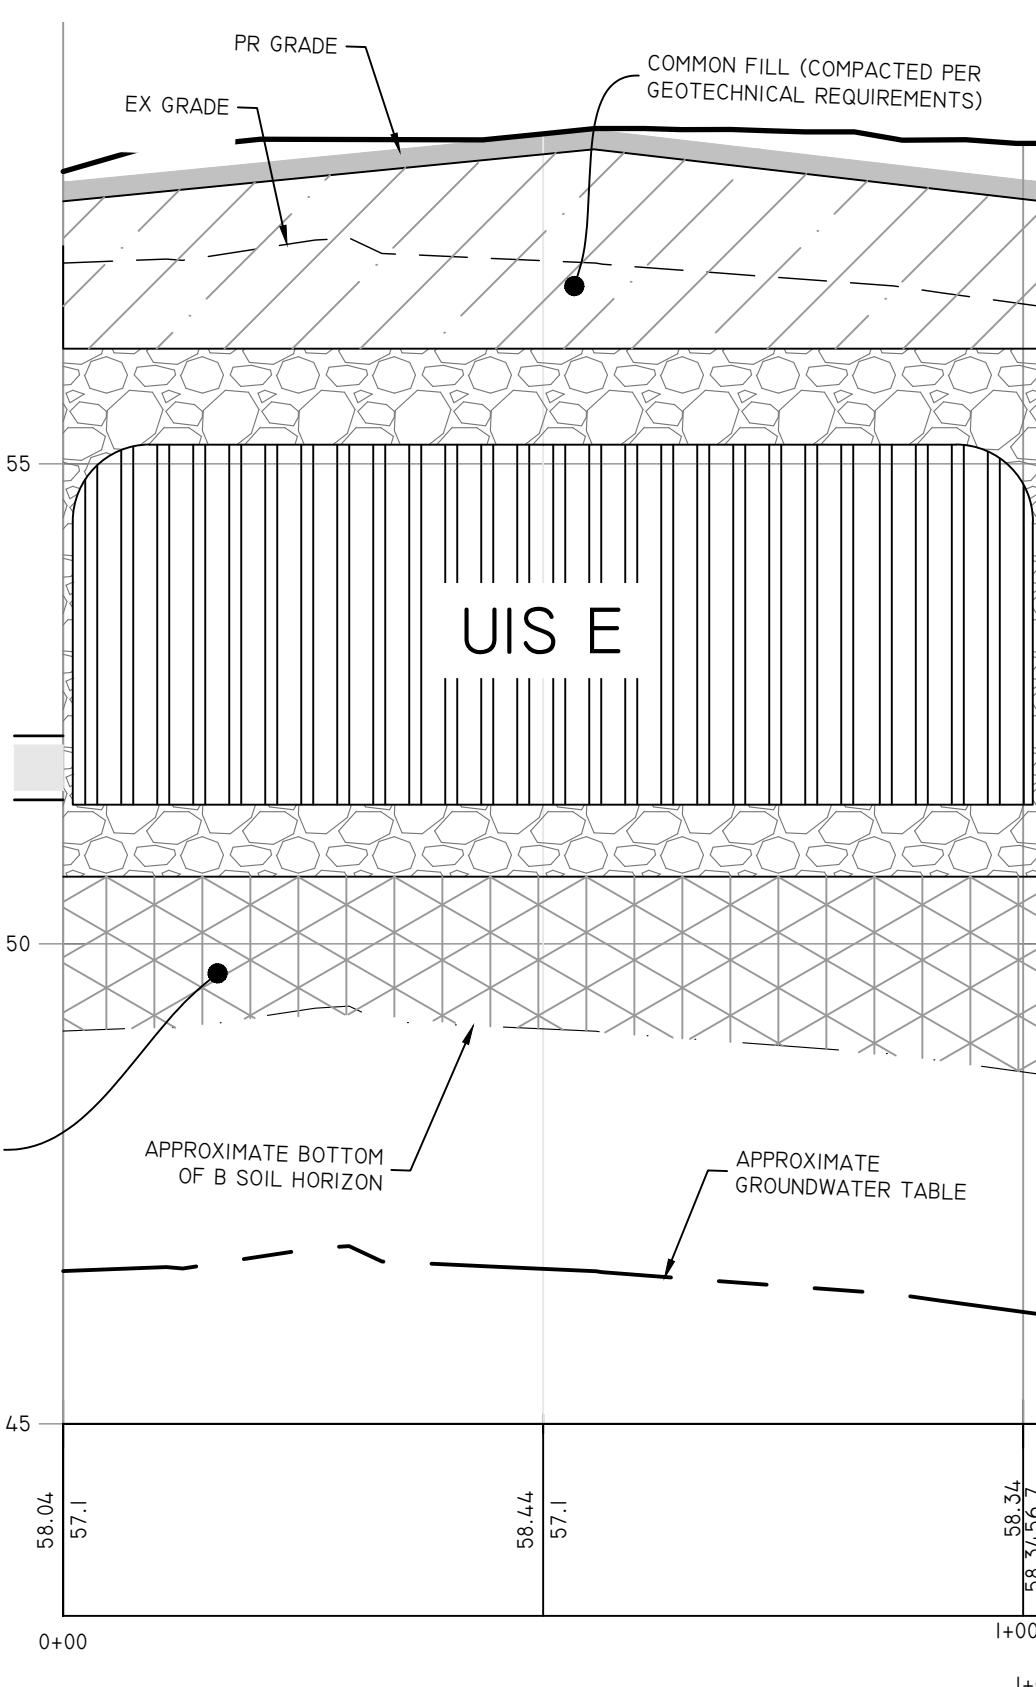


STORMTECH ISOLATOR ROW DETAIL (MC-3500)

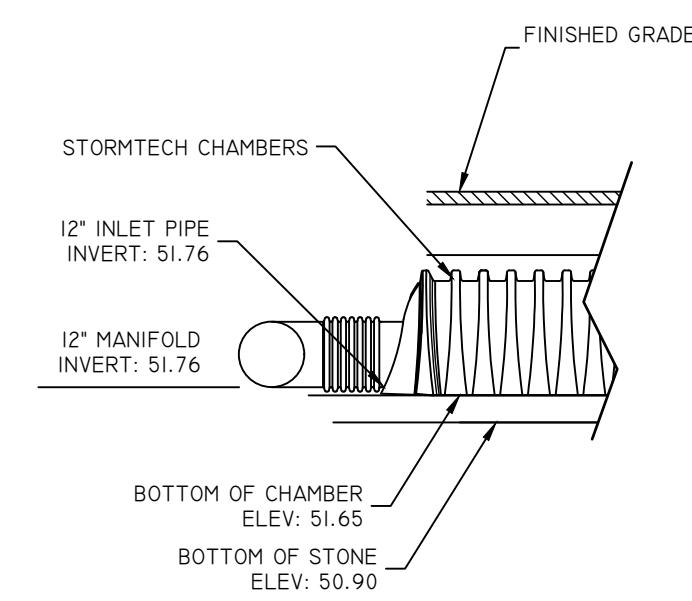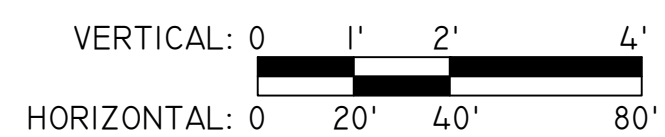

SECTION B-B
STORMTECH ELEVATIONS
NOT TO SCALE

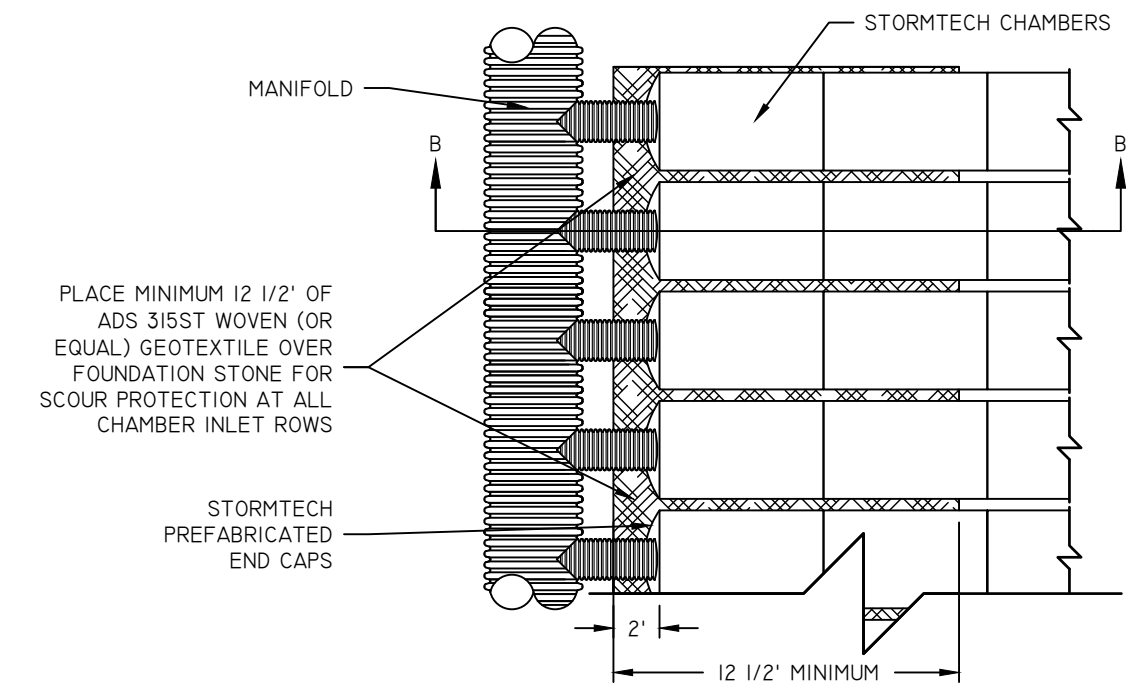

STORMTECH MANIFOLD DETAIL
NOT TO SCALE

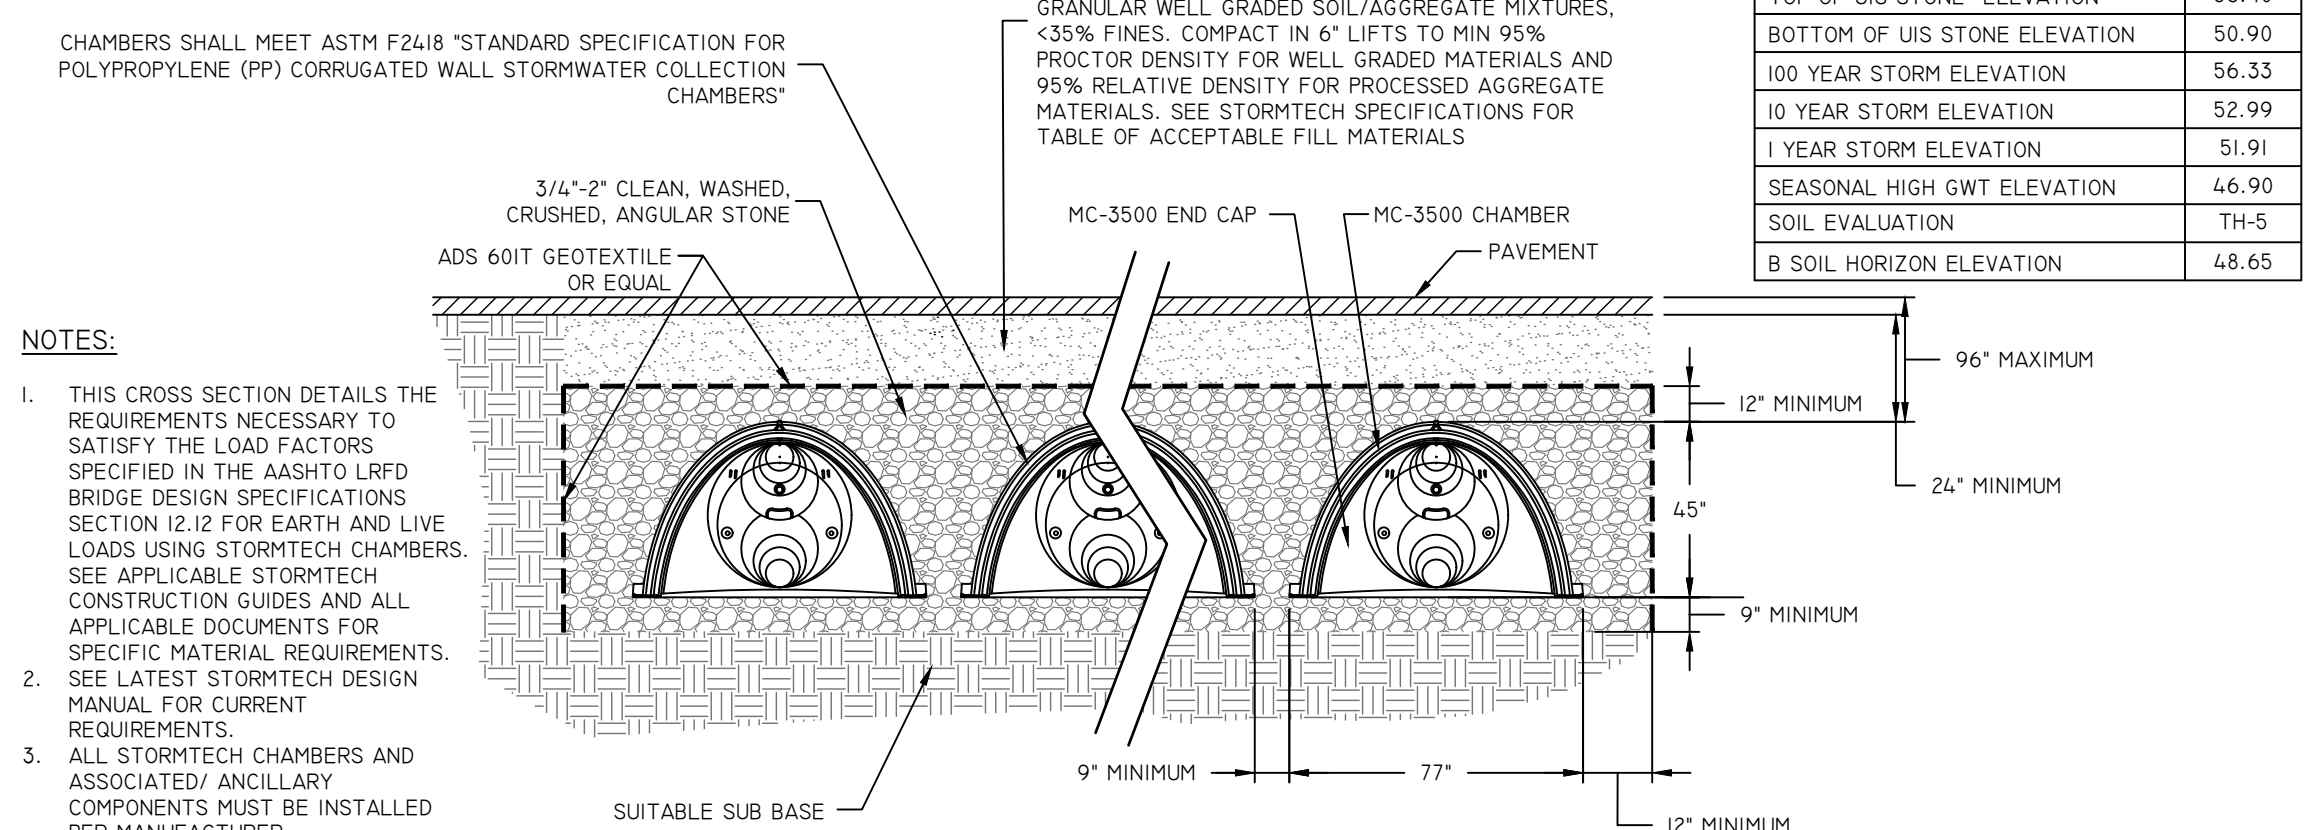


STORMTECH MC-3500 TYPICAL CROSS SECTION
NOT TO SCALE

NOTES:

- THIS CROSS SECTION DETAILS THE REQUIREMENTS NECESSARY TO SATISFY THE LOAD FACTORS SPECIFIED IN THE AASHTO LRFD BRIDGE DESIGN SPECIFICATIONS SECTION 12.12 FOR EARTH AND LIVE LOADS USING STORMTECH CHAMBERS. SEE APPLICABLE STORMTECH CONSTRUCTION GUIDES AND ALL APPLICABLE DOCUMENTS FOR SPECIFIC MATERIAL REQUIREMENTS.
- SEE LATEST STORMTECH DESIGN MANUAL FOR CURRENT REQUIREMENTS.
- ALL STORMTECH CHAMBERS AND ASSOCIATED/ ANCILLARY COMPONENTS MUST BE INSTALLED PER MANUFACTURER RECOMMENDATIONS AND THESE PLANS. CONTRACTOR TO NOTIFY DESIGN ENGINEER OF ANY DISCREPANCIES PRIOR TO INSTALLATION.

DESCRIPTION	UIS-E
TOP OF UIS STONE ELEVATION	56.40
BOTTOM OF UIS STONE ELEVATION	50.90
100 YEAR STORM ELEVATION	56.33
10 YEAR STORM ELEVATION	52.99
1 YEAR STORM ELEVATION	51.91
SEASONAL HIGH GWT ELEVATION	46.90
SOIL EVALUATION	TH-5
B SOIL HORIZON ELEVATION	48.65

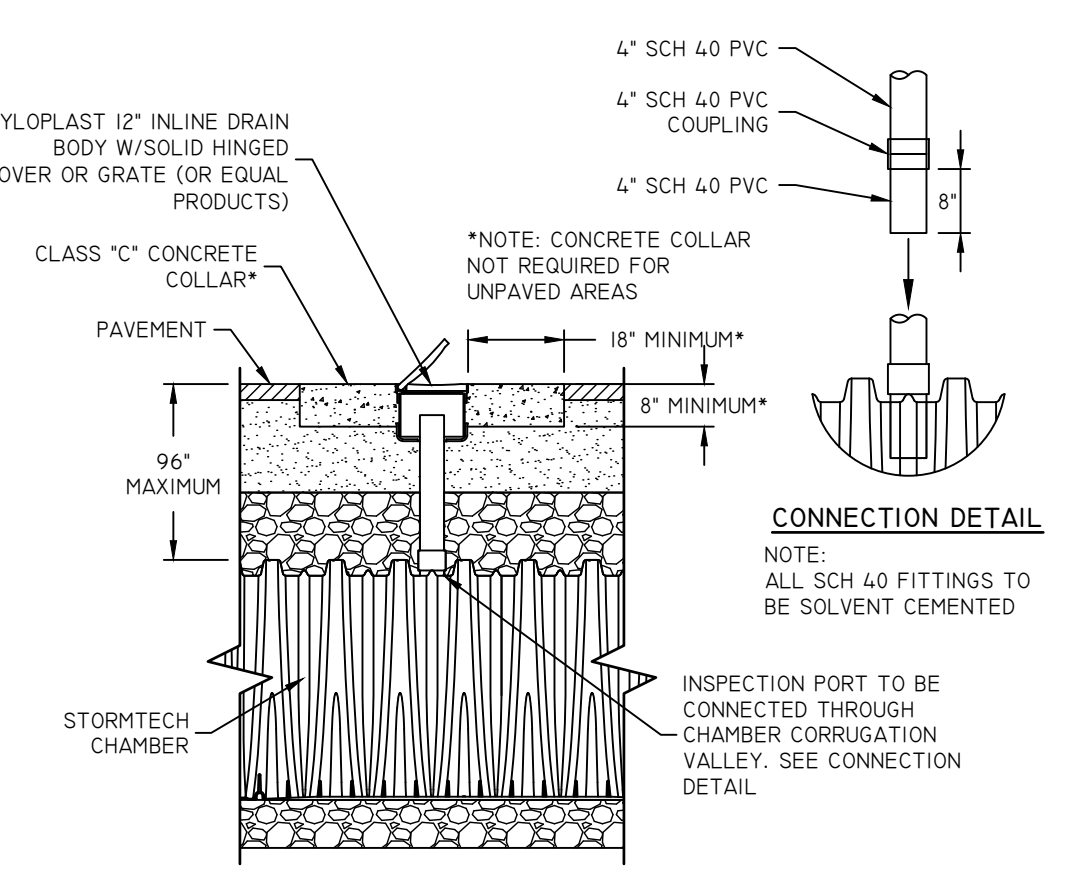

STORMTECH GENERAL INSPECTION PORT DETAIL
NOT TO SCALE

Diprete Engineering
Two Stafford Court Cranston, RI 02920
tel 401-943-1000 fax 401-644-6006 www.diprete-eng.com

Boston • Providence • Newport

BRANDON D. CARR
REGISTERED PROFESSIONAL ENGINEER
CIVIL

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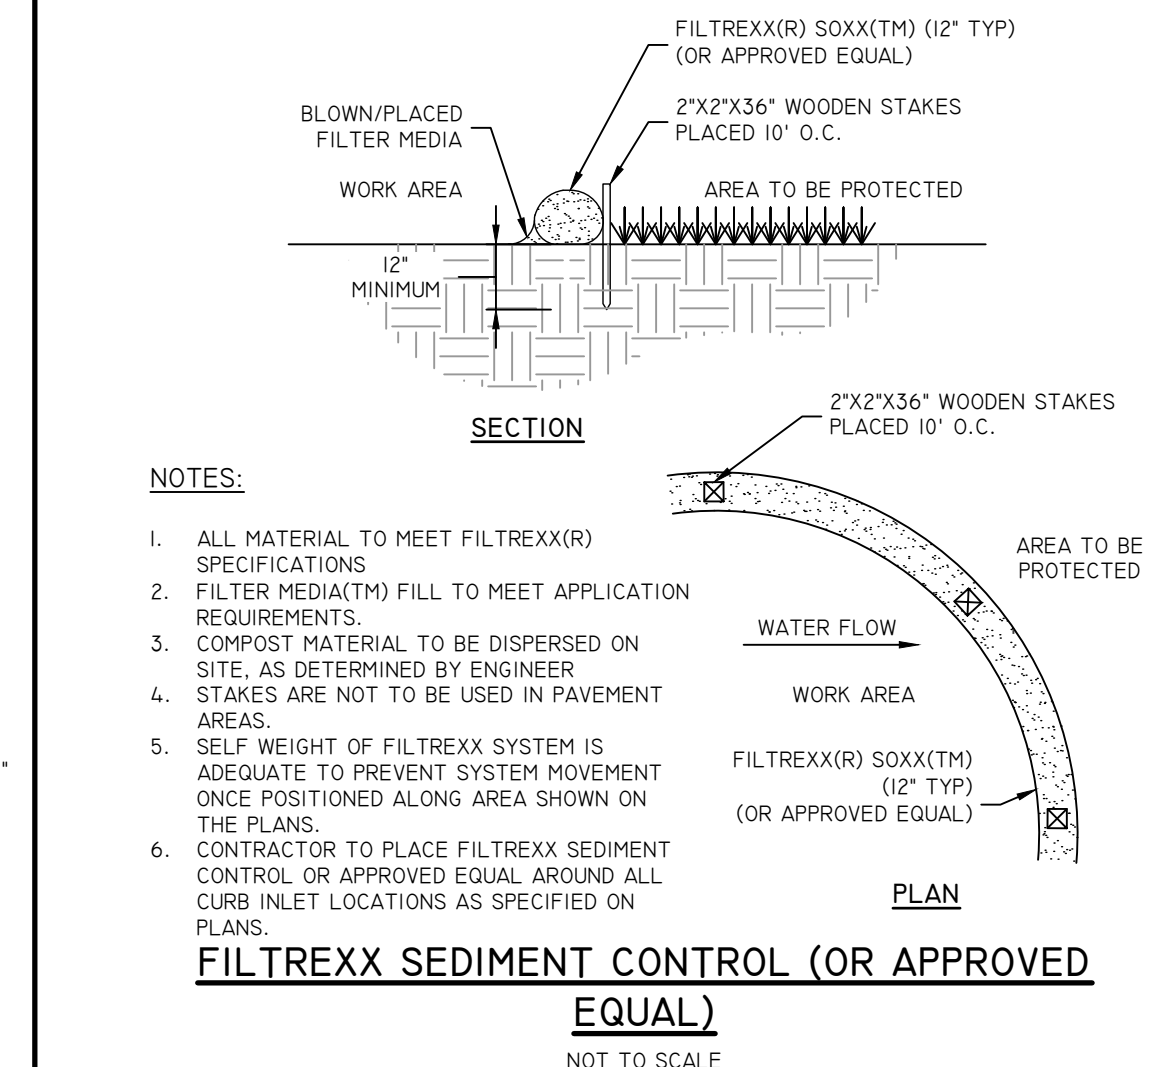
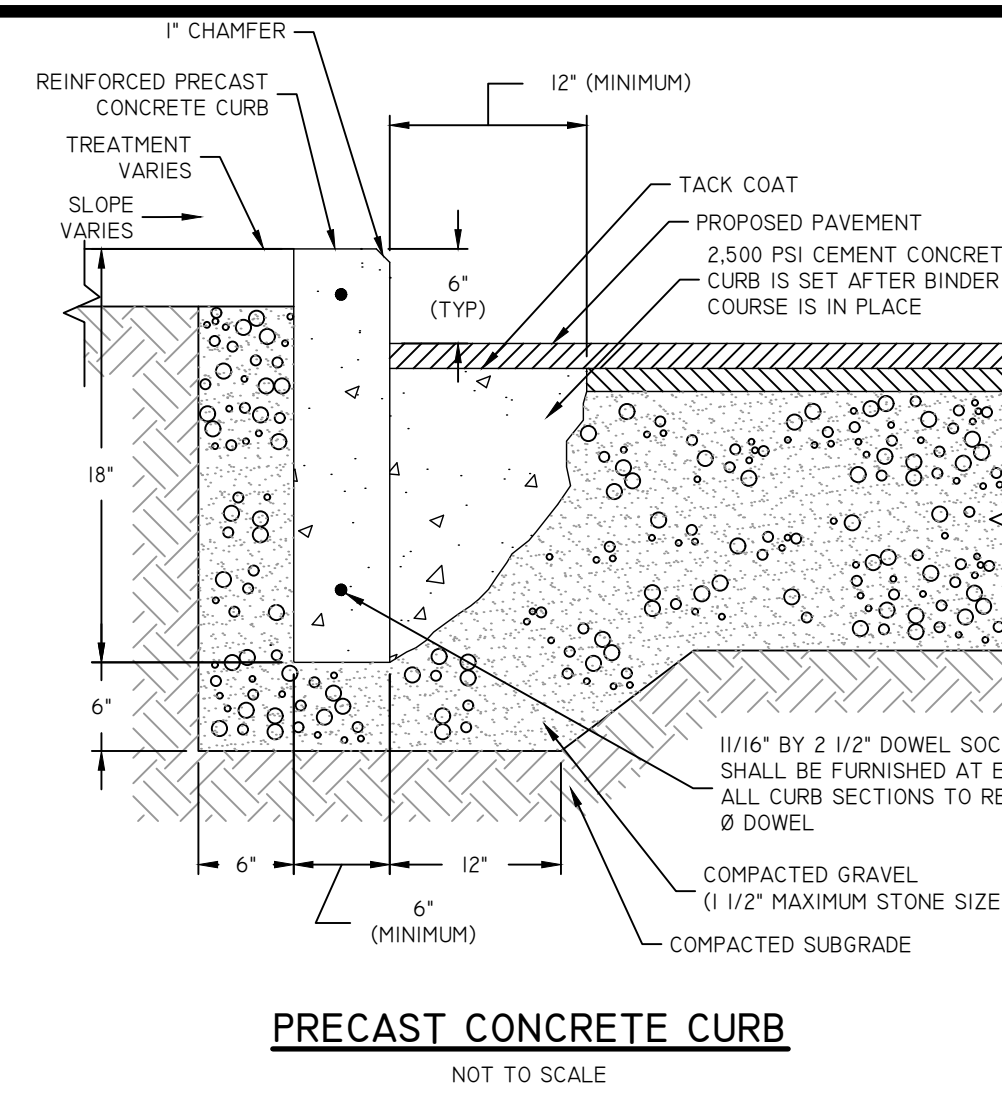
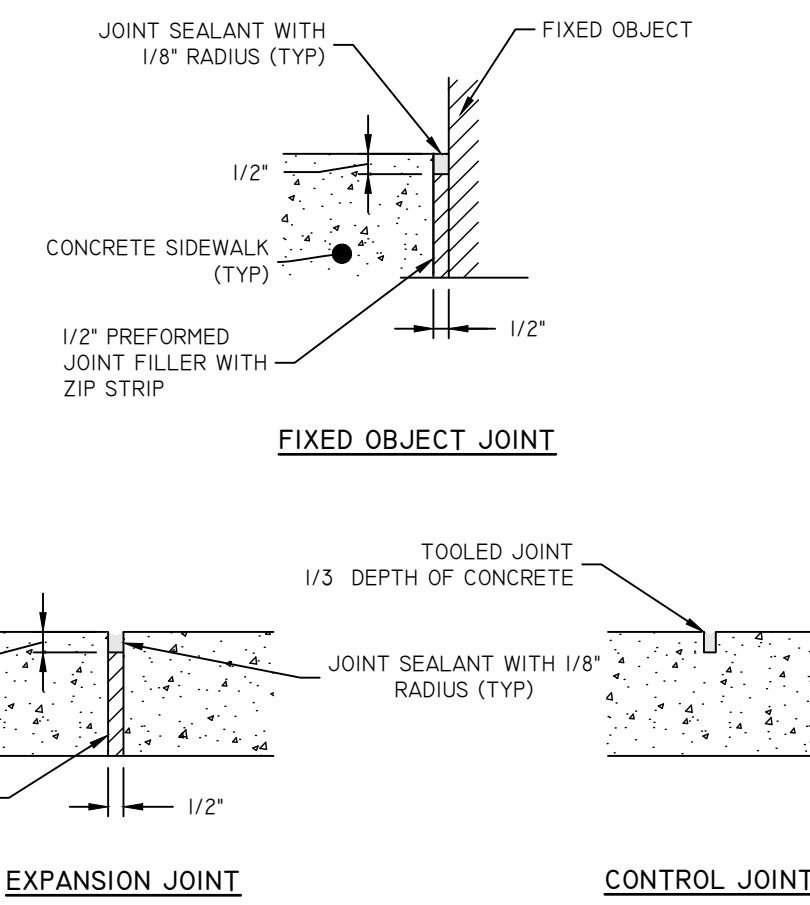
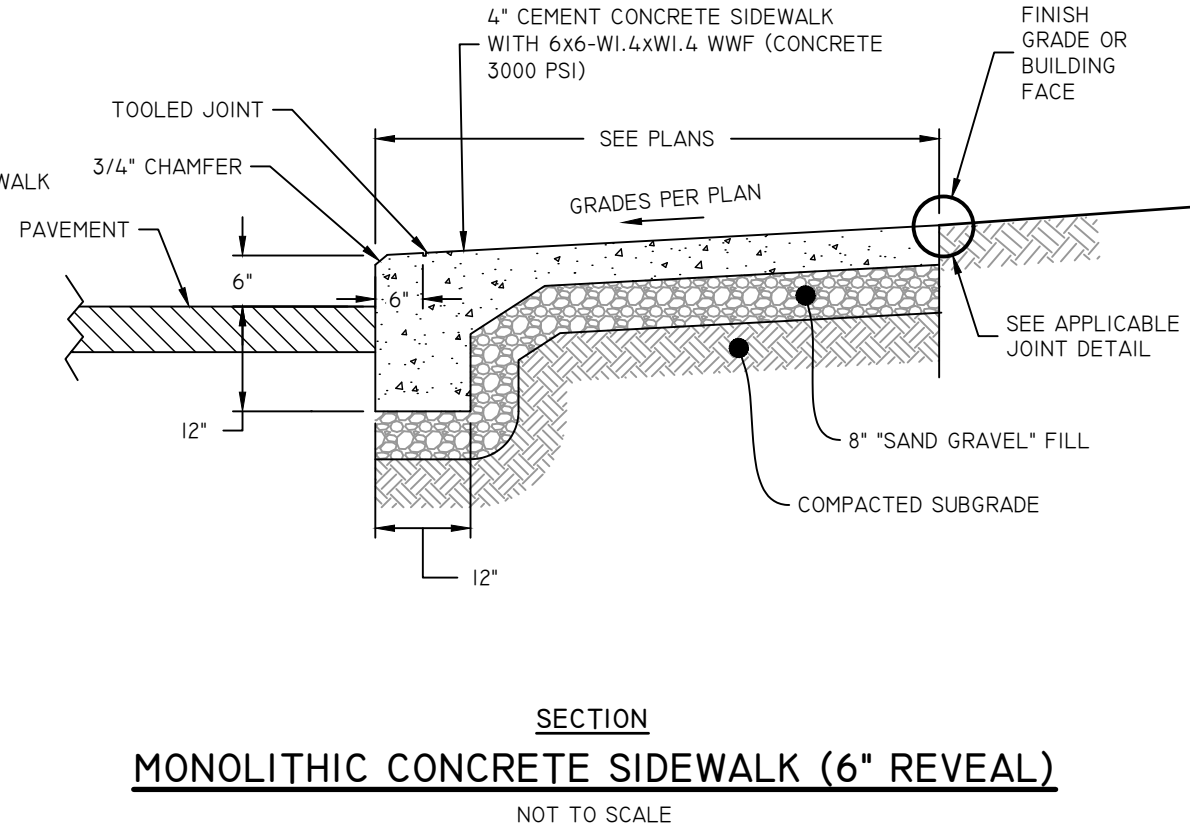
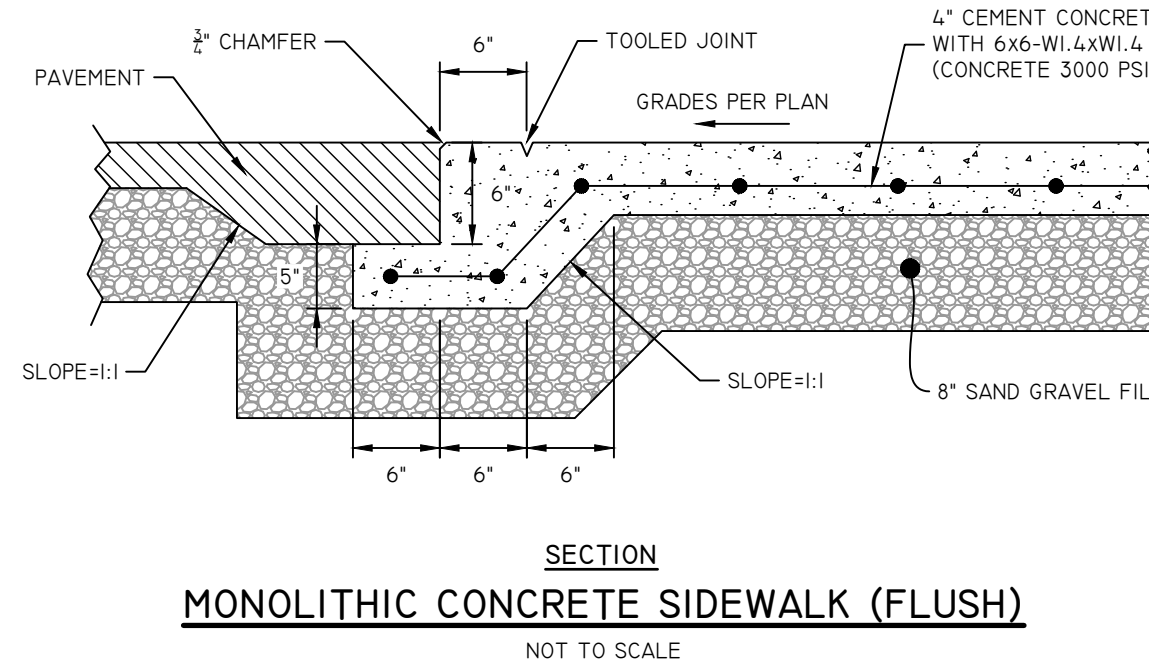
NO.	DATE	DESCRIPTION	BY	CHKD.
1	05-24-2023	PRELIMINARY SUBMISSION	J.A.R.	J.A.R.
2	05-20-2023	RESPONSE TO RFI COMMENTS	J.A.R.	J.A.R.
3	05-22-2023	FINAL SUBMISSION	J.A.R.	J.A.R.

DESIGN BY: F.V.A.
DRAWN BY: J.A.R.



UNDERGROUND INFILTRATION SYSTEM - E
POST ROAD APARTMENTS
ASSESSOR'S PLAT 323 LOT 523
WARWICK, RHODE ISLAND

PREPARED FOR:
SKYDRA DEVELOPMENT
858 WASHINGTON STREET, SUITE #305, DEDHAM, MA 02026
TEL 781-451-5600

- NOTE:**
- SEE SITE PLAN FOR SIDEWALK WIDTH AND GRADES.
 - SURFACE TEXTURE SHALL BE A LIGHT BROOMING, TRANSVERSE TO THE LENGTH OF THE WALK. CARE MUST BE TAKEN TO ENSURE A UNIFORM GRADE, FREE OF SAGS AND SHORT GRADE CHANGES.
 - ALL IMPROVEMENTS MUST COMPLY WITH THE "AMERICANS WITH DISABILITIES ACT ACCESSIBILITY GUIDELINES (ADAAG)" BY THE DEPARTMENT OF JUSTICE, CURRENT EDITION.
 - PROVIDE EXPANSION JOINTS AT MAX. 16 FT. O.C. WITH PREFORMED JOINT FILLER AND SEALANT.
 - PROVIDE CONTROL JOINTS AT 5' O.C.
 - MUST BE IN ACCORDANCE WITH THE R.I. STANDARD SPECIFICATIONS, CURRENT EDITION.




- NOTES:**
- ALL MATERIAL TO MEET FIL TREXX(R) SPECIFICATIONS
 - FILTER MEDIA(TM) FILL TO MEET APPLICATION REQUIREMENTS.
 - COMPOST MATERIAL TO BE DISPERSED ON SITE AS DETERMINED BY ENGINEER.
 - STAKES ARE NOT TO BE USED IN PAVEMENT AREAS.
 - SELF WEIGHT OF FIL TREXX SYSTEM IS ADEQUATE TO PREVENT SYSTEM MOVEMENT ONCE POSITIONED ALONG AREA SHOWN ON THE PLANS.
 - CONTRACTOR TO PLACE FIL TREXX SEDIMENT CONTROL OR APPROVED EQUAL AROUND ALL CURB INLET LOCATIONS AS SPECIFIED ON PLANS.

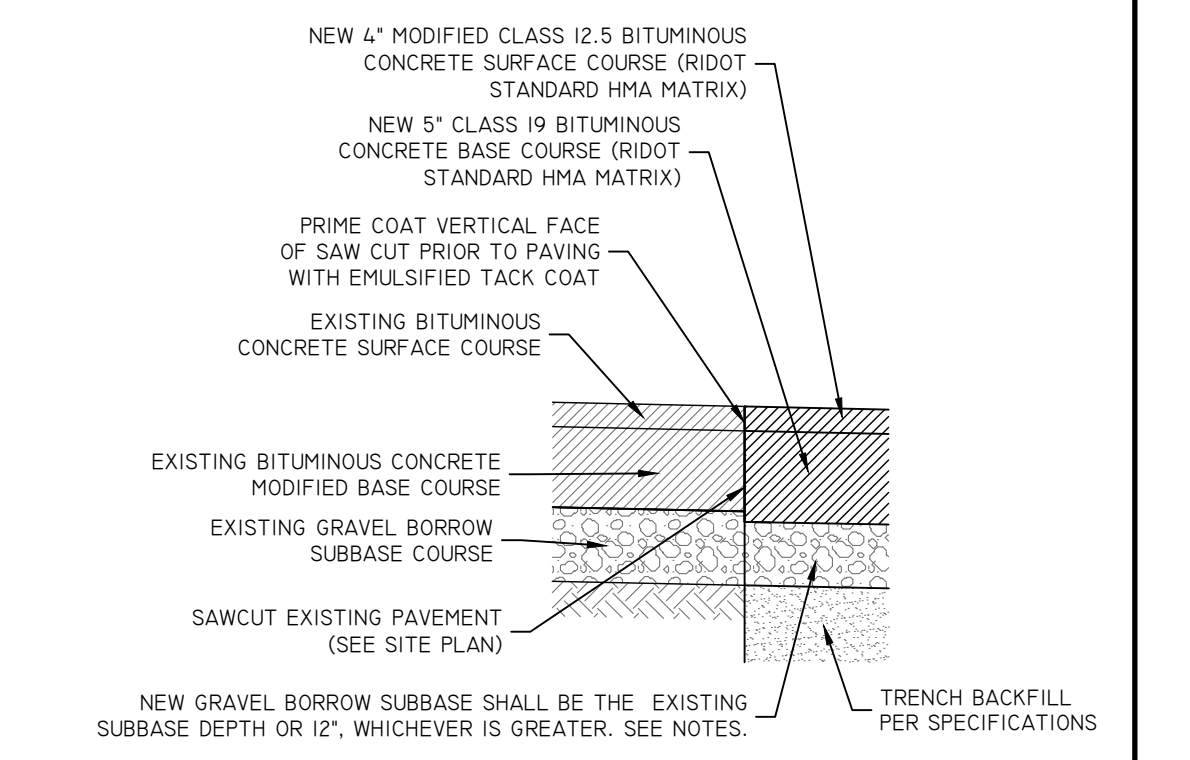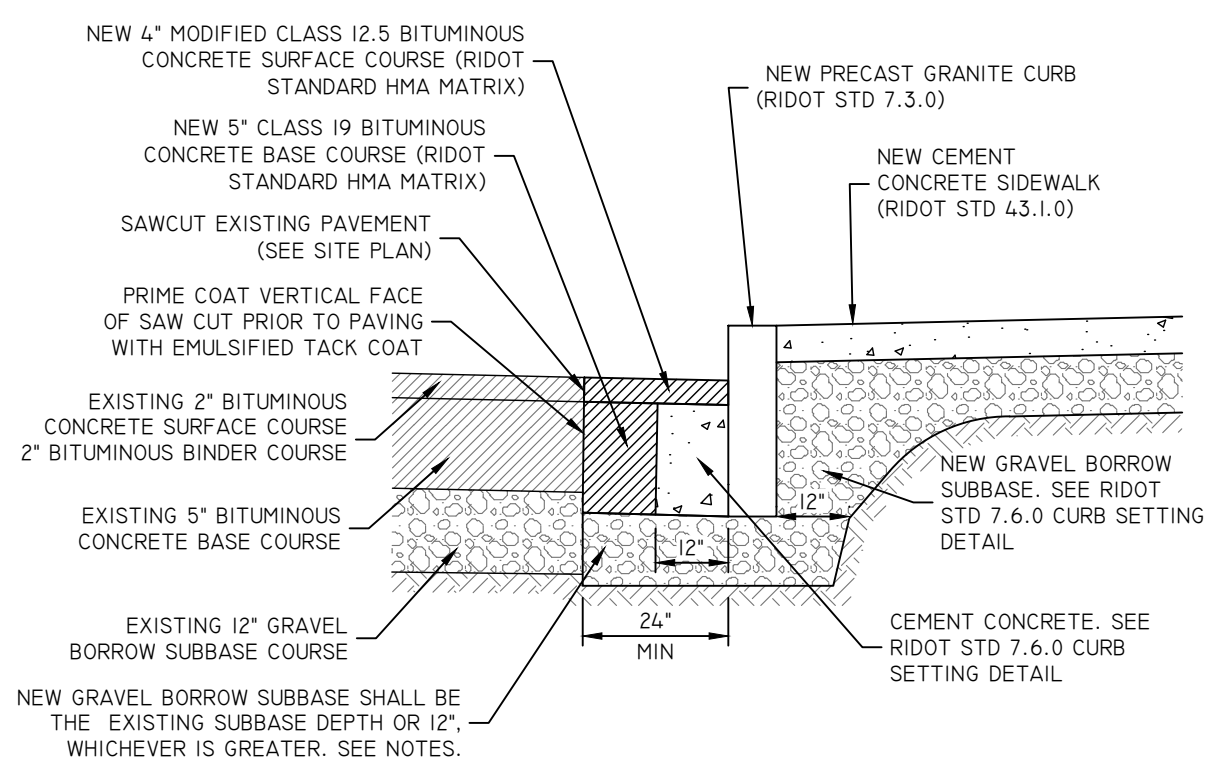


SECTION THROUGH NEW CURB & SIDEWALK - RIDOT
NOT TO SCALE


SECTION THROUGH TRENCH - RIDOT
NOT TO SCALE

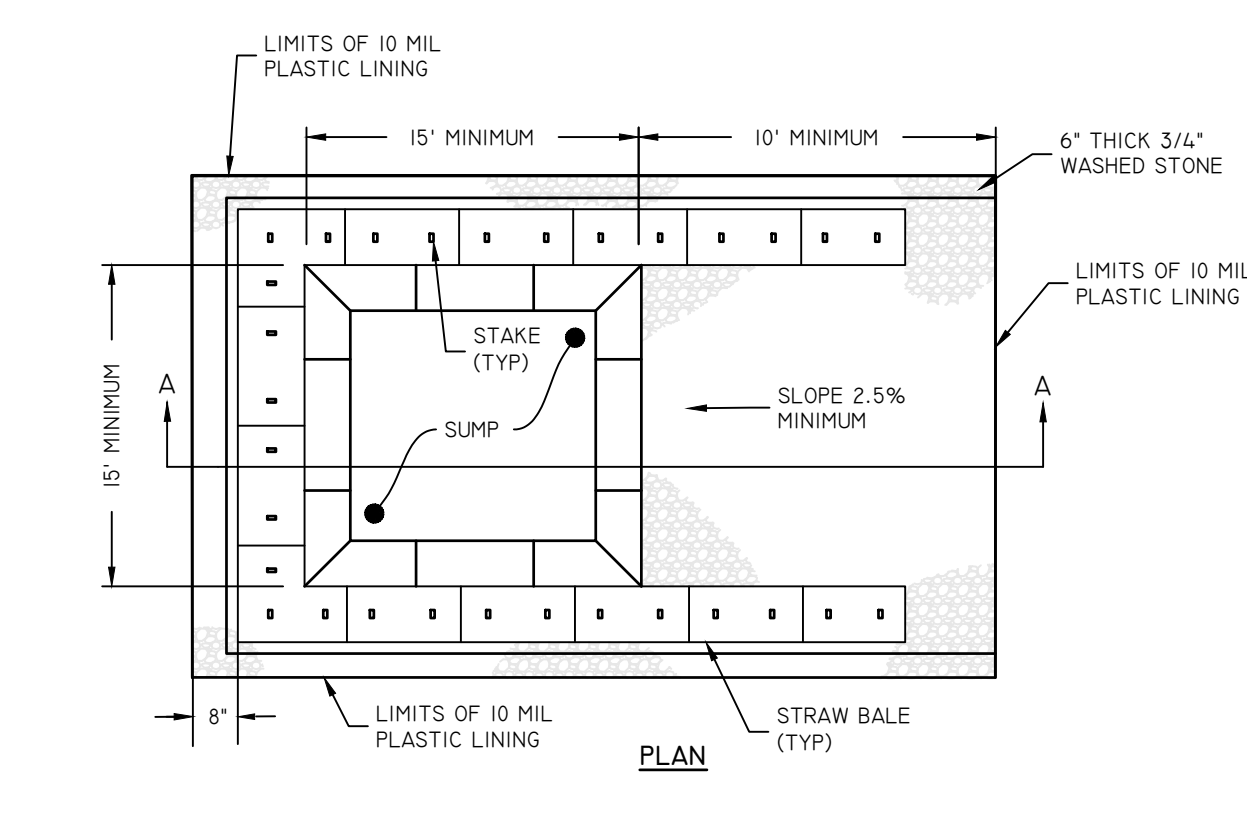


CONCRETE WASHOUT AREA
NOT TO SCALE

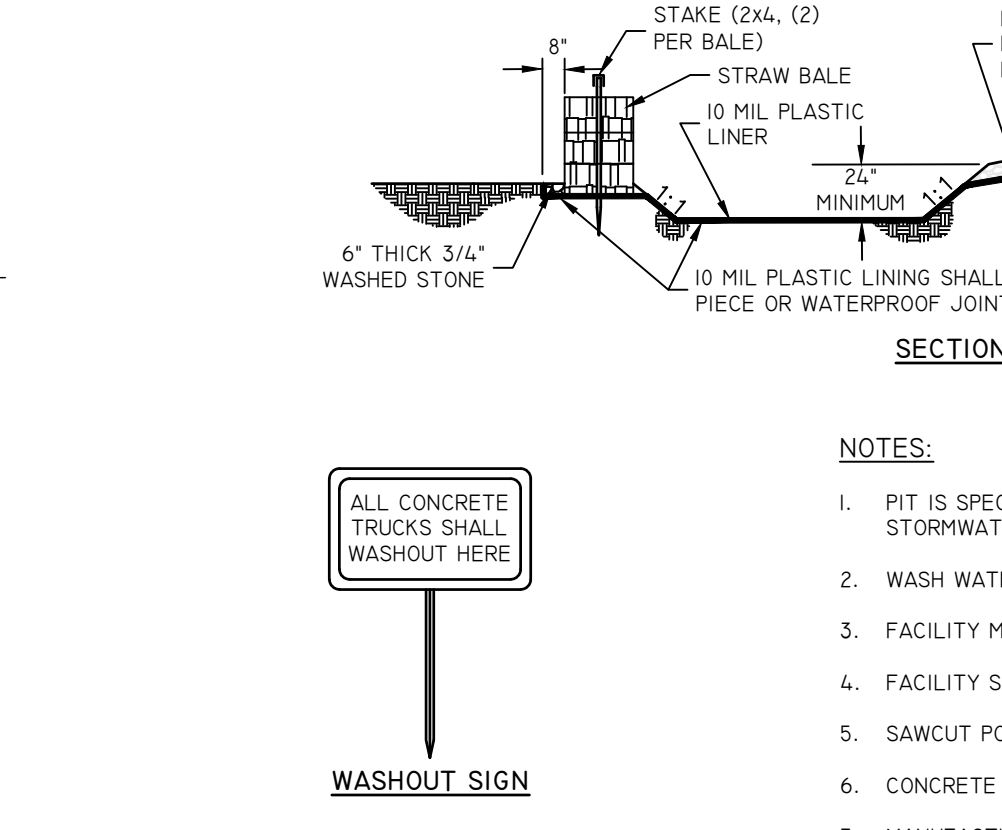


CONCRETE WASHOUT AREA
NOT TO SCALE

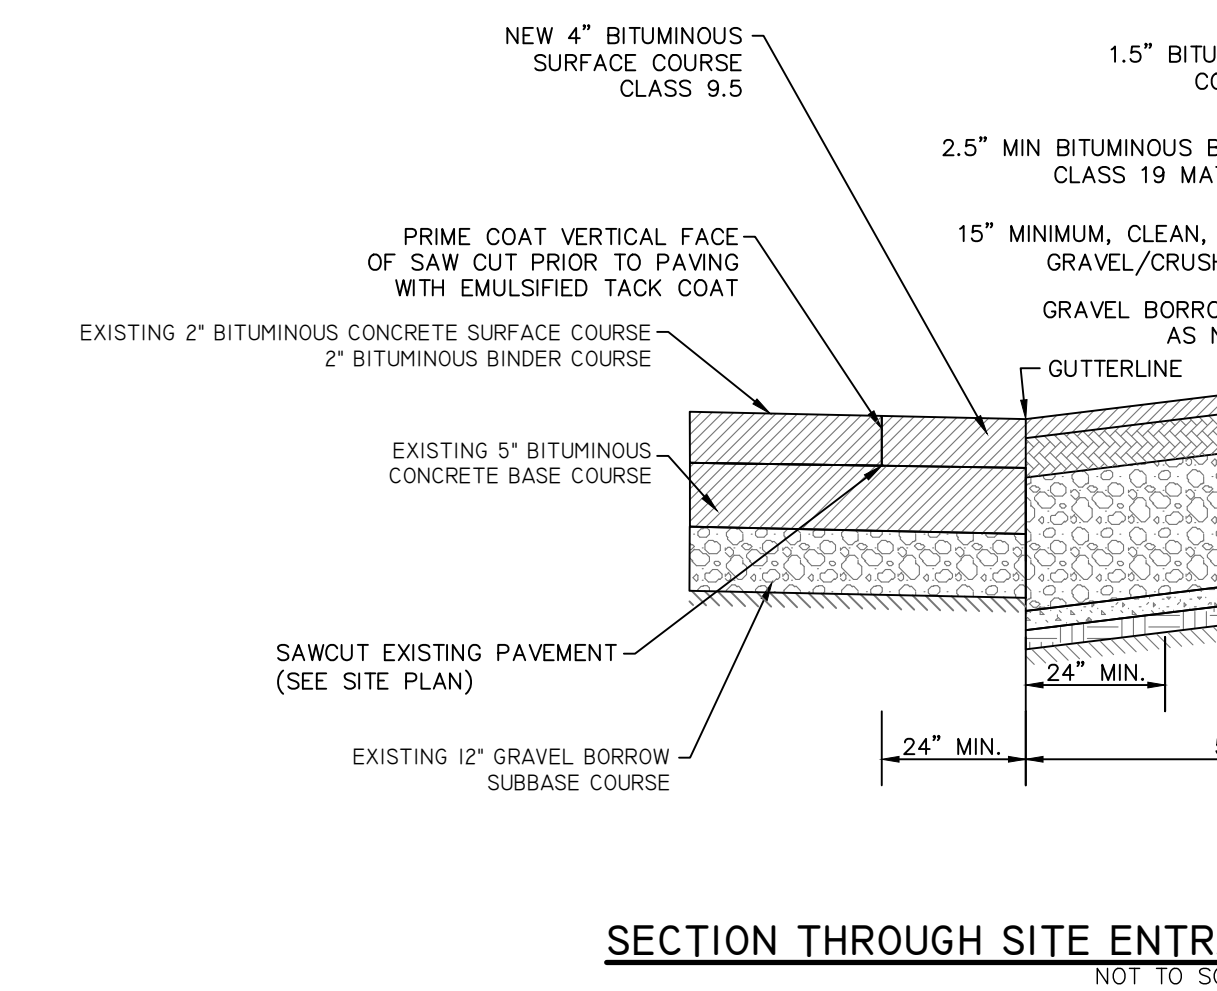


SECTION THROUGH SITE ENTRANCE/DRIVEWAYS - RIDOT
NOT TO SCALE

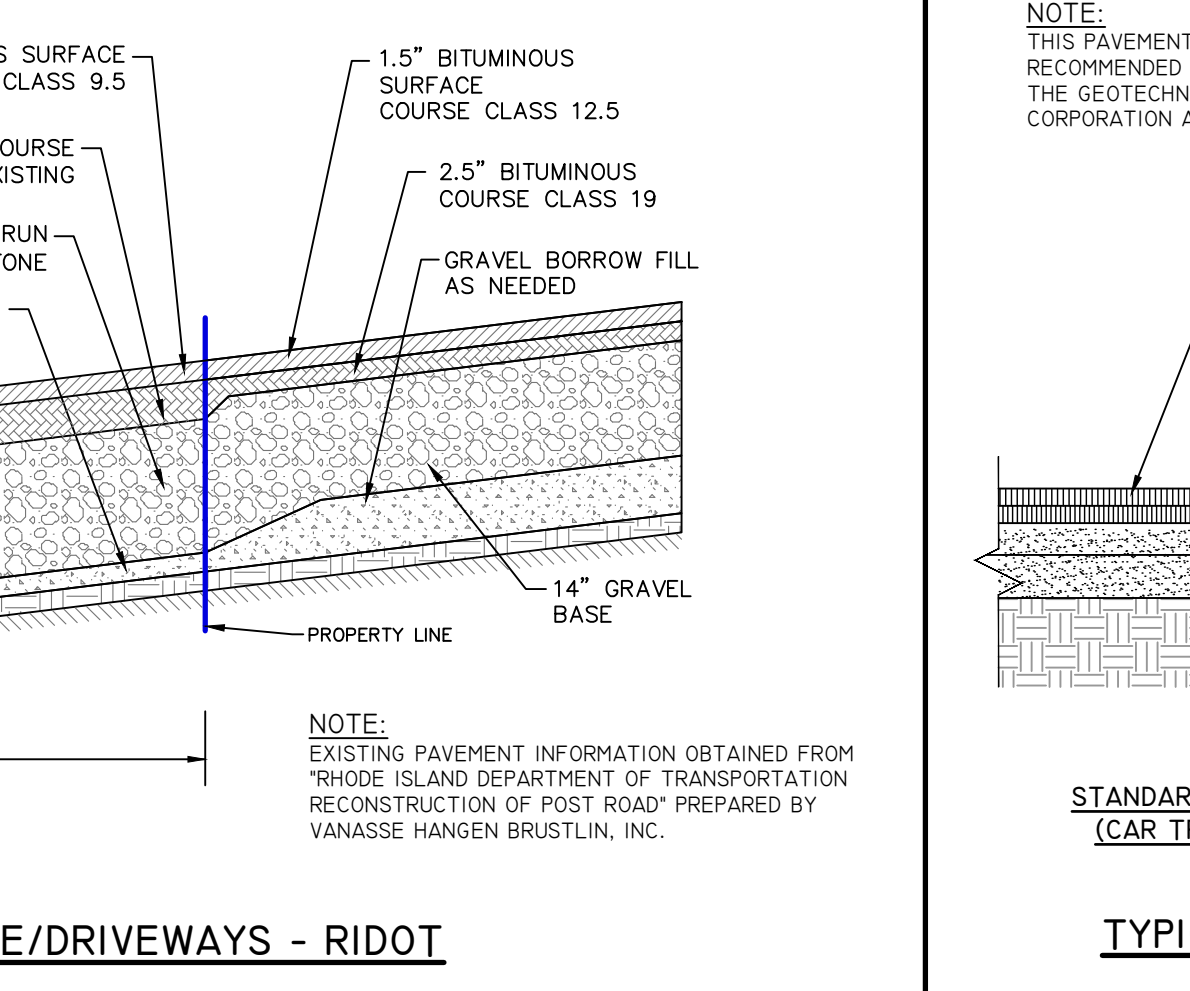


TYPICAL PAVEMENT SECTION
NOT TO SCALE

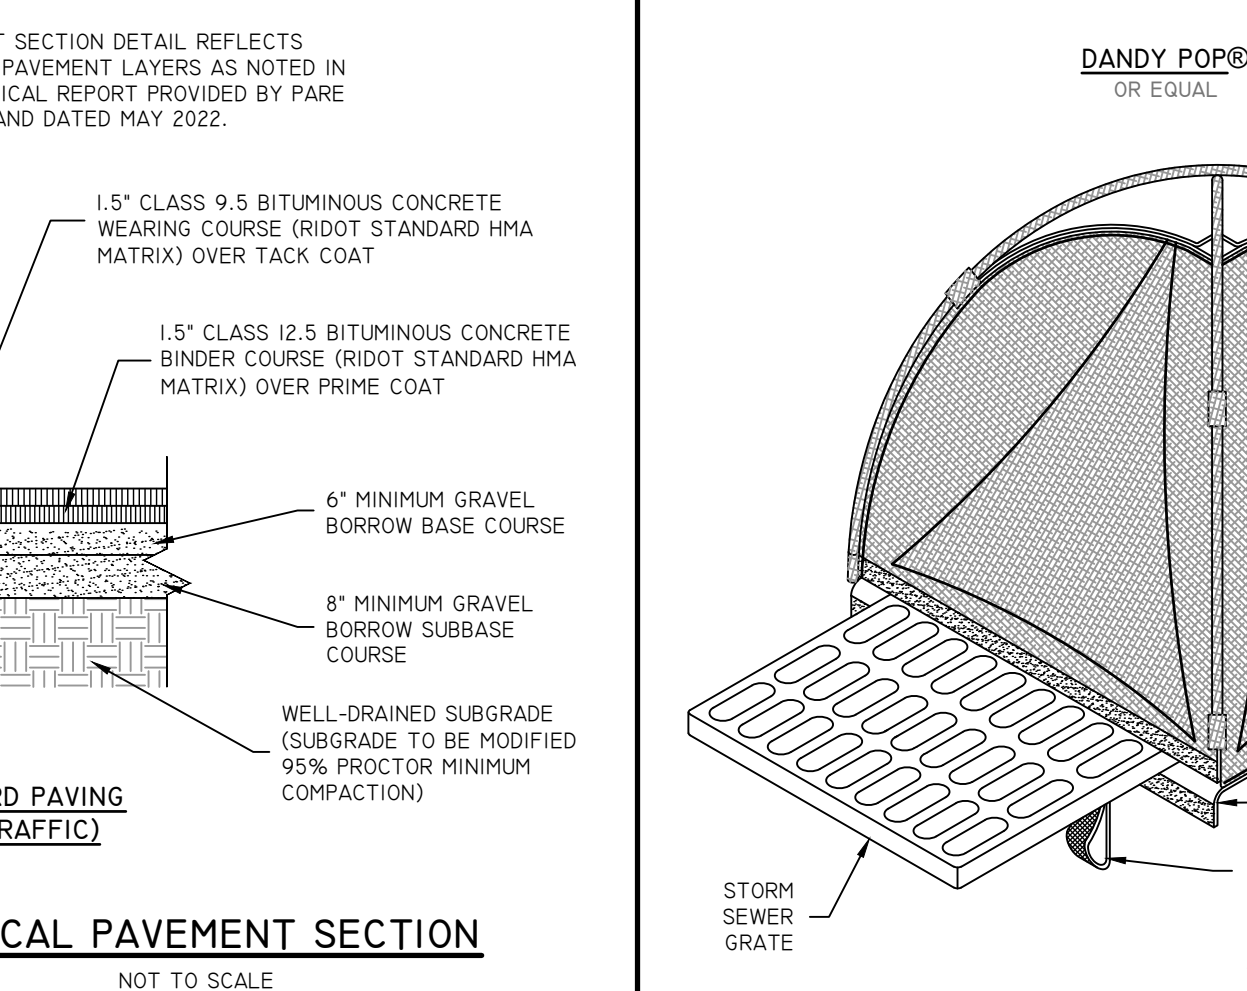


INLET SEDIMENT CONTROL DEVICES
NOT TO SCALE

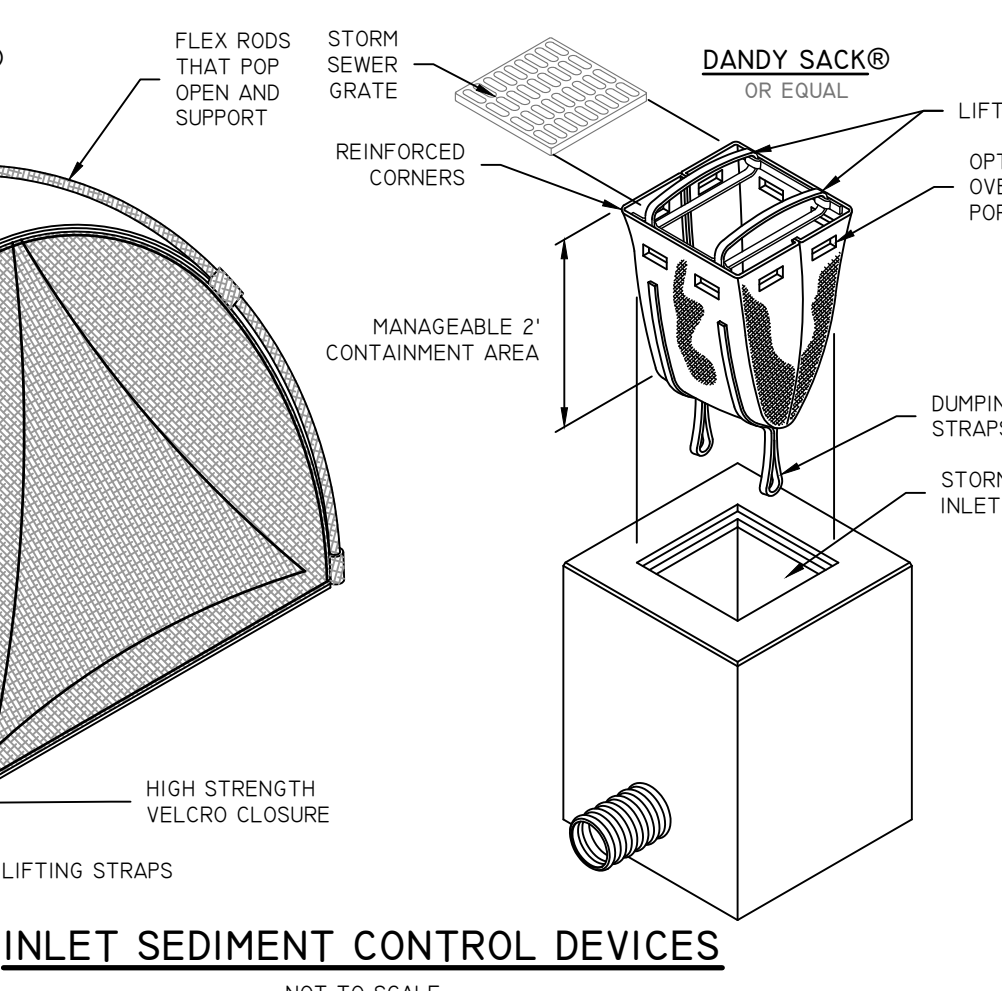


LIMIT OF DISTURBANCE AT VEGETATION
NOT TO SCALE

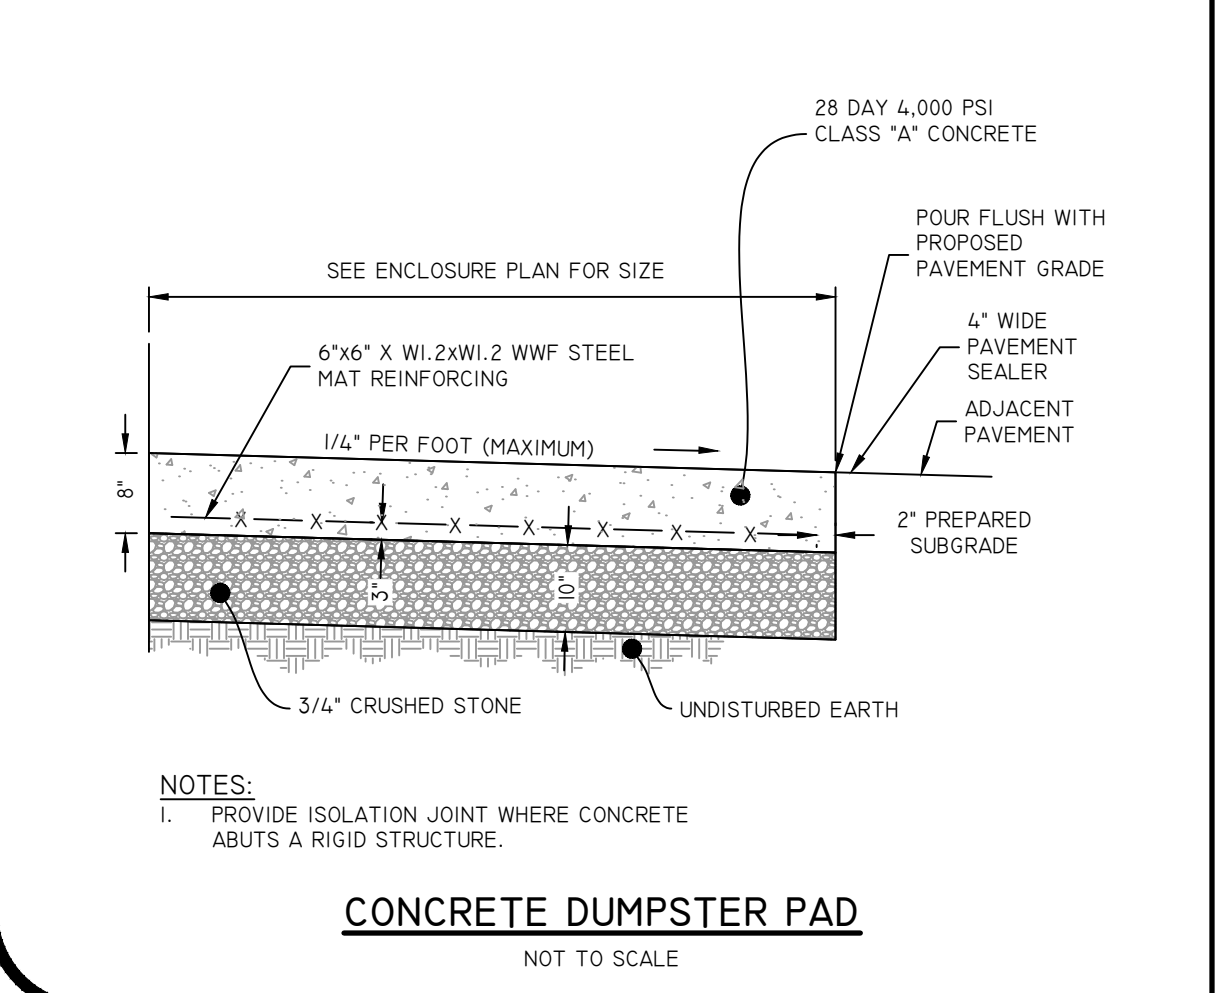


CONCRETE DUMPSTER PAD
NOT TO SCALE

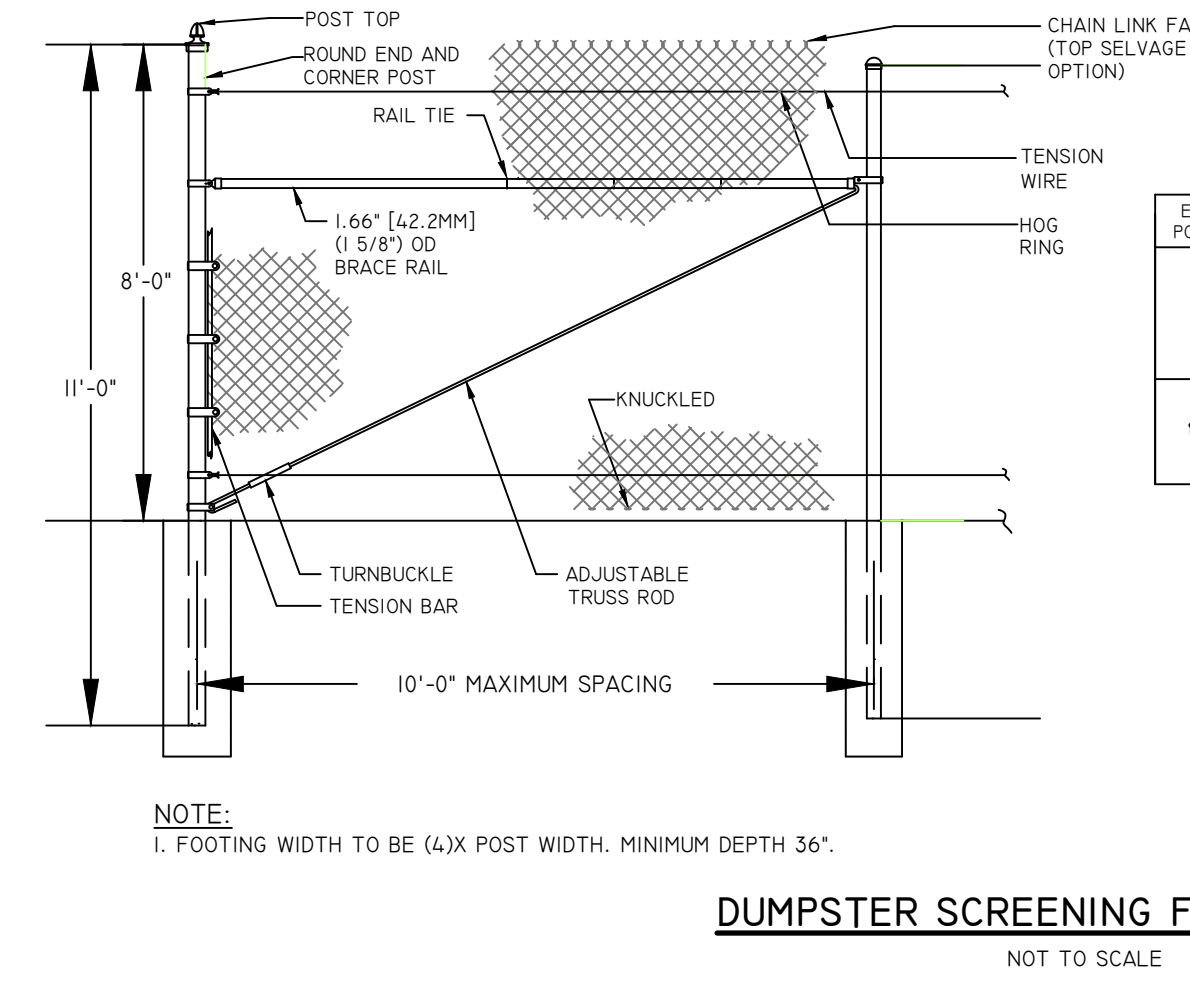


DUMPSTER SCREENING FENCE DETAIL
NOT TO SCALE

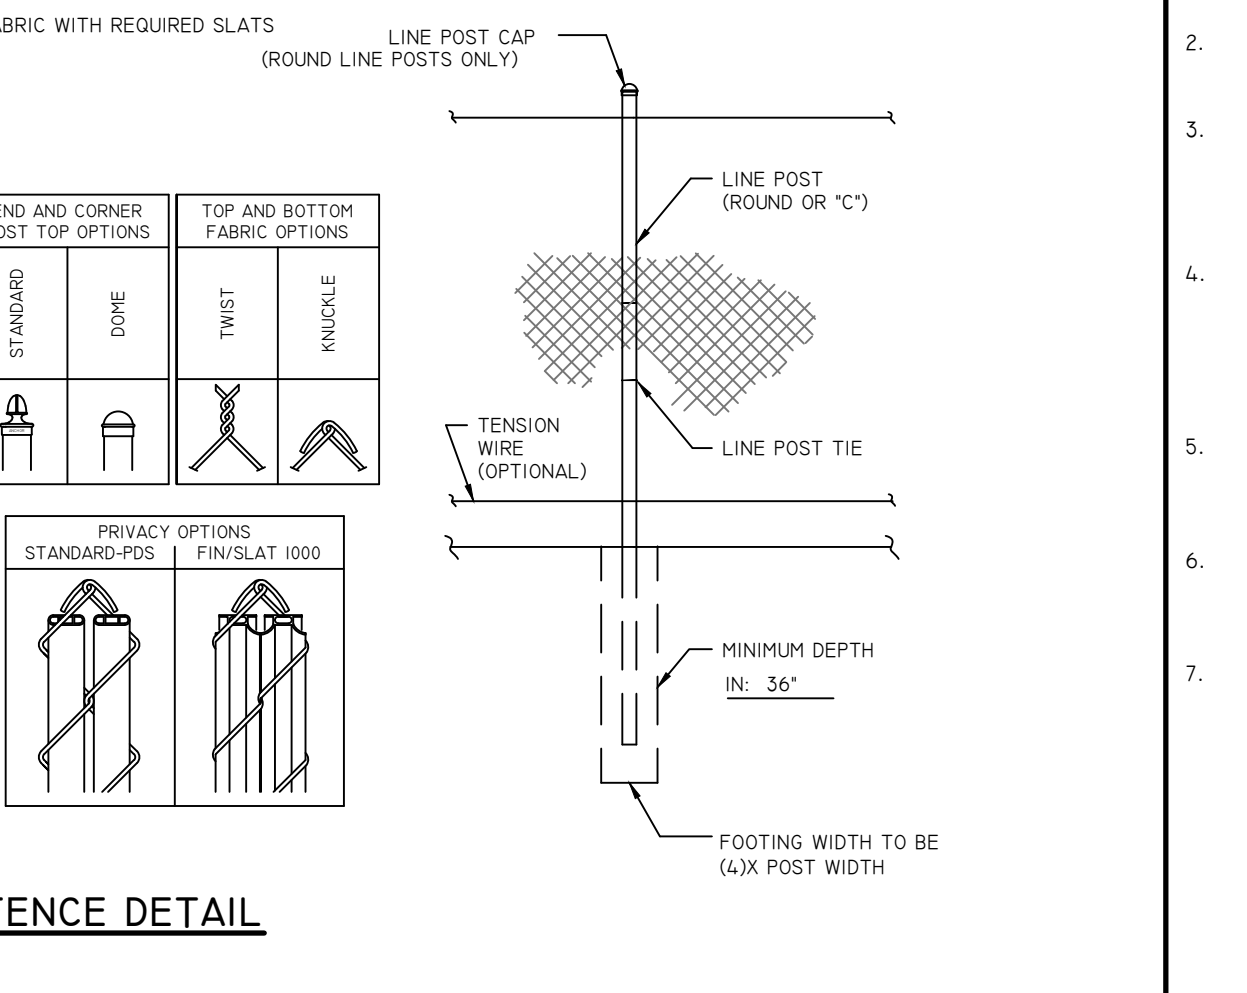

ADA NOTES

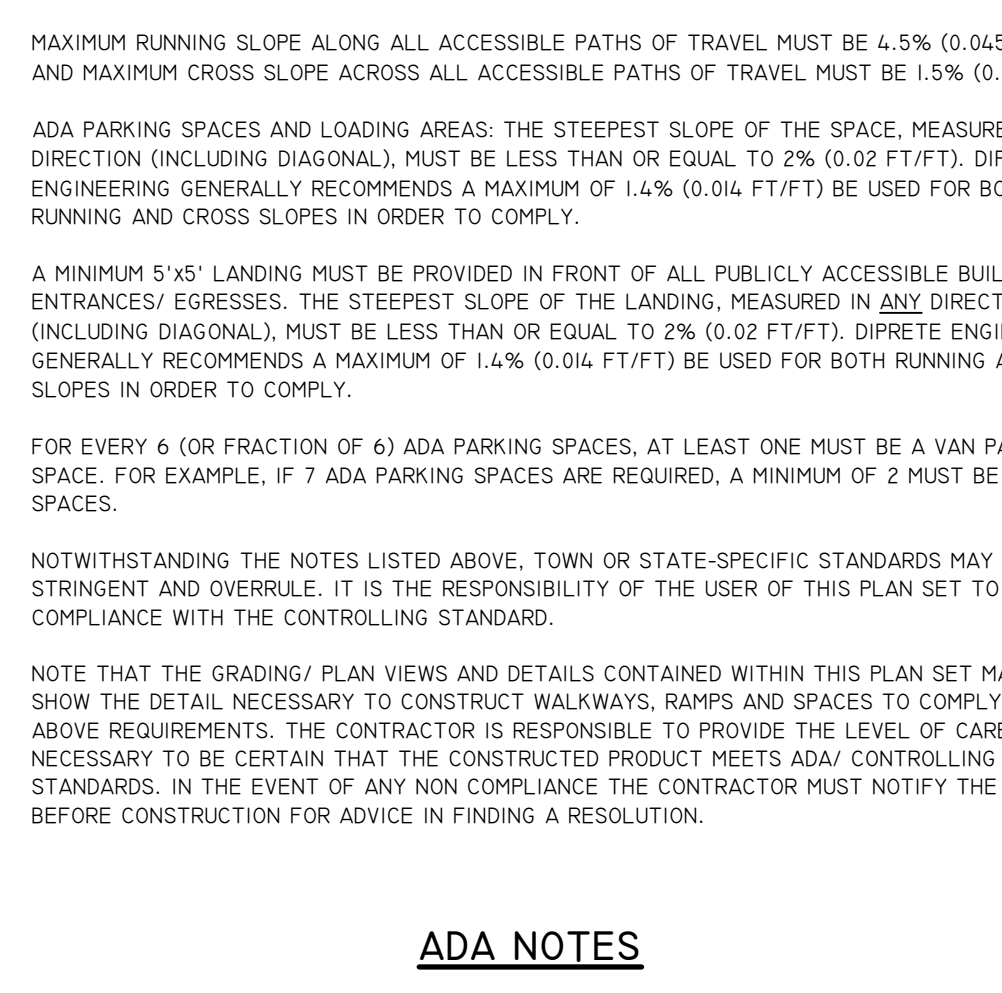

TYPICAL ACCESSIBLE PARKING SPACE
NOT TO SCALE

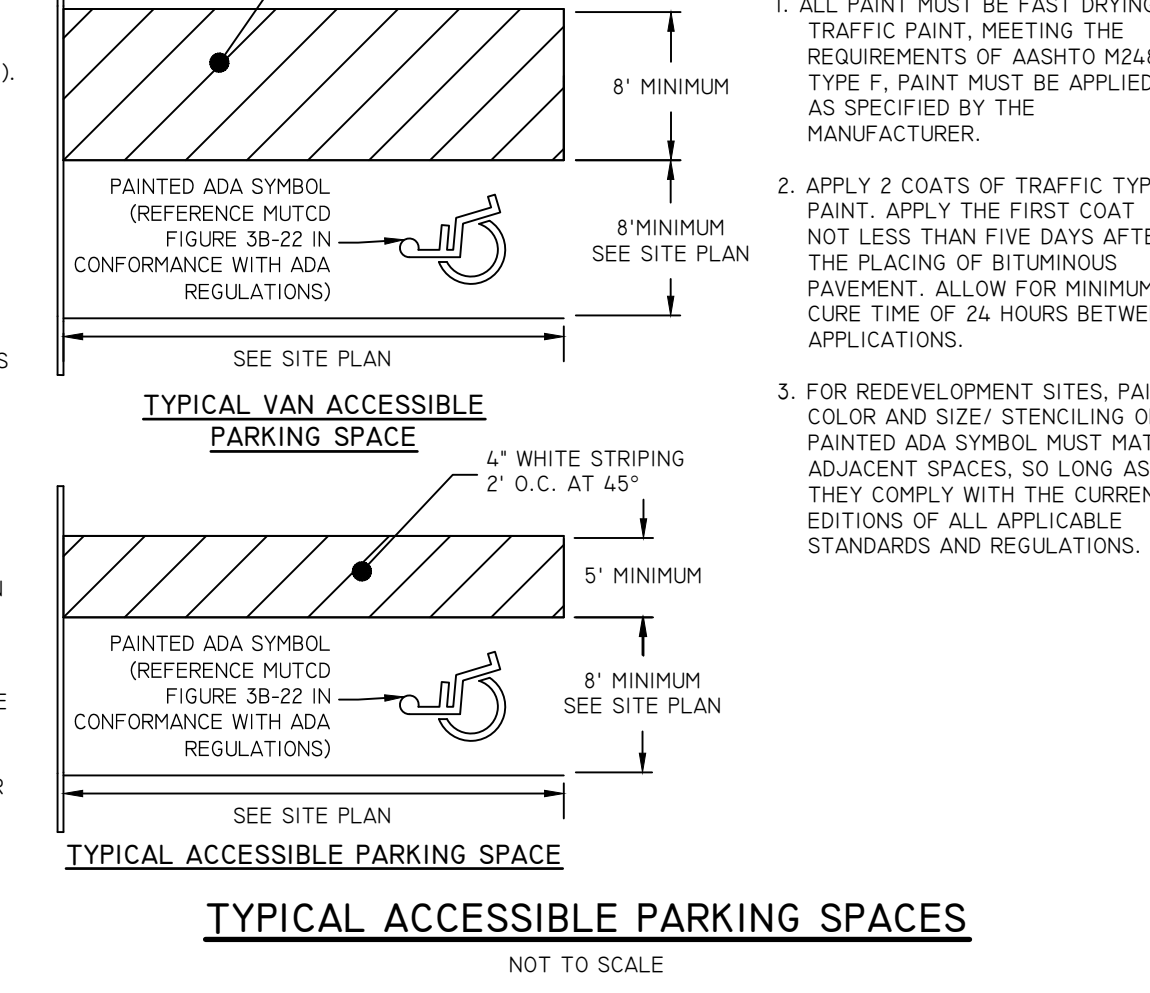

TYPICAL ACCESSIBLE PARKING SPACE
NOT TO SCALE

Diprete Engineering
Two Stafford Court Cranston, RI 02920
Tel: 401-943-1000 Fax: 401-664-6006 www.diprete-eng.com

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NO.	DATE	DESCRIPTION	BY	CHKD.
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DESIGN BY: J.A.R.
DRAWN BY: J.A.R.

DETAIL SHEET - 1
POST ROAD APARTMENTS
ASSASSOR'S PLAT 323 LOT 523
WARWICK, RHODE ISLAND

PREPARED FOR:
SKYDRA DEVELOPMENT
858 WASHINGTON STREET, SUITE #305, DEDHAM, MA 02026
TEL: 781-451-5600

DESIGNER:
DIPRETE ENGINEERING ASSOCIATES, INC.
2025-04-08-14:30


1. A MINIMUM OF TEN-FOOT HORIZONTAL AND EIGHTEEN-INCH VERTICAL SEPARATION SHALL BE MAINTAINED IN THE PLACEMENT OF WATER MAINS, SERVICES OR APPURTENANCES WITHIN THE VICINITY OF SEWER FACILITIES OR VICE VERSA. IN CASES WHERE IT IS NOT POSSIBLE TO MAINTAIN A 10-FOOT HORIZONTAL SEPARATION OR IN THE CASE OF CROSSING THE EIGHTEEN-INCH VERTICAL SEPARATION, A DEVIATION FROM THIS RESTRICTION MAY BE ALLOWED ON A CASE BY CASE BASIS WITH PRIOR APPROVAL FROM THE GENERAL MANAGER/CHIEF ENGINEER AS TO THE PROPOSED MATERIALS AND INTERVENTIONS TO BE TAKEN TO PROTECT THE WATER SYSTEM FROM THE POSSIBILITY OF CONTAMINATION.
2. WATER MAINS SHALL BE LAID WITH A MINIMUM OF TEN-FOOT HORIZONTAL CLEARANCE FROM ANY EXISTING SEWER FACILITIES. THE DISTANCE SHALL BE MEASURED EDGE TO EDGE. WATER MAINS CROSSING UNDER SEWERS SHALL BE FORBIDDEN. WATER MAINS CROSSING OVER SEWERS SHALL BE LAID TO PROVIDE A MINIMUM VERTICAL SEPARATION OF EIGHTEEN-INCHES BETWEEN THE INVERT OF THE WATER MAIN AND THE CROWN OF THE SEWER. RE-ALIGNMENT OF AN EXISTING WATER MAIN OR RELOCATION OF THE SEWER MAY BE NECESSARY TO ACHIEVE THIS VERTICAL SEPARATION. THE GENERAL MANAGER/CHIEF ENGINEER MUST APPROVE ANY DEVIATION FROM THESE REQUIREMENTS. CONCRETE ENCASMENT SHALL NOT BE ALLOWED IN THE DESIGN FOR SEWER AND WATER CROSSINGS.

**SEWER LINE/WATER LINE
SEPARATION POLICY**
NOT TO SCALE

1. ALL NEW OR REPAIRED POTABLE WATER SYSTEM DISTRIBUTION MAINS, SERVICE PIPE AND THE NECESSARY CONNECTING PIPES, FITTINGS, CONTROL VALVES, AND ALL APPURTENANCES IN OR ADJACENT TO ANY RESIDENCE, BUILDING OR PREMISES SHALL BE PURGED OF DELETERIOUS MATTER AND SHALL BE DISINFECTED PRIOR TO UTILIZATION OR PERMANENT CONNECTION TO THE KENT COUNTY WATER AUTHORITY (WARWICK WATER DEPARTMENT) SYSTEM. THAT PORTION OF THE CUSTOMER'S SERVICE PIPE AFTER THE CURB STOP SHALL BE DISINFECTED UNDER THE SUPERVISION OF THE LOCAL PLUMBING OFFICIAL. THE OWNER MUST PROVIDE WRITTEN LABORATORY CERTIFIED DOCUMENTATION OF THE DISINFECTION RESULTS TO THE WARWICK WATER DEPARTMENT BEFORE MAKING ANY PERMANENT CONNECTION TO THE WARWICK WATER DEPARTMENT SYSTEM OR BEFORE REACTIVATION OF ANY EXISTING WATER SERVICE CAN BE AUTHORIZED. PLEASE REFER TO APPENDICES FOR PROGRAM REQUIREMENTS OF THE CUSTOMER WATER SERVICE DISINFECTION POLICY.
2. THE PROPOSER OR THE CONTRACTOR FOR THE PROPOSER, IN ACCORDANCE WITH CHAPTER 5, DISTRIBUTION SYSTEM CHLORINATION, AMERICAN WATER WORKS ASSOCIATION MANUAL #20, SHALL PERFORM CHLORINATION. TABLET CHLORINATION SHALL NOT BE ALLOWED.
3. THE OWNER OR CUSTOMER IS RESPONSIBLE FOR ALL COSTS ASSOCIATED WITH THE DISINFECTION PROCESS OR PROCEDURE.
4. THE DISINFECTION MUST RESULT IN ELIMINATION FROM THE VARIOUS PARTS OF THE NEW PIPE LINE ANY EVIDENCE OF THE EXISTENCE, THEREIN, OF BACTERIA INDICATIVE OF ANY CONTAMINATION. AS DETERMINED BY TEST OF THE BACTERIAL CONTENT OF SAMPLES OF WATER TAKEN FROM THE NEW WATER MAIN. THE DISINFECTION MAY BE ACCOMPLISHED BY INTRODUCING INTO ALL THE VARIOUS PARTS OF THE NEW WATER MAINS, A LIQUID SOLUTION CONTAINING 1% AVAILABLE CHLORINE IN SUCH VOLUME THAT THE RATE OF DOSAGE TO THE WATER MAINS SHALL BE AT LEAST 50 PARTS PER MILLION OF AVAILABLE CHLORINE. TABLET CHLORINATION IS NOT ALLOWED. THE CONTACT PERIOD FOR THIS DISINFECTION SHALL BE AT LEAST 24 HOURS, AND A LONGER PERIOD WILL BE REQUIRED IF TESTS OF RESIDUAL CHLORINE SHOW IT TO BE NECESSARY FOR PROPER DISINFECTION.
5. THE NEW WATER SYSTEM SHALL BE FLUSHED OUT AFTER DISINFECTION AND REFILLED WITH FRESH WATER. ALL CHLORINATED WATER USED IN THE DISINFECTION PROCESS SHALL BE DE-CHLORINATED PRIOR TO DISCHARGE TO THE SURROUNDING AREA.
6. WATER MUST SIT IN THE MAIN FOR AT LEAST 24 HOURS PRIOR TO TAKING A TEST SAMPLE. WATER UTILIZED FOR THIS PURPOSE, FLUSHING OR PRESSURE TESTING, WHICH IS OBTAINED DIRECTLY FROM THE WARWICK WATER DEPARTMENT SYSTEM, MUST FLOW THROUGH AN ISOLATED CONNECTION TO THE WARWICK WATER DEPARTMENT SYSTEM VIA AN APPROVED METER, TESTABLE BACKFLOW PREVENTION DEVICE AND JUMPER LINE. THE CONTRACTOR SHALL MAKE ALL NECESSARY ARRANGEMENTS FOR SECURING THE WATER FOR TEST PURPOSES AND SHALL BEAR THE EXPENSE OF THESE ARRANGEMENTS. THE INSTALLER SHALL FURNISH AND INSTALL SUITABLE TEMPORARY TESTING PLUGS, CAPS, PUMPS, PIPE CONNECTIONS AND OTHER APPURTENANCES, AS NECESSARY, TO OBTAIN SAMPLES AT POINTS NO FURTHER THAN 1,000' APART.
7. AFTER FINAL FLUSHING AND BEFORE THE NEW WATER MAIN IS CONNECTED TO THE DISTRIBUTION SYSTEM, TWO CONSECUTIVE SETS OF ACCEPTABLE SAMPLES FOR COLIFORM BACTERIA HETEROTROPHIC PLATE COUNT (HPC), TAKEN 24 HOURS APART, SHALL BE COLLECTED FROM THE TERMINATION OF THE NEW MAIN. AT LEAST ONE SAMPLE SHALL BE COLLECTED EVERY 1,000' OF NEW MAIN, PLUS ONE SET OF TWO SAMPLES FROM THE END OF THE LINE. AT LEAST ONE SET OF TWO SAMPLES SHALL BE TAKEN FROM EACH BRANCH. SAMPLES SHALL BE COLLECTED BY WARWICK WATER DEPARTMENT EMPLOYEES, GIVEN A TWO-DAY NOTICE AND TESTED BY A LABORATORY APPROVED BY WARWICK WATER DEPARTMENT. A FEE SHALL BE IMPOSED FOR THE SAMPLING TESTING FOR EACH TEST. THE FEE SHALL BE AT THE CURRENT RATE SCHEDULED IN EFFECT AT THE TIME OF TESTING. PAYMENT SHALL BE PRIOR TO SAMPLE COLLECTION BY THE WARWICK WATER DEPARTMENT. THE WATER SAMPLE TEST RESULTS MUST INDICATE THAT THE WATER QUALITY IN THE NEW MAIN IS CONSISTENT IN QUALITY WITH WARWICK WATER DEPARTMENT SYSTEM WATER.

CHLORINATION & DISINFECTION POLICY*
NOT TO SCALE


- NOTES:
1. MANHOLE SHALL BE MANUFACTURED IN ACCORDANCE WITH ASTM-C478.
 2. INVERT AND TABLE SHALL CONSIST ENTIRELY OF BRICK AND MORTAR. NO SAND FILLER SHALL BE ALLOWED.
 3. MANHOLES SHALL BE VACUUM TESTED PRIOR TO ACCEPTANCE, IN ACCORDANCE WITH THE SEWER AUTHORITY SANITARY RULES AND REGULATIONS. UNDER NO CIRCUMSTANCES WILL EXFILTRATION TESTING BE ACCEPTED.
 4. BOLTED AND GASKETED COVERS SHALL BE USED ON MANHOLES IN OFF-ROAD AREAS.
 5. TAPPING OF MANHOLES MUST BE AUTHORIZED AND INSPECTED BY THE SEWER AUTHORITY. THE ONLY APPROVED METHOD OF TAPPING AT MANHOLES SHALL BE BY CORE-DRILLING THE MANHOLE AND INSTALLING A "KOR-N-SEAL" BOOT.
 6. PRECAST CONCRETE GRADE RINGS, HDPE GRADE RINGS, OR OTHER RIM ADJUSTMENT PRODUCTS MAY BE USED IN LIEU OF BRICK AND MORTAR WITH THE PERMISSION OF THE SEWER AUTHORITY.

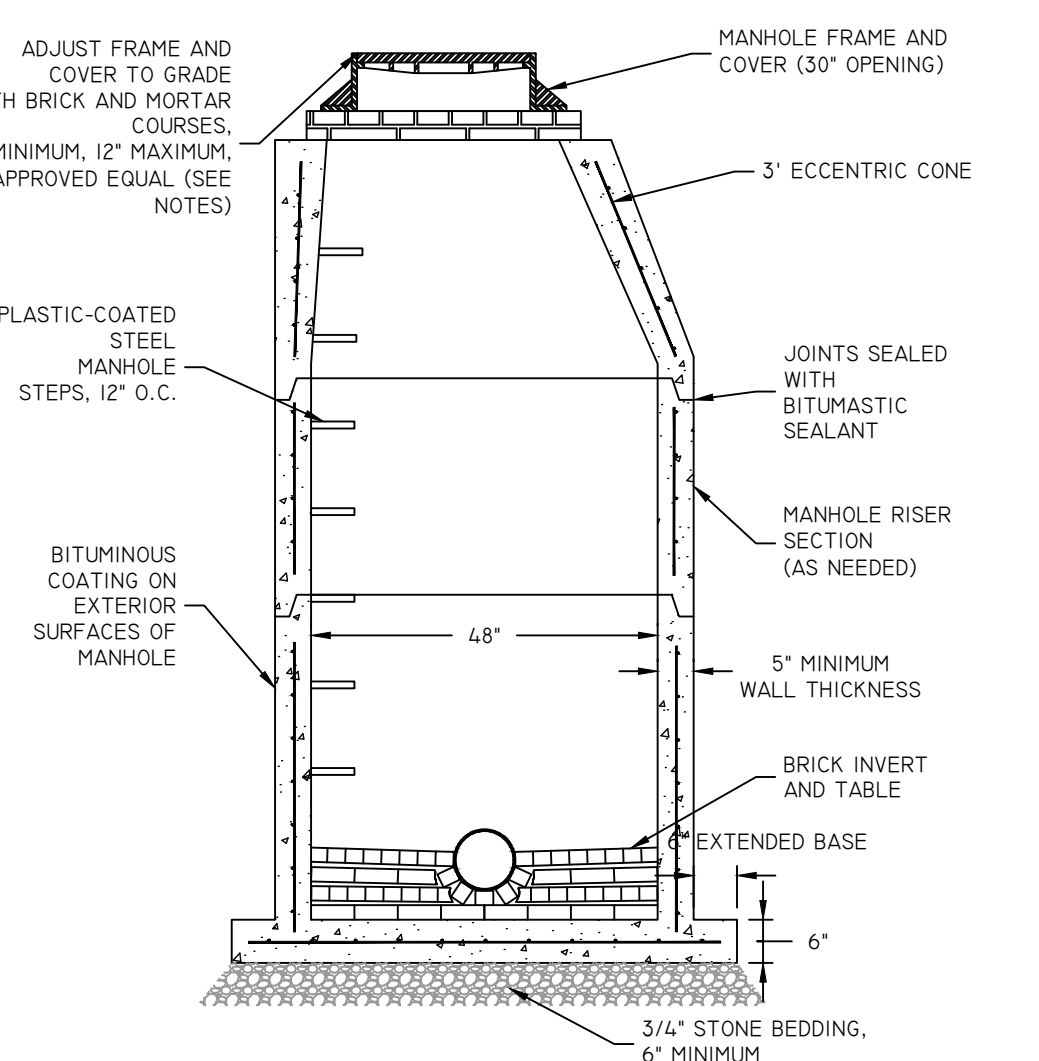

SEWER MANHOLE
NOT TO SCALE

- NOTES:
1. ALL CONCRETE SHALL BE 4,000 P.S.I. @ 28 DAYS
 2. CONCRETE THRUST BLOCKS SHALL BEAR AGAINST UNDISTURBED EARTH
 3. FORMS TO BE USED AS NECESSARY
 4. ALL BOLTS AND NUTS TO BE PROTECTED FROM CONCRETE AND EASILY ACCESSIBLE WHEN THRUST BLOCK INSTALLED
 5. REGISTERED PROFESSIONAL ENGINEER IN THE STATE OF RHODE ISLAND SHALL VERIFY CALCULATIONS DURING DESIGN TO MEET CONDITIONS OF PROJECT.


SIZE	TEES			PLUGS			90° BEND		45° BEND		22.5° BEND		11.25° BEND	
	A	B	C	D	A	B	A	B	A	B	A	B	A	B
6"	20"	10"	10"	21"	24"	12"	18"	9"	15"	7"	9"	5"		
8"	26"	13"	12"	26"	32"	16"	24"	12"	17"	9"	12"	6"		
10"	34"	17"	14"	34"	40"	20"	30"	15"	22"	11"	15"	8"		
12"	41"	20"	16"	41"	48"	24"	35"	18"	25"	13"	18"	9"		
16"	54"	27"	20"	54"	64"	32"	47"	23"	34"	17"	24"	12"		

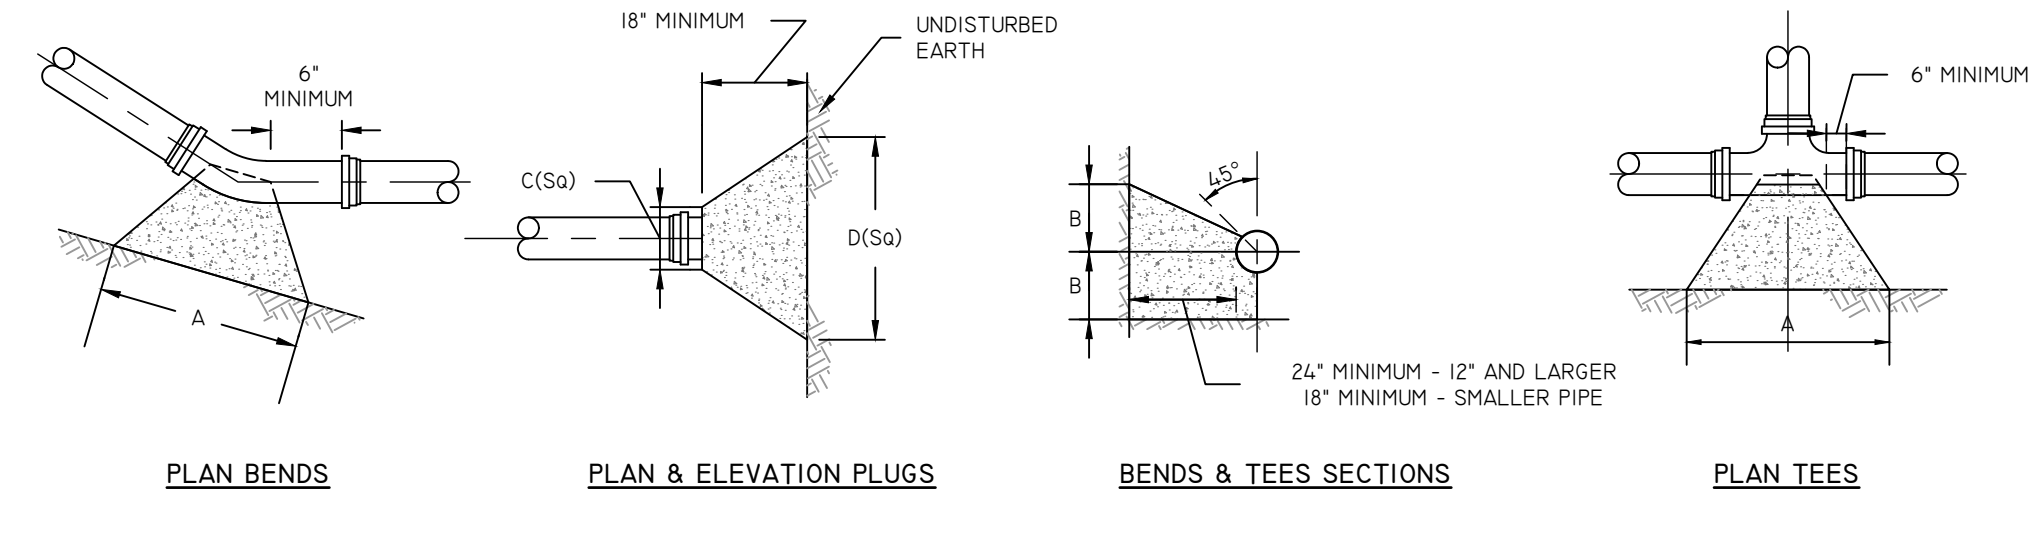


THRUST BLOCK
NOT TO SCALE

PIPE Ø	MIN. TRENCH WIDTH	PIPE Ø	MIN. TRENCH WIDTH
4"	21"	24"	48"
6"	23"	30"	56"
8"	26"	36"	64"
10"	28"	42"	72"
12"	30"	48"	80"
15"	34"	60"	96"
18"	39"		


- INSTALLATION NOTES:**
1. ALL PIPE SYSTEMS SHALL BE INSTALLED IN ACCORDANCE WITH ASTM D2321, "STANDARD PRACTICE FOR UNDERGROUND INSTALLATION OF THERMOPLASTIC PIPE FOR SEWERS AND OTHER GRAVITY FLOW APPLICATIONS, LATEST ADDITION.
 2. MEASURES SHOULD BE TAKEN TO PREVENT MIGRATION OF NATIVE FINES INTO BACKFILL MATERIAL, WHEN REQUIRED.
 3. FOUNDATION: WHERE THE TRENCH BOTTOM IS UNSTABLE, THE CONTRACTOR SHALL EXCAVATE TO A DEPTH REQUIRED BY THE ENGINEER AND REPLACE WITH SUITABLE MATERIAL AS SPECIFIED BY THE ENGINEER. AS AN ALTERNATIVE AND AT THE DISCRETION OF THE DESIGN ENGINEER, THE TRENCH BOTTOM MAY BE STABILIZED USING A GEOTEXTILE MATERIAL.
 4. BEDDING: SUITABLE MATERIAL SHALL BE CLASS I, II OR III. THE CONTRACTOR SHALL PROVIDE DOCUMENTATION FOR MATERIAL SPECIFICATION TO ENGINEER. UNLESS OTHERWISE NOTED BY THE ENGINEER, MINIMUM BEDDING THICKNESS SHALL BE 4" (100MM) FOR 4"-24" (100MM-600MM); 6" (150MM) FOR 30"-60" (750MM-900MM).
 5. INITIAL BACKFILL: SUITABLE MATERIAL SHALL BE CLASS I, II OR III IN THE PIPE ZONE EXTENDING NOT LESS THAN 6" ABOVE CROWN OF PIPE. THE CONTRACTOR SHALL PROVIDE DOCUMENTATION FOR MATERIAL SPECIFICATION TO ENGINEER. MATERIAL SHALL BE INSTALLED AS REQUIRED IN ASTM D2321, LATEST EDITION.
 6. MINIMUM COVER: MINIMUM COVER, H, IN NON-TRAFFIC APPLICATIONS (GRASS OR LANDSCAPE AREAS) IS 12" FROM THE TOP OF PIPE TO GROUND SURFACE. ADDITIONAL COVER MAY BE REQUIRED TO PREVENT FLOTATION, FOR TRAFFIC APPLICATIONS, MINIMUM COVER, H, IS 12" UP TO 48" Ø PIPE AND 24" OF COVER FOR 60" Ø PIPE. MEASURED FROM TOP OF PIPE TO BOTTOM OF FLEXIBLE PAVEMENT OR TO TOP OF RIGID PAVEMENT.

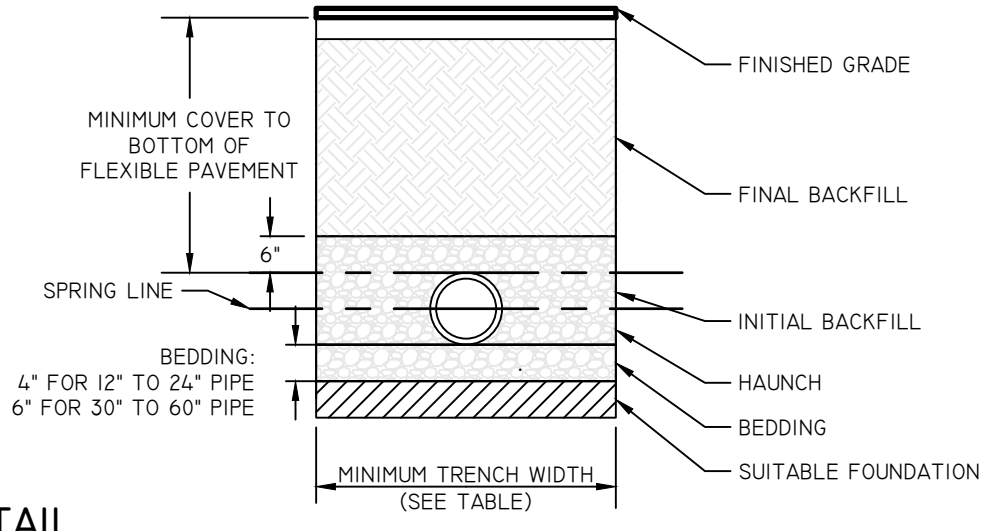


HDPE TRENCH DETAIL
NOT TO SCALE

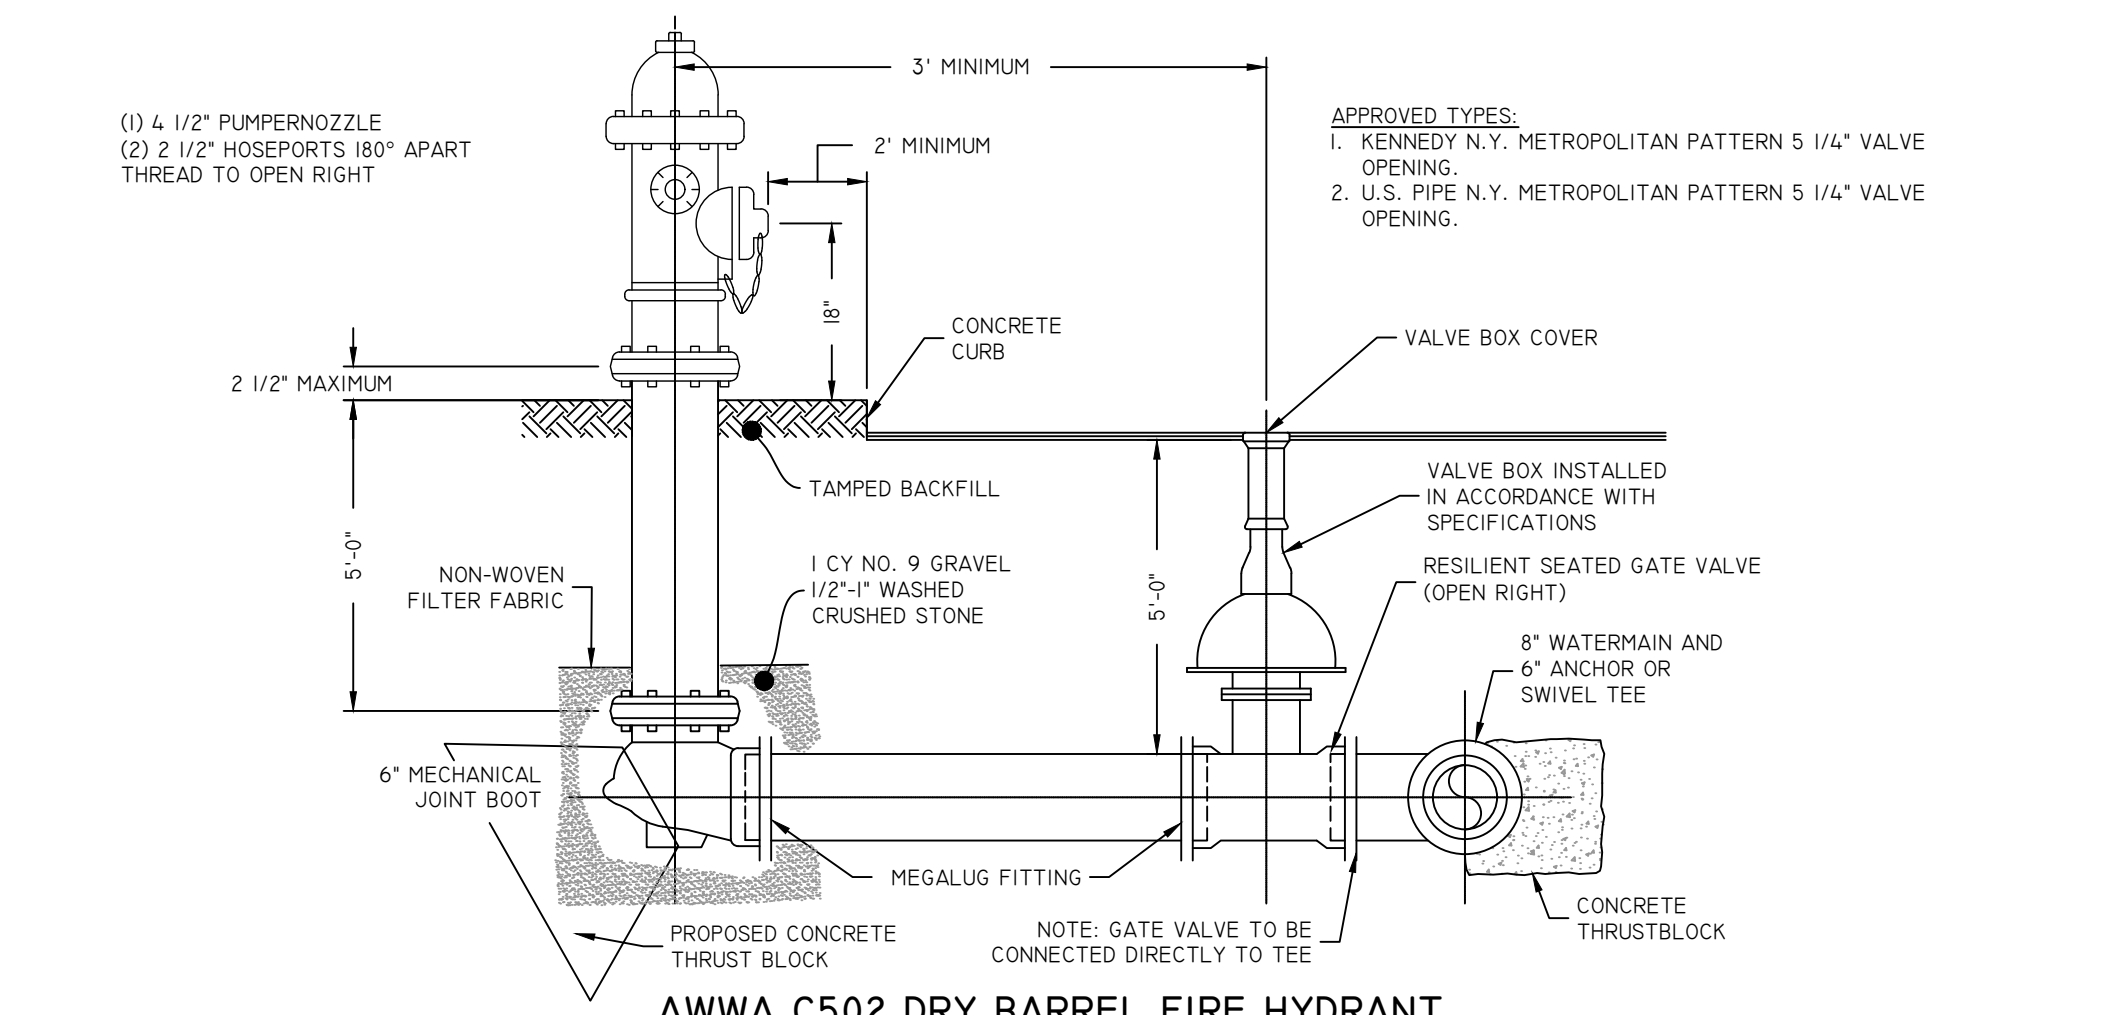

AWWA C502 DRY BARREL FIRE HYDRANT
NOT TO SCALE

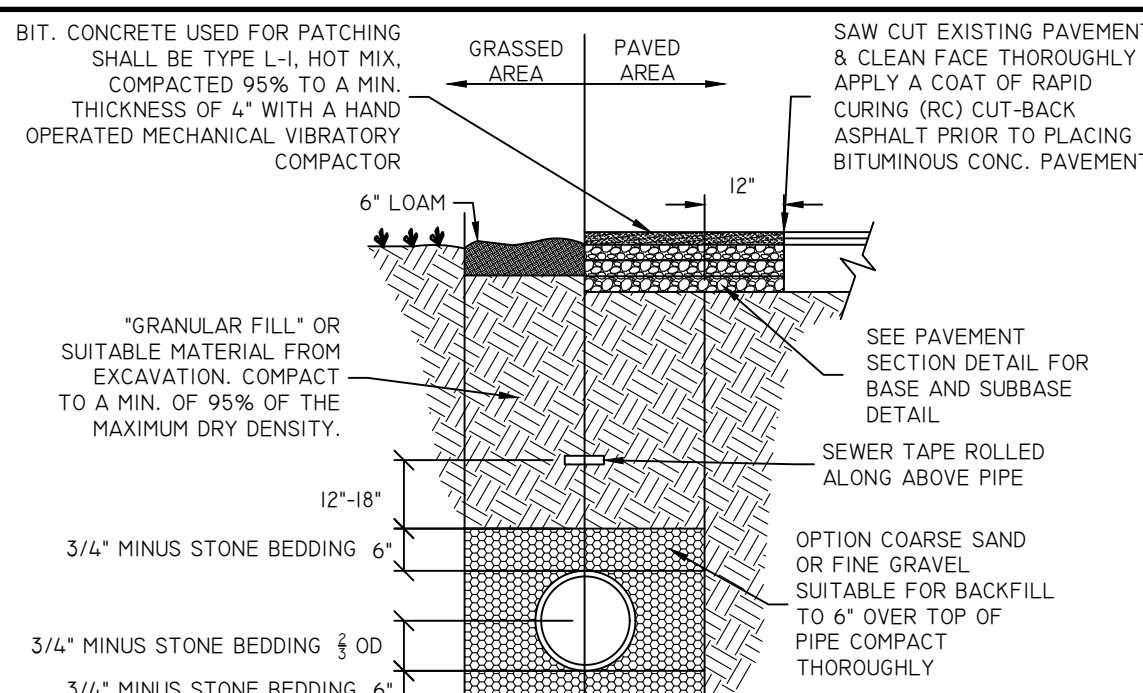


SEWER TRENCH DETAIL
NOT TO SCALE

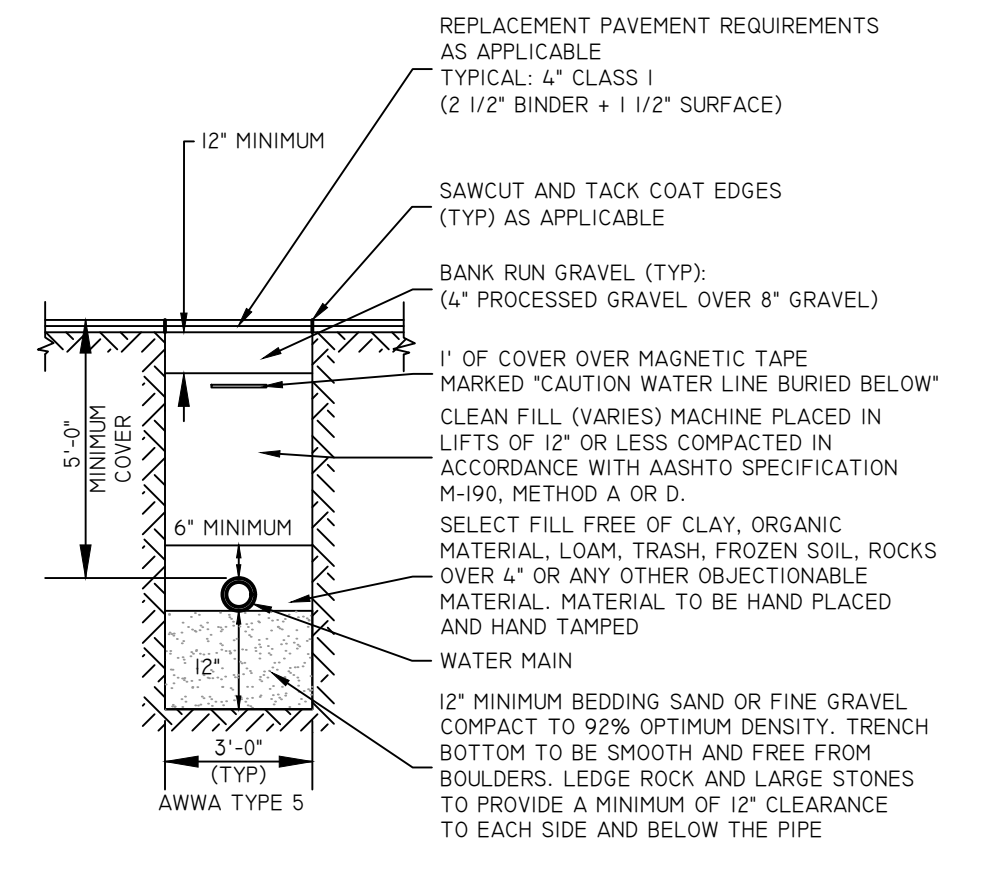


WATER TRENCH DETAIL
NOT TO SCALE

- NOTES:
1. THE VERTICAL SEPARATION BETWEEN THE WATER MAIN AND THE PROPOSED UTILITY SHOULD BE A MINIMUM OF 18".
 2. THE HORIZONTAL SEPARATION BETWEEN THE WATER MAIN AND THE PROPOSED UTILITY SHALL BE A MINIMUM OF 10".
 3. IF 1' OR 2' CAN NOT BE MAINTAINED THE PROPOSED UTILITY IS TO BE ENCASED IN CONCRETE 12" ON EITHER SIDE OF THE CROSSING.

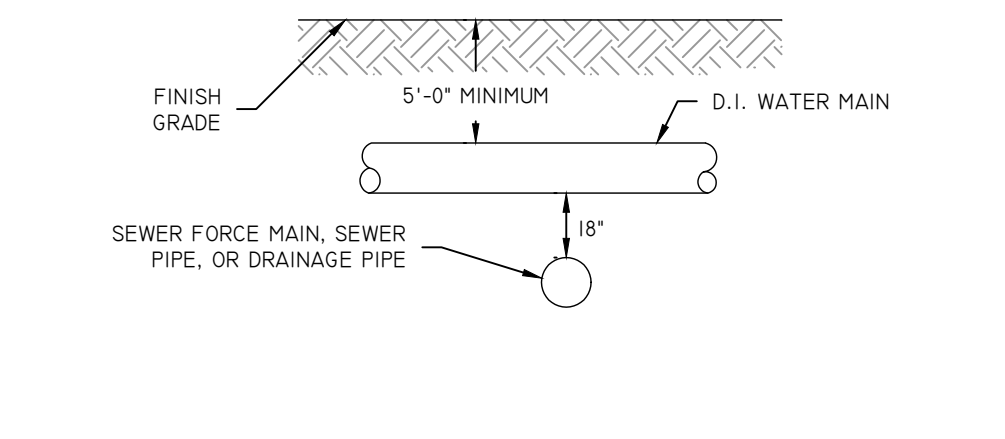


UTILITY SEPARATION
NOT TO SCALE

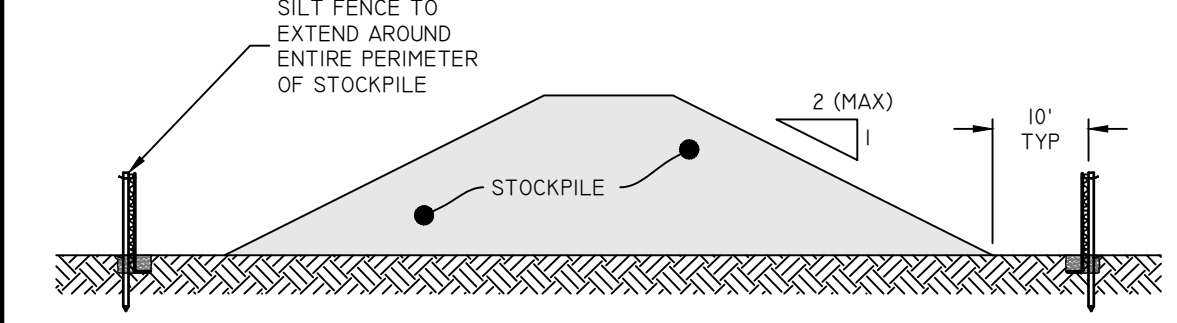

- NOTES:
1. ALL STOCKPILES MUST BE INSTALLED AND MAINTAINED IN ACCORDANCE WITH SECTION 3 "STOCKPILE AND STAGING AREA MANAGEMENT" OF THE RHODE ISLAND SOIL EROSION AND SEDIMENT CONTROL.
 2. DIVERT ALL STORMWATER AWAY FROM STOCKPILES.
 3. SOIL STOCKPILES THAT ARE NOT TO BE USED WITHIN 30 DAYS MUST BE SEEDED AND MULCHED IMMEDIATELY AFTER FORMATION OF THE STOCKPILE WITH SEED MIX COMPATIBLE WITH THE SOIL TYPE.
 4. STOCKPILE AND SILT FENCE MUST BE INSPECTED AT LEAST ONCE PER WEEK AND AFTER RAIN EVENTS IN EXCESS OF 1" OF RAINFALL. REPAIR/REPLACE SILT FENCE (AND STOCKPILE COVERS WHERE APPLICABLE) AS NEEDED TO KEEP THEM FUNCTIONING ADEQUATELY.
 5. SEDIMENT TRAPPED BY SILT FENCES MUST BE REMOVED AND PROPERLY DISPOSED OF WHENEVER SIGNIFICANT ACCUMULATION OCCURS.

STOCKPILE PROTECTION
NOT TO SCALE

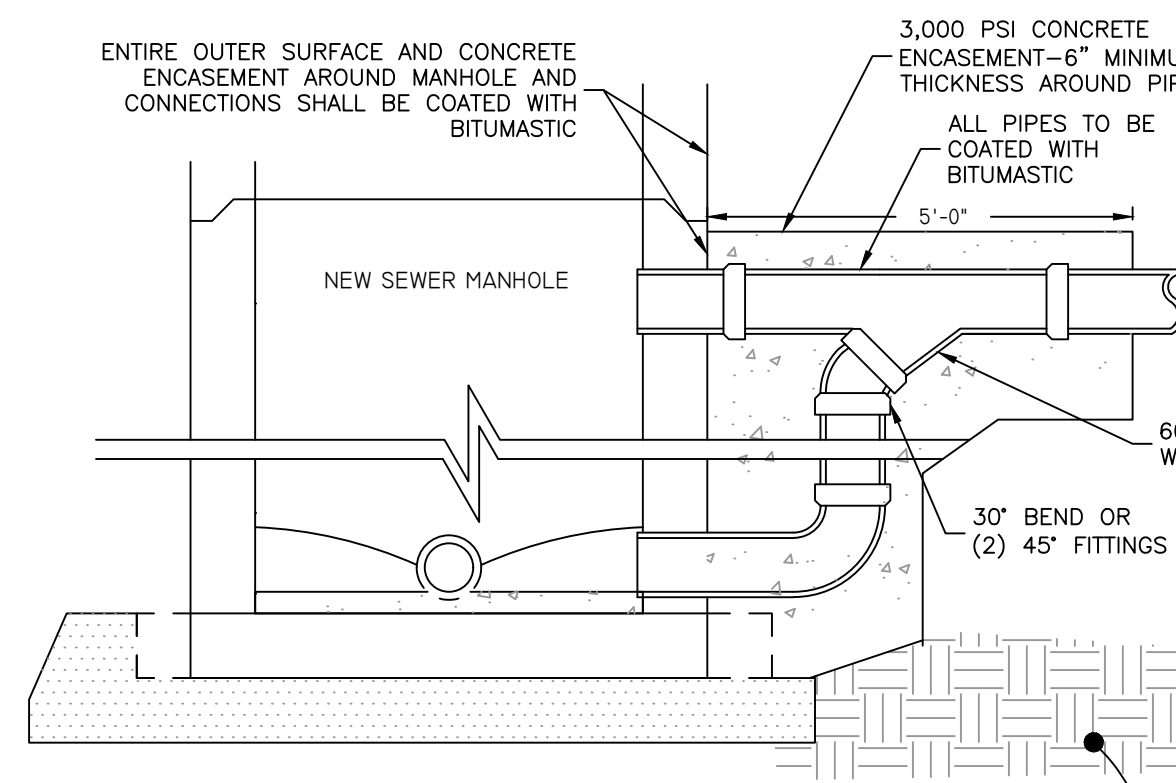

EXTERNAL DROP FOR MANHOLE
NOT TO SCALE

DETAIL SHEET - 2
POST ROAD APARTMENTS
ASSESSOR'S PLAT 323 LOT 523
WARWICK, RHODE ISLAND

BRANDON D. CARR
[Signature]
REGISTERED PROFESSIONAL ENGINEER
CIVIL

THIS PLAN SET MUST NOT BE USED FOR CONSTRUCTION PURPOSES UNLESS IT IS STAMPED AND SIGNED BY A REGISTERED PROFESSIONAL ENGINEER OF RHODE ISLAND.
DIPRETE ENGINEERING, INC., 175 WASHINGTON STREET, SUITE 400, WARWICK, RHODE ISLAND 02886
THE CONTRACTOR IS RESPONSIBLE FOR ALL OF THE MEASUREMENTS, METHODS, SAFETY PRECAUTIONS AND REQUIREMENTS AND OSHA DESIGN. IN THE REPRESENTATION OF THIS PLAN AND EXISTING UTILITIES SHOWN ON THIS PLAN ARE APPROXIMATE AND HAVE BEEN OBTAINED FROM RECORD PLANS AND FIELD SURVEYING. CONSULT WITH THE UTILITIES FOR EXACT UTILITIES. SEE UTILITY NOTE ON SHEET 3.

NO.	DATE	DESCRIPTION	BY:	CHK:
7	05-24-2024	PRELIMINARY SUBMISSION	J.A.R.	
6	05-20-2024	RESPONSE TO RFI COMMENTS	J.A.R.	
5	05-20-2024	REVISED SUBMISSION	J.A.R.	
4	05-20-2024	DESCRIPTION	J.A.R.	
3	05-20-2024	DESCRIPTION	J.A.R.	
2	05-20-2024	DESCRIPTION	J.A.R.	
1	05-20-2024	DESCRIPTION	J.A.R.	

PREPARED FOR:
SKYDRA DEVELOPMENT
868 WASHINGTON STREET, SUITE #305, DEDHAM, MA 02026
TEL 781-451-5600

DESIGN BY: F.V.A.
DRAWN BY: J.A.R.


PLANTING NOTES:

- CONTRACTOR TO VERIFY ALL UTILITY LOCATIONS BY NOTIFYING DIG-SAFE (811) AT LEAST 72 HOURS PRIOR TO ANY CONSTRUCTION OR SITE PREPARATION AND ANY/OR ALL LOCAL UTILITY COMPANIES AS REQUIRED.
- ALL WORK SHALL BE PERFORMED IN ACCORDANCE WITH ALL LOCAL, STATE AND FEDERAL REGULATIONS BY THE CONTRACTOR. CONTRACTOR SHALL OBTAIN ALL NECESSARY PERMITS FOR THIS PROJECT.
- CONTRACTOR TO PROVIDE A ONE (1) YEAR GUARANTEE FOR ALL MATERIALS. CONTRACTOR GUARANTEES THAT PLANTS WILL REMAIN HEALTHY FOR ONE (1) GROWING SEASON. CONTRACTOR TO MAINTAIN ALL PLANTING AND LAWNS UNTIL FINAL PROJECT ACCEPTANCE. GUARANTEE PERIOD TO COMMENCE AT FINAL ACCEPTANCE. ANY REPLACEMENT PLANTS SHALL BE OF THE SAME SIZE AND SPECIES AS SPECIFIED WITH NEW GUARANTEE COMMENCING ON THE DATE OF REPLACEMENT.
- ALL PLANT MATERIAL SHALL CONFORM, IN ALL RESPECTS, TO THE GUIDELINES OF "THE AMERICAN STANDARD FOR NURSERY STOCK,"

- LATEST EDITION, PUBLISHED BY THE AMERICAN NURSERY & LANDSCAPE ASSOCIATION, INC. ALL PLANTS SHALL BE NURSERY GROWN AND SHALL HAVE BEEN GROWN UNDER CLIMATIC CONDITIONS SIMILAR TO THOSE IN THE LOCALITY OF THE PROJECT FOR AT LEAST TWO (2) YEARS.
- PLANT SUBSTITUTION SELECTION MUST BE APPROVED BY LANDSCAPE ARCHITECT AND/OR OWNER PRIOR TO INSTALLATION.
 - ALL PLANTS TO BE PLANTED SO THAT AFTER SETTLEMENT THEY BEAR THE SAME RELATION TO THE SURROUNDING GROUND AS TO THEIR ORIGINAL GRADE BEFORE DIGGING.
 - CREATE SAUCER AROUND INDIVIDUAL PLANTS CAPABLE OF HOLDING WATER. ALL PLANTS TO BE FLOODED WITH CLEAN WATER TWICE WITHIN THE FIRST 24 HOURS OF PLANTING. ADDITIONAL WATERING SHALL BE MADE AS REQUIRED TO KEEP PLANTS FROM WILTING AND DRYING OUT UNTIL FINAL ACCEPTANCE.
 - ALL PLANTS TO RECEIVE A MINIMUM OF TWO (2) INCHES OF UNDEY, SHREDDED PINE BARK MULCH AND SHALL COVER PLANTING BEDS AS SHOWN ON DRAWINGS UNLESS OTHERWISE NOTED.

- TRIM BROKEN AND DEAD BRANCHES FROM TREES AND SHRUBS AFTER PLANTING. NEVER CUT A LEADER.
- MINIMUM BRANCHING HEIGHT FOR ALL SHADE TREES SHALL BE A MINIMUM OF SEVEN FEET ABOVE FINISHED GRADE TO MEET ADA STANDARDS.
- CONTRACTOR TO LOAM AND SEED ALL DISTURBED LANDSCAPE AREAS OUTSIDE OF THE PLANTING BEDS USING AN ENDOPHYTE ENHANCED MIX AT A RATE OF 5-7 LBS. PER 1,000 SF (AVAILABLE AT ALLENS SEED IN EXETER, RI) OR AS DIRECTED BY TOWN/OWNER UNLESS OTHERWISE NOTED. ANY SOG (TURF) UTILIZED SHALL BE DROUGHT TOLERANT ENDOPHYTES OR PREDOMINANTLY FESCUE IN CHARACTER.
- RECOMMENDED DATES FOR PLANTING ARE APRIL 15 TO JUNE 15 AND SEPTEMBER 15 TO NOVEMBER 15.
- ALL LANDSCAPED AREAS SHALL BE KEPT FREE OF WEEDS AND DEBRIS. ALL VEGETATION WITHIN SAID AREAS SHALL BE MAINTAINED FREE OF PHYSICAL DAMAGE CAUSED BY CHEMICALS, INSECTS, DISEASES, LACK OF WATER OR OTHER CAUSES. DAMAGED PLANTS SHALL BE REPLACED WITH THE SAME OR SIMILAR VEGETATION ON AN ANNUAL BASIS.



- LOAM MOVED ON SITE TO BE STOCKPILED AND RETAINED AND TO BE USED AS REQUIRED FOR THE LANDSCAPE DESIGN. LOAM SHALL NOT BE MIXED WITH ANY UNSUITABLE MATERIALS OR SUBSOIL. EXCESS LOAM TO REMAIN ON THE OWNER'S PROPERTY AND ONLY REMOVED WITH THE OWNERS PERMISSION. NEW LOAM SHALL BE FRIABLE, FERTILE, MEDIUM TEXTURED SANDY LOAM THAT IS FREE OF TOXIC MATERIALS FOR HEALTHY PLANT GROWTH AND SURVIVAL. LOAM SHALL BE FREE OF MATTER 1" OR GREATER IN DIAMETER AND WHEN TESTED SHALL HAVE A PH BETWEEN 5.5 AND 7.5. CONTRACTOR TO PROVIDE 8 INCHES OF GOOD QUALITY LOAM AND/OR REUSE EXISTING LOAM TO PROVIDE A MINIMUM 6 INCH DEPTH.
- IRRIGATION AND LIGHTING BY OTHERS.
- THIS PLAN IS FOR LANDSCAPE PLANTING ONLY.

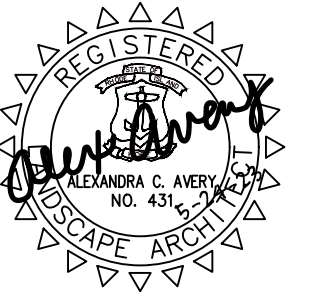

THIS PLAN SET MUST NOT BE USED FOR CONSTRUCTION PURPOSES UNLESS APPROVED BY THE REGISTERED PROFESSIONAL ENGINEER OF DIPRETE ENGINEERING. DIPRETE ENGINEERING ONLY, STATEMENT OF PLANS AND SEALS. DIPRETE ENGINEERING, 100 STATE STREET, SUITE 200, CRANSTON, RI 02920. THE CONTRACTOR IS RESPONSIBLE FOR ALL OF THE MEASUREMENTS, METHODS, SAFETY, PRECAUTIONS AND REQUIREMENTS, AND OSHA DESIGN. DAMAGE IN THE IMPLEMENTATION OF THIS PLAN AND EXISTING UTILITIES SHOWN ON THIS PLAN ARE APPROXIMATE. DAMAGE INCLUDING OCCURRENCE OF UTILITIES SHALL BE THE CONTRACTOR'S RESPONSIBILITY. SEE UTILITY NOTE ON SHEET 1.

NO.	DATE	DESCRIPTION	J.A.R.	J.A.R.	J.A.R.	J.A.R.	J.A.R.
7	05-24-2024	PRELIMINARY SUBMISSION	J.A.R.	J.A.R.	J.A.R.	J.A.R.	J.A.R.
6	05-20-2024	RESPONSE TO RFI COMMENTS	J.A.R.	J.A.R.	J.A.R.	J.A.R.	J.A.R.
5	05-20-2024	PERMIT SUBMISSION	J.A.R.	J.A.R.	J.A.R.	J.A.R.	J.A.R.
4	05-20-2024	DESIGN	J.A.R.	J.A.R.	J.A.R.	J.A.R.	J.A.R.
3	05-20-2024	DESIGN	J.A.R.	J.A.R.	J.A.R.	J.A.R.	J.A.R.
2	05-20-2024	DESIGN	J.A.R.	J.A.R.	J.A.R.	J.A.R.	J.A.R.
1	05-20-2024	DESIGN	J.A.R.	J.A.R.	J.A.R.	J.A.R.	J.A.R.

LANDSCAPE PLAN
POST ROAD APARTMENTS
 ASSESSOR'S PLAT 323 LOT 523
 WARWICK, RHODE ISLAND
 PREPARED FOR:
SKYDRA DEVELOPMENT
 858 WASHINGTON STREET, SUITE #305, DEEHAM, MA 02026
 TEL 781-451-5600
 DE JOB NO. 2424-148-01 COPYRIGHT 2024 BY DIPRETE ENGINEERING ASSOCIATES, INC.

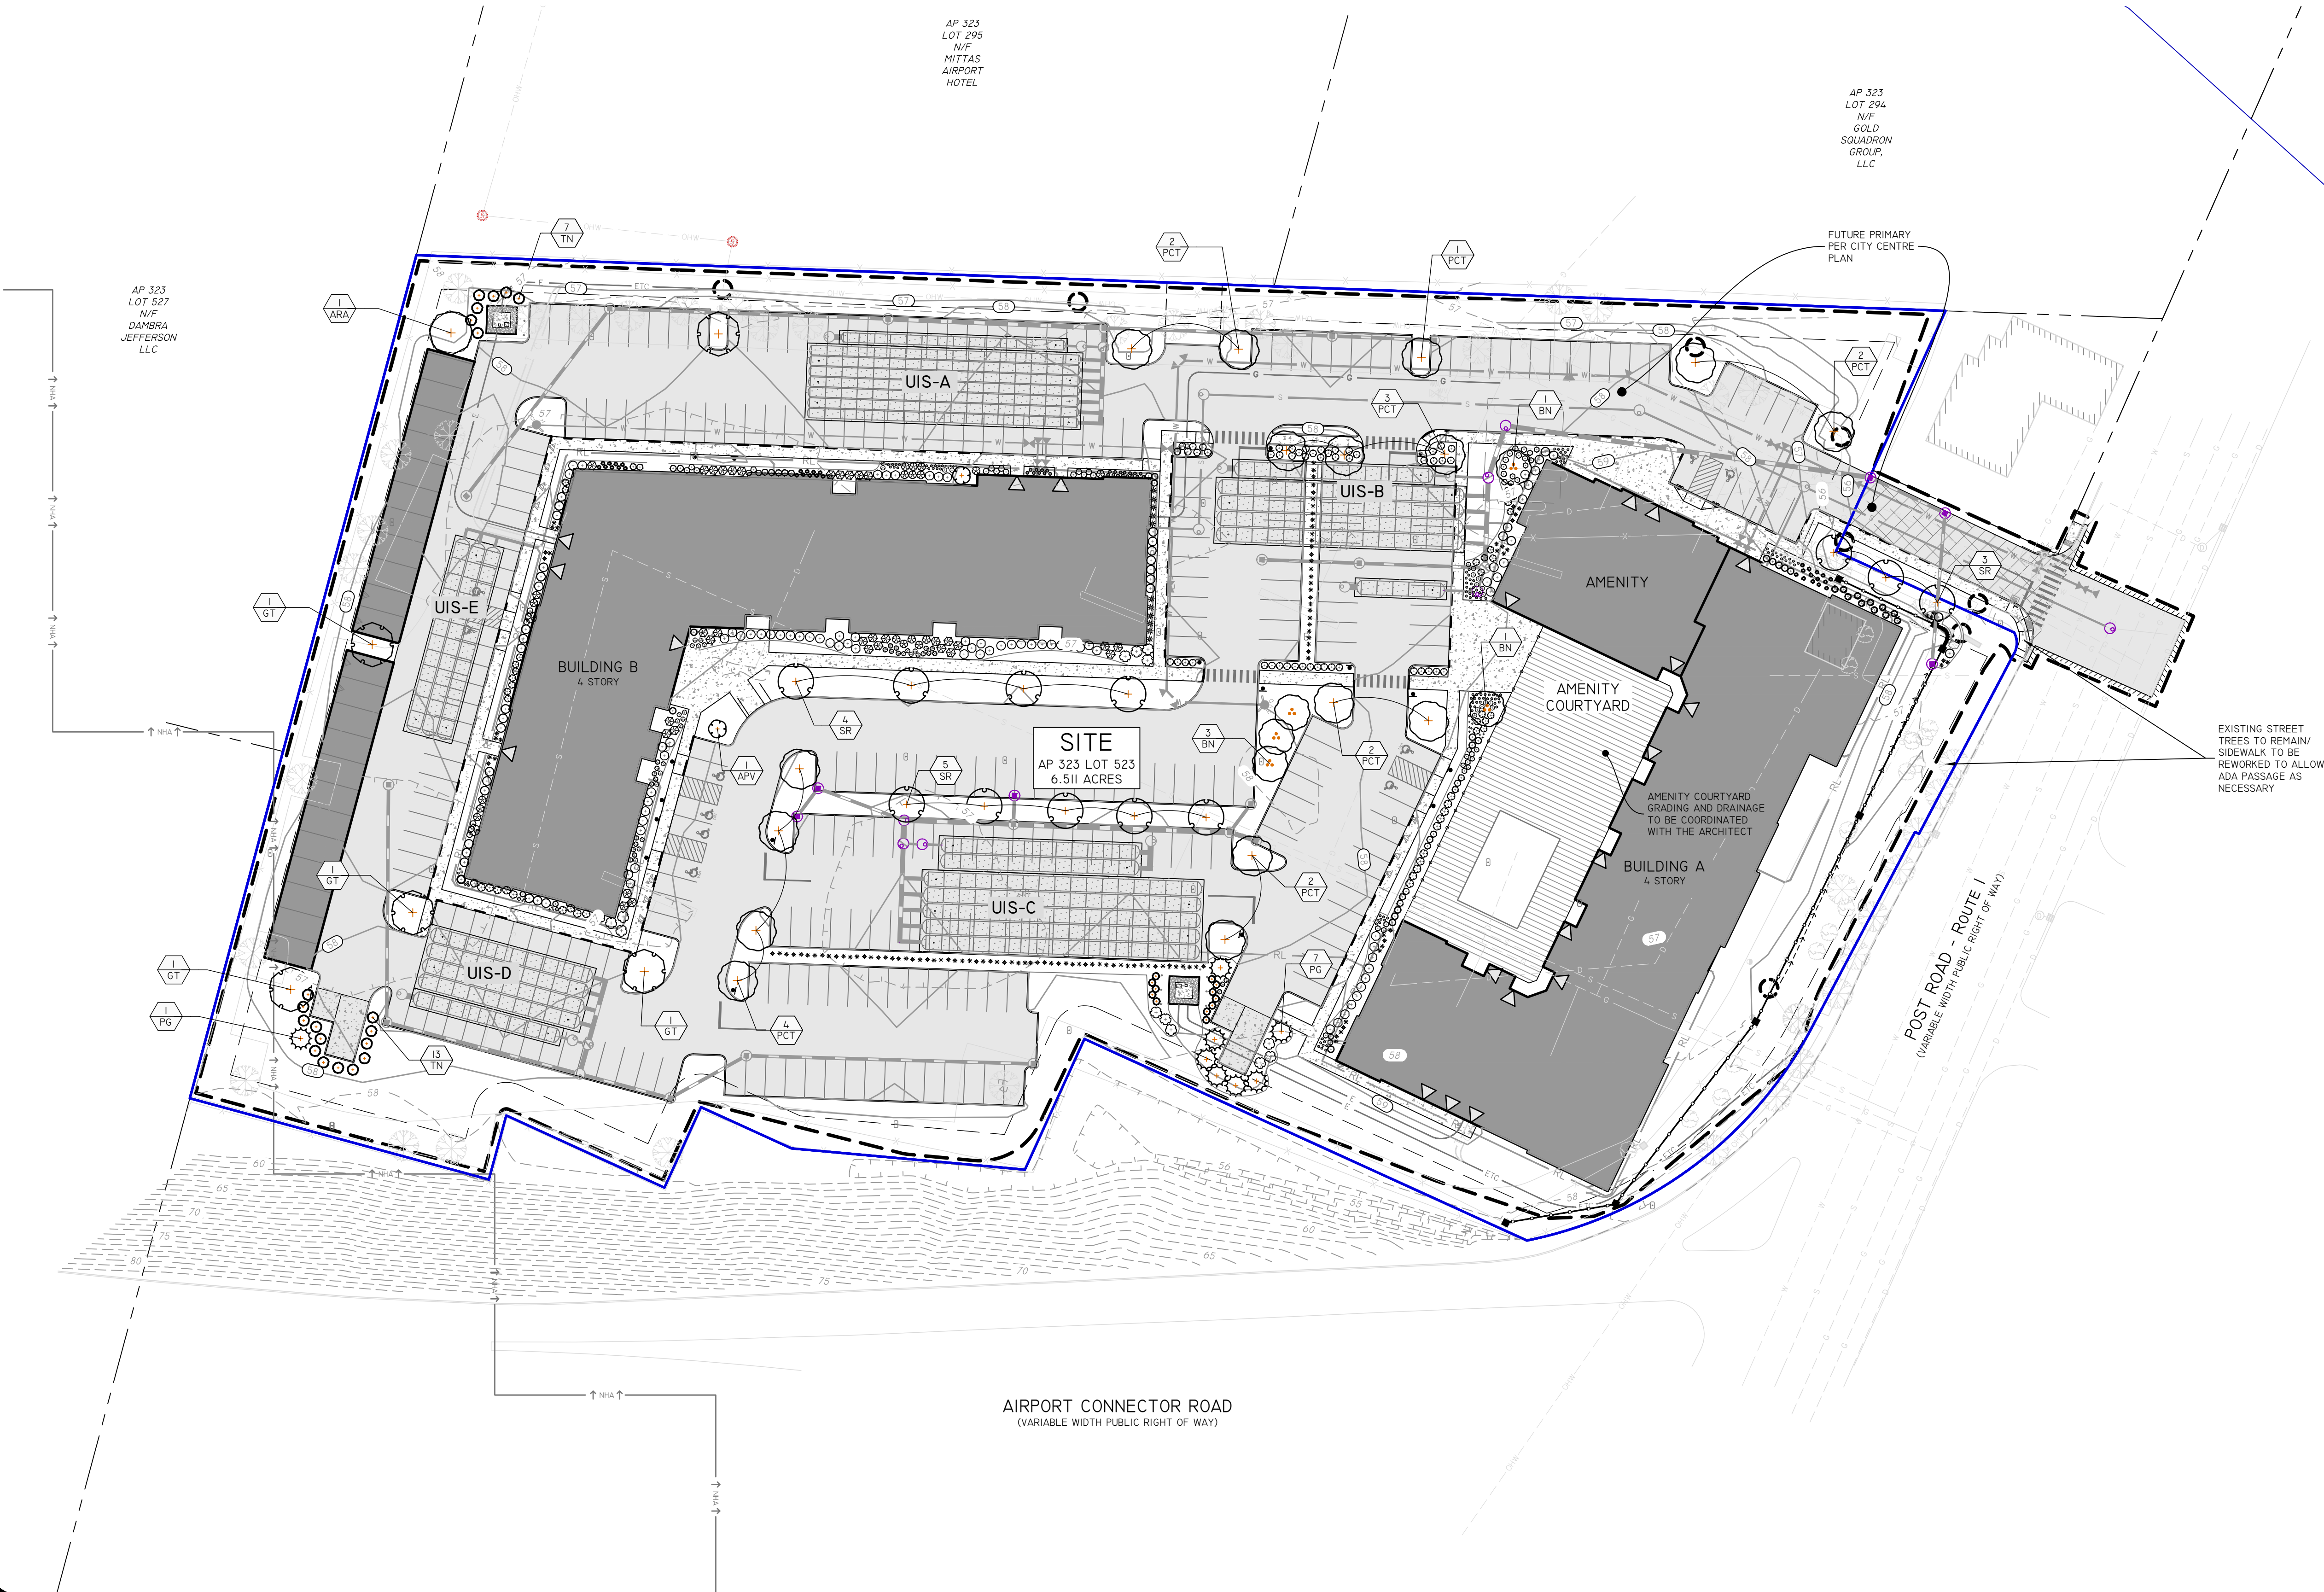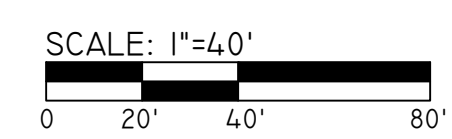

AP 323
LOT 527
N/F
DAMBRA
JEFFERSON
LLC

AP 323
LOT 295
N/F
MITTAS
AIRPORT
HOTEL


AP 323
LOT 294
N/F
GOLD
SQUADRON
GROUP,
LLC

AIRPORT CONNECTOR ROAD
(VARIABLE WIDTH PUBLIC RIGHT OF WAY)


POST ROAD - ROUTE 1
(VARIABLE WIDTH PUBLIC RIGHT OF WAY)

EXISTING STREET TREES TO REMAIN/
SIDEWALK TO BE REWORKED TO ALLOW
ADA PASSAGE AS NECESSARY


PLANT SCHEDULE						
TREES	CODE	QTY	BOTANICAL NAME	COMMON NAME	CONT	CAL
	APV	2	ACER PALMATUM DISSECTUM 'VIRIDIS'	VIRIDIS JAPANESE MAPLE	15 GAL	
	ARA	1	ACER RUBRUM 'ARMSTRONG'	ARMSTRONG RED MAPLE	B & B	4.5" CAL MIN
	BN	5	BETULA NIGRA	RIVER BIRCH MULTI-TRUNK	B & B	2.5" CAL MIN
	GT	5	GLEDTISIA TRIACANTHOS INERMIS 'HALKA'	HALKA HONEY LOCUST	B & B	3.5" CAL MIN
	PCT	16	PRUNUS CERASIFERA 'THUNDERCLOUD'	THUNDERCLOUD PURPLELEAF PLUM	B & B	2.5" CAL MIN
	SR	12	SYRINGA RETICULATA 'IVORY SILK'	IVORY SILK JAPANESE TREE LILAC	B & B	2.5" CAL MIN
EVERGREENS	CODE	QTY	BOTANICAL NAME	COMMON NAME	CONT	CAL
	PG	8	PICEA GLAUCA	WHITE SPRUCE	7/8' HT	
	TN	20	THUJA OCCIDENTALIS 'NIGRA'	BLACK ARBORVITAE	7/8' HT	
	TOS	12	THUJA OCCIDENTALIS 'SHARAGO'	EMERALD GREEN ARBORVITAE	6/7' HT	
SHRUBS	CODE	QTY	BOTANICAL NAME	COMMON NAME	SIZE	FIELD2
	CP	21	CHAMAECYPARIS PISIFERA 'GOLDEN MOP'	GOLDEN MOP THREADLEAF FALSE CYPRESS	24-30" HT	
	CSA	5	CORNUS SERICEA 'ARTIC FIRE'	ARTIC FIRE RED TWIG DOGWOOD	5 GAL	
	HSR	2	HIBISCUS SYRIACUS 'RED HEART'	RED HEART ROSE OF SHARON	4/5' HT STK	
	HA	36	HYDRANGEA ARBORESCENS 'INCREDIBALL'	INCREDIBALL WHITE HYDRANGEA	5 GAL	
	HM	22	HYDRANGEA MACROPHYLLA 'BAILMER' TM	ENDLESS SUMMER HYDRANGEA	3' HT MIN	
	IC	14	ILEX CRENATA 'HELLER'	HELER JAPANESE HOLLY	24" HT	
	ISP	2	ILEX CRENATA 'SKY PENCIL'	SKY PENCIL JAPANESE HOLLY	42-48" HT	
	IG	36	ILEX GLABRA 'SHAMROCK'	SHAMROCK INKERRY HOLLY	3' HT MIN	
	JPN	11	JUNIPERUS PROCUMBENS 'NANA'	SHORE JUNIPER	2 GAL	
	KL	13	KALMIA LATIFOLIA 'MINUET'	MINUET MOUNTAIN LAUREL	5 GAL	
	PP	1	PICEA PUNGENS GLAUCA 'R.H. MONTGOMERY'	BLUE SPRUCE	24-30" HT	
	PL	13	PRUNUS LAUROCERASUS 'OTTO LUYKEN'	OTTO LUYKEN ENGLISH LAUREL	5 GAL	
	RA	33	RHOODOENDRON X 'AGLO'	AGLO RHOODOENDRON	42-48" HT	
	RXC	39	RHOODOENDRON X CHIONOIDES	CHIONOIDES RHOODOENDRON	42-48" HT	
	RA	51	RHUS AROMATICA 'GRO-LOW'	GRO-LOW FRAGRANT SUMAC	18-24" HT	
	RKW	30	ROSA X 'RADWHITE' TM	WHITE KNOCK OUT ROSE	18-24" HT	
	SN	24	SPIRAEA X BUMALDA 'NEON FLASH'	NEON FLASH SPIREA	24" HT	
GRASSES	CODE	QTY	BOTANICAL NAME	COMMON NAME	SIZE	FIELD2
	CK	129	CALAMAGROSTIS X ACUTIFLORA 'KARL FOERSTER'	KARL FOERSTER FEATHER REED GRASS	2 GAL	
	FG	25	FESTUCA GLAUCA 'ELIJAH BLUE'	ELIJAH BLUE FESCUE	1 GAL	
	MC	24	MUHLENBERGIA CAPILLARIS	PINK MUHLY GRASS	1 GAL	
	PV	11	PANICUM VIRGATUM 'SHENANDOAH'	SHENANDOAH SWITCH GRASS	2 GAL	
	PA	32	PENNISETUM ALOPECUROIDES 'HAMELN'	HAMELN FOUNTAIN GRASS	2 GAL	
PERENNIALS	CODE	QTY	BOTANICAL NAME	COMMON NAME	SIZE	FIELD2
	HH	80	HEMEROCALLIS X 'HAPPY RETURNS'	HAPPY RETURNS DAYLILY	1 GAL	
	HS	35	HEMEROCALLIS X 'STELLA DE ORO'	STELLA DE ORO DAYLILY	1 GAL	
	HP	21	HEUCHERA X 'PLUM PUDDING'	PLUM PUDDING CORAL BELLS	1 GAL	
	LM	23	LEUCANTHEMUM MAXIMUM	MAX CHRYSANTHEMUM	1 GAL	
	NF	16	NEPETA X FAASSENII 'BLUE WONDER'	BLUE WONDER CATMINT	1 GAL	
	PAB	17	PEROVSKIA ATRIPLICIFOLIA 'BLUE JEAN BABY'	BLUE JEAN BABY RUSSIAN SAGE	2 GAL	
	RF	6	RUBEBECKIA FULGIDA SULLIVANTII 'GOLDSTURM'	GOLDSTURM CONEFLOWER	1 GAL	
	SSB	2	SEDUM SPECTABILE 'BRILLIANT'	BRILLIANT STONECROP	1 GAL	

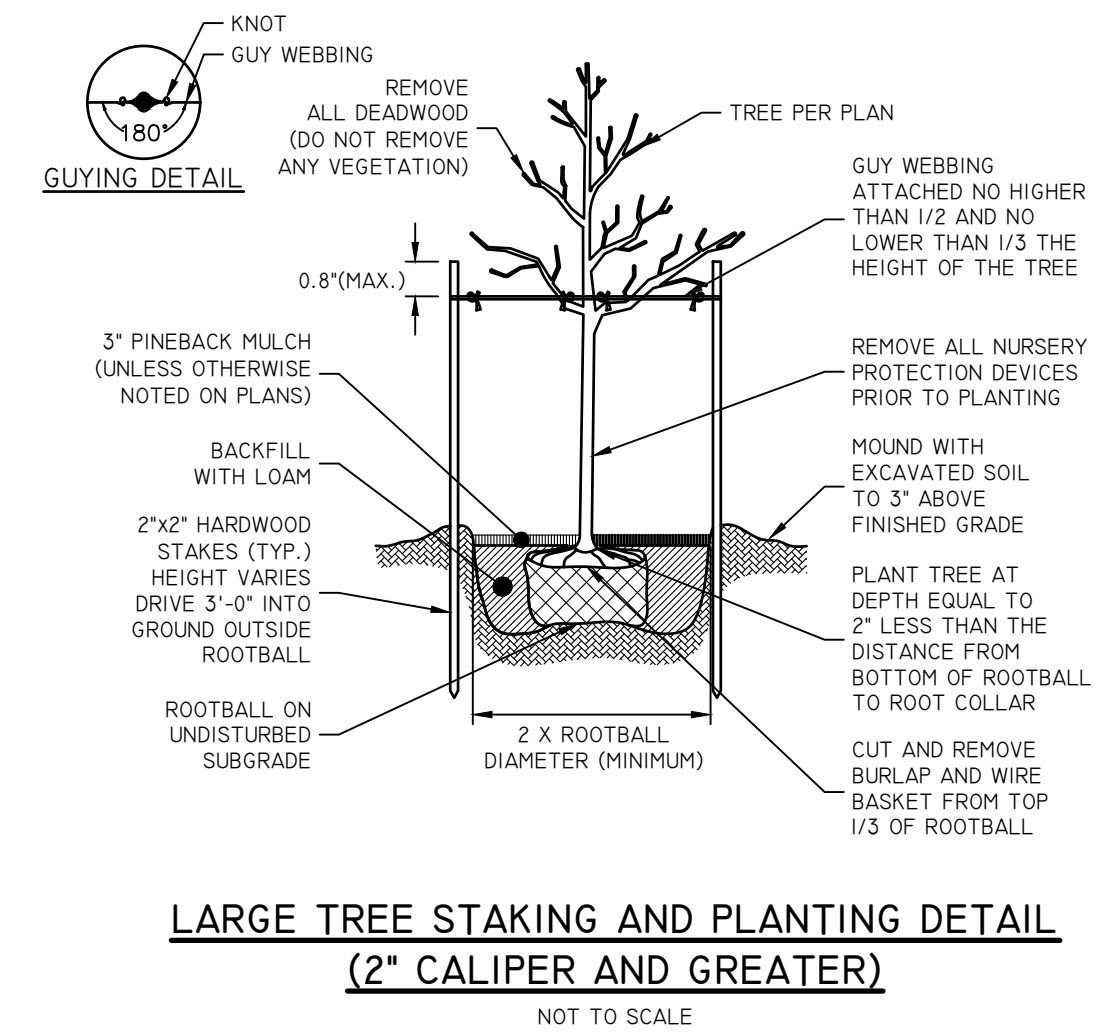


LARGE TREE STAKING AND PLANTING DETAIL
(2" CALIPER AND GREATER)
NOT TO SCALE

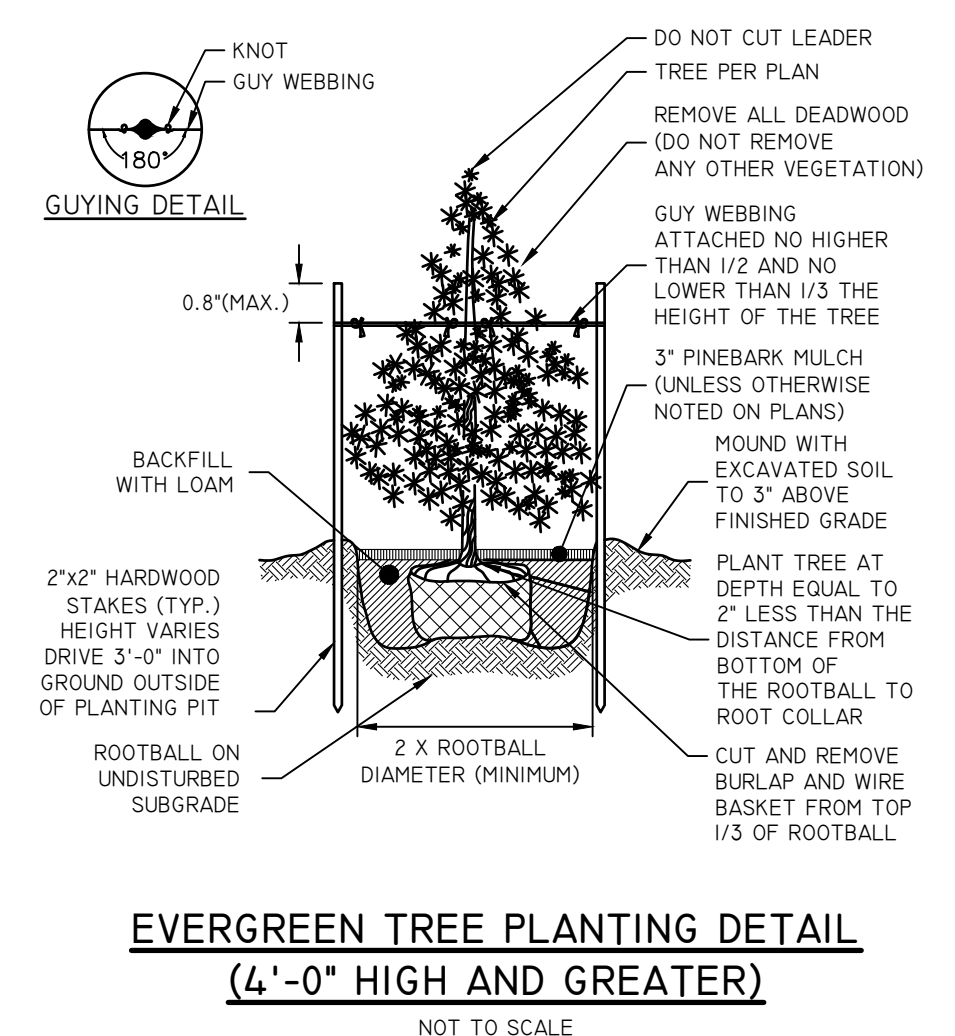


EVERGREEN TREE PLANTING DETAIL
(4" HIGH AND GREATER)
NOT TO SCALE

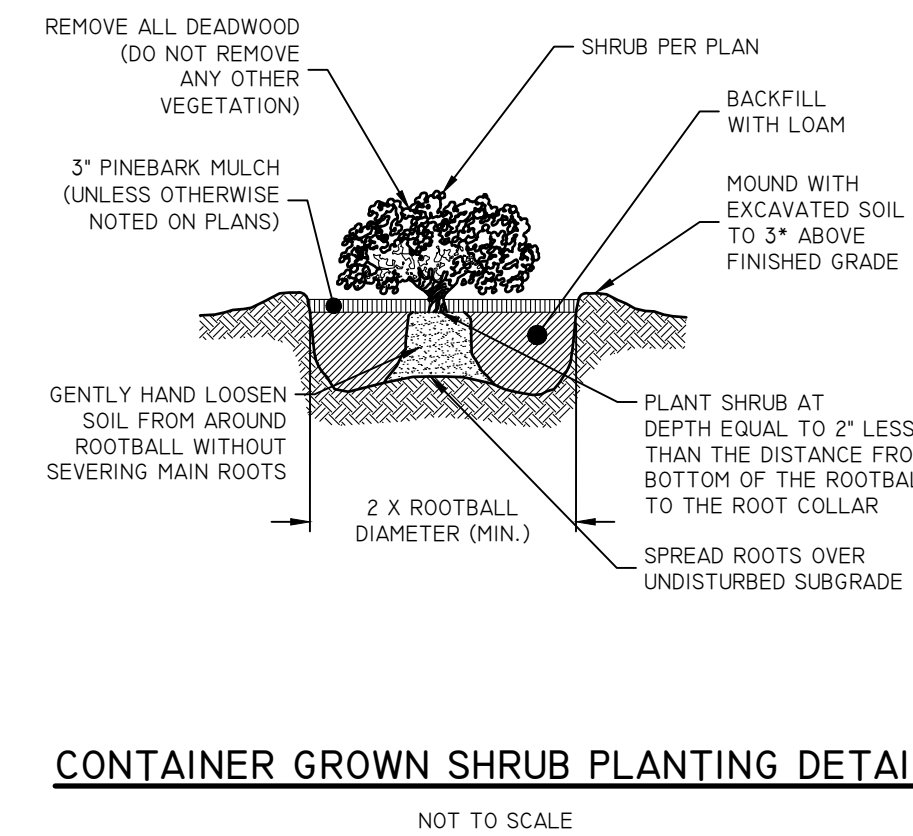


CONTAINER GROWN SHRUB PLANTING DETAIL
NOT TO SCALE

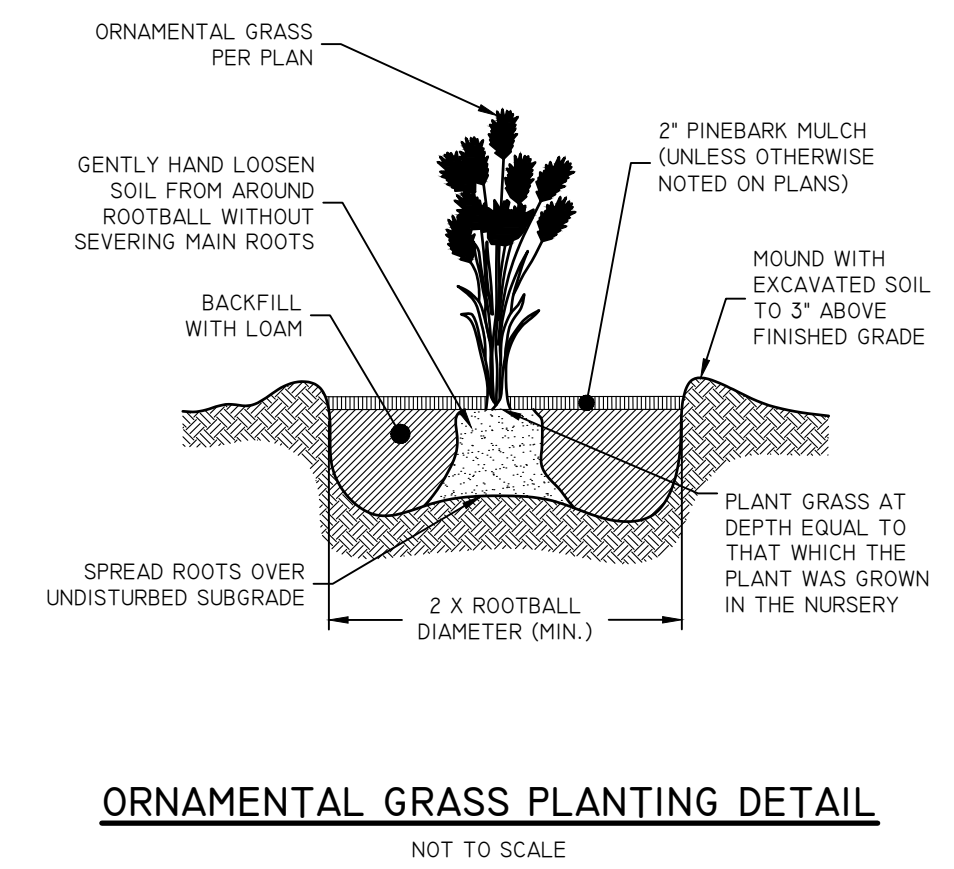

ORNAMENTAL GRASS PLANTING DETAIL
NOT TO SCALE

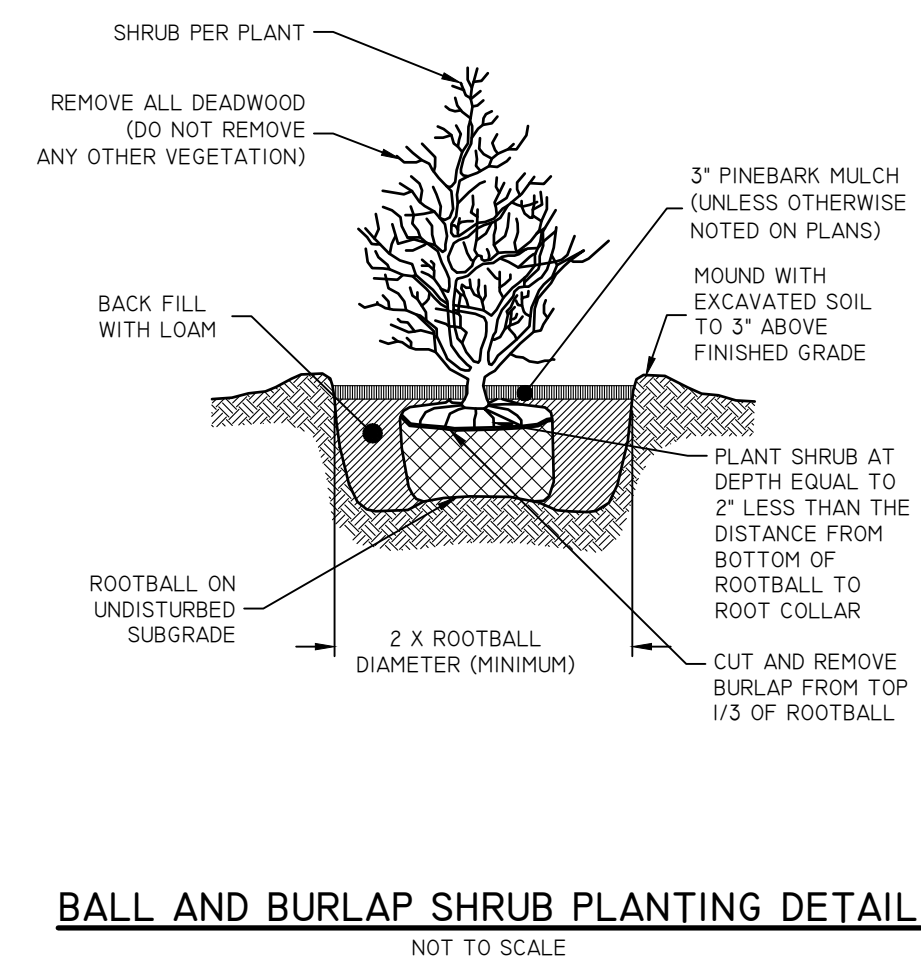

BALL AND BURLAP SHRUB PLANTING DETAIL
NOT TO SCALE

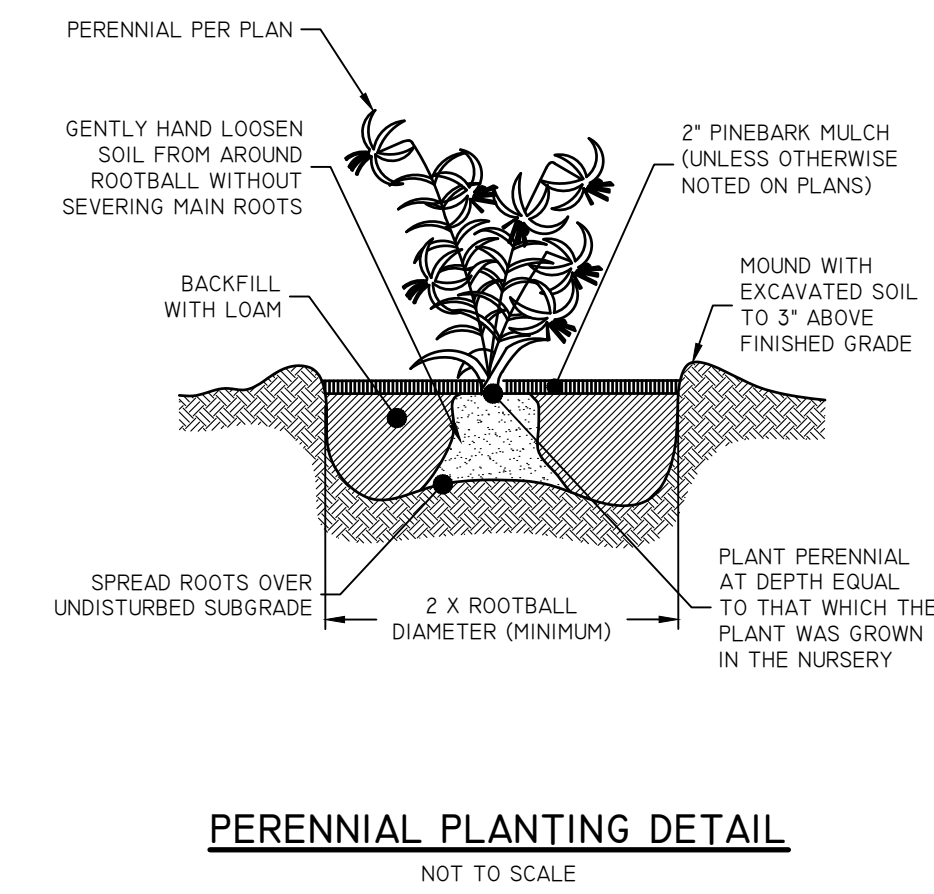

PERENNIAL PLANTING DETAIL
NOT TO SCALE