
MAJOR LAND DEVELOPMENT PRELIMINARY/ FINAL SUBMISSION

SITE PLANS

FOR

HILLSGROVE AT CITY CENTRE

A.P. 278, LOT 144
298 KILVERT STREET
WARWICK, RHODE ISLAND 02886

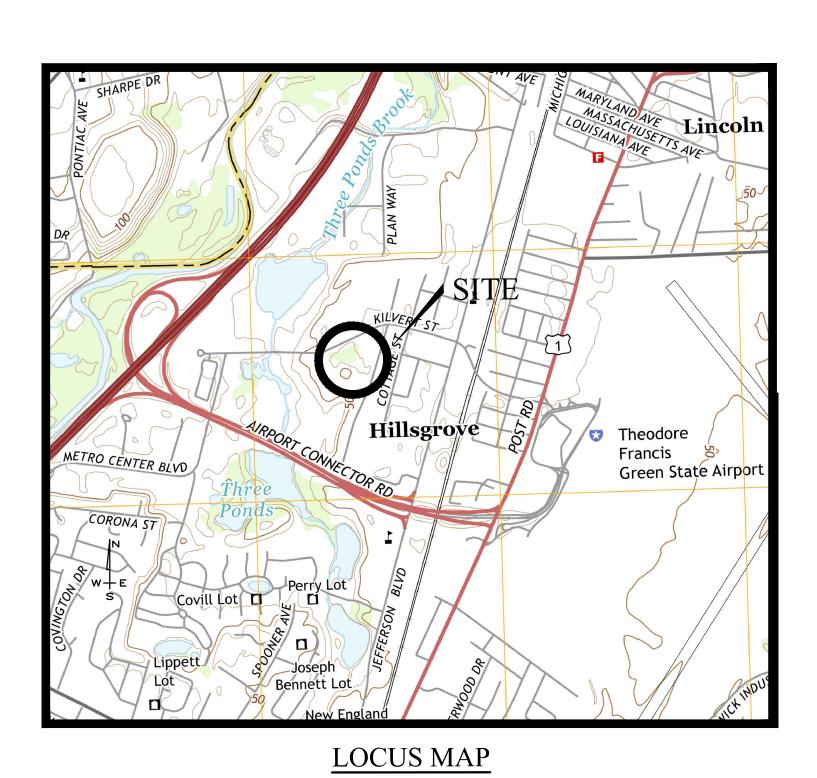

NOT TO SCALE


OWNER / APPLICANT:
GREAT POINT GROUP, LLC
164 CENTERVILLE ROAD
WARWICK, RHODE ISLAND 02886


PREPARED BY:



GAROFALO & ASSOCIATES, INC.
CIVIL & STRUCTURAL ENGINEERS\SURVEYORS
LAND PLANNERS\ENVIRONMENTAL SCIENTISTS
P.O. BOX 6145 PROVIDENCE, R.I. 02940
1-401-273-6000

JOB NO. 7272-00 DATE: JANUARY 26, 2019 (REVISED: JULY 6, 2021)

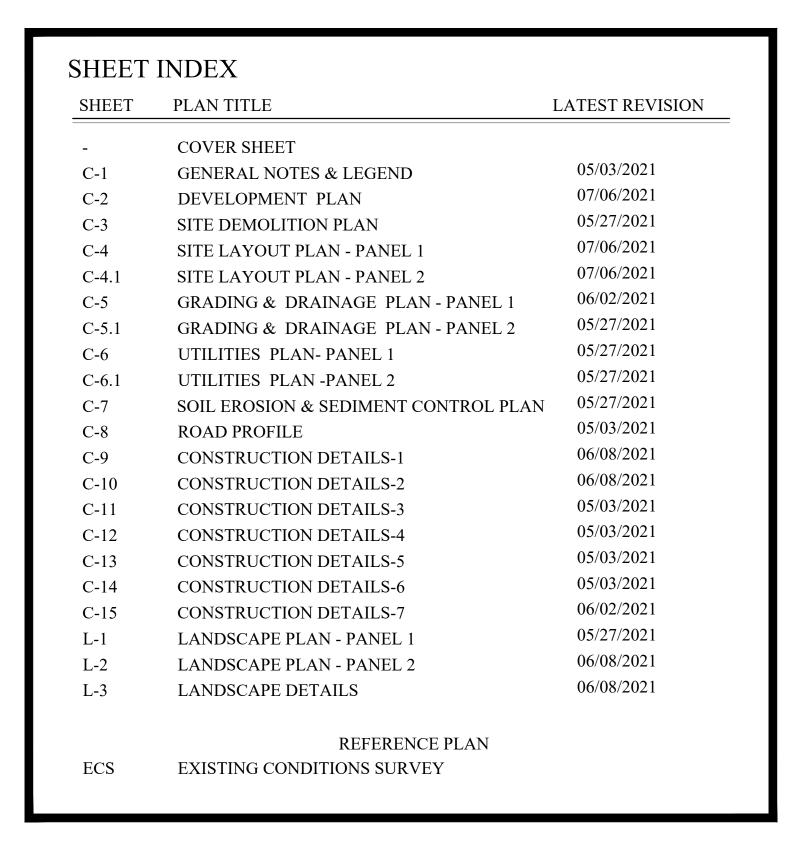

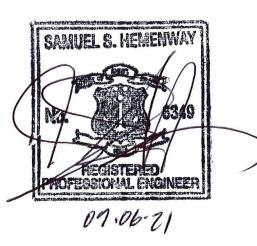

- 3. SITEWORK CONSTRUCTION SHALL NOT COMMENCE UNTIL ALL APPROVALS HAVE BEEN SECURED. REQUIRED PERMITS/APPROVALS FOR THE PROJECT INCLUDE BUT NOT LIMITED TO THE FOLLOWING: WARWICK MAJOR LAND DEVELOPMENT APPROVAL, RIDOT PHYSICAL ALTERNATION PERMIT, RIDEM STORMWATER CONSTRUCTION PERMIT AND WATER QUALITY CERTIFICATION, WARWICK WATER DEPARTMENT CONNECTION PERMIT & WARWICK SEWER AUTHORITY (WSA) CONNECTION PERMIT.
- 4. ALL IMPROVEMENTS INDICATED HEREON MUST COMPLY WITH THE 'AMERICANS WITH DISABILITIES ACT ACCESSIBILITY GUILDELINES (ADAAG)'. NOTE THAT THE DETAIL CONTAINED WITHIN THIS PLAN MAY NOT SHOW THE DETAIL NECESSARY TO CONSTRUCT WALKWAYS, RAMPS AND SPACES TO COMPLY WITH THE ADAAG REQUIREMENTS BUT THE CONTRACTOR IS RESPONSIBLE TO PROVIDE THE LEVEL OF CARE NECESSARY TO BE CERTAIN THAT THE CONSTRUCTED PRODUCT MEETS THESE STANDARDS.
- 5. THE CONTRACTOR MUST RETAIN THE SERVICES OF A REGISTERED LAND SURVEYOR IN THE STATE OF RHODE ISLAND TO LAYOUT ON THE GROUND ALL NEW ELEMENTS OF WORK. IF ANY WORK IS INSTALLED PRIOR TO THE ABOVE REQUIREMENT AND IF ANY WORK IS NOT SATISFACTORY TO THE ENGINEER, THE CONTRACTOR MUST REPLACE THE WORK AT NO ADDITIONAL COST TO THE OWNER.
- 6. THE CONTRACTOR SHALL VERIFY THE PROPOSED LAYOUT WITH ITS RELATIONSHIP TO THE EXISTING SITE SURVEY. THE CONTRACTOR SHALL VERIFY ALL DIMENSIONS, SITE CONDITIONS AND MATERIAL SPECIFICATIONS AND SHALL NOTIFY THE OWNER AND ENGINEER OF ANY ERRORS, OMISSIONS OR DISCREPANCIES BEFORE COMMENCING, INSTALLING OR PROCEEDING WITH WORK.
- 7. IT IS THE RESPONSIBILITY OF THE CONTRACTOR TO DETERMINE THE LOCATION OF ALL EXISTING UNDERGROUND UTILITIES AND TO TAKE WHATEVER NECESSARY MEASURES NEEDED TO PROVIDE FOR THEIR PROTECTION. THE ENGINEER HAS DILIGENTLY ATTEMPTED TO LOCATE AND INDICATE ALL EXISTING UNDERGROUND UTILITIES AND FACILITIES ON THE DRAWINGS; HOWEVER, THE INFORMATION SHOWN IS FOR THE CONTRACTORS CONVENIENCE ONLY. THE ENGINEER ASSUMES NO RESPONSIBILITY FOR THE LOCATIONS OF UTILITIES SHOWN OR NOT SHOWN. THE CONTRACTOR SHALL MAKE EXPLORATORY EXCAVATIONS AND LOCATE ANY EXISTING UTILITIES SUFFICIENTLY AHEAD OF CONSTRUCTION, VERIFY ALL DIMENSIONS, SITE CONDITIONS AND MATERIALS. THE CONTRACTOR MUST CONTACT THE LOCAL UTILITY COMPANIES FOR EXACT LOCATION OF UTILITIES PRIOR TO THE START OF ANY CONSTRUCTION AND SHALL NOTIFY THE ENGINEER OF ANY DISCREPANCIES BEFORE START OF ANY WORK. IT IS THE SOLE RESPONSIBILITY OF THE CONTRACTOR TO REPAIR AND REPLACE ANY AND ALL DAMAGE MADE TO UTILITIES BY THE CONTRACTOR.
- 8. THE CONTRACTOR MUST NOTIFY OPERATORS WHO MAINTAIN UNDERGROUND UTILITIES IN THE AREA OF PROPOSED CONSTRUCTION, EXCAVATION OR BLASTING AT LEAST THREE WORKING DAYS, BUT NOT MORE THAN TEN WORKING DAYS PRIOR TO THE START OF ANY CONSTRUCTION, EXCAVATION OR BLASTING. ALL WATER, SEWER, GAS AND ALL OTHER UTILITIES MUST BE MAINTAINED AT ALL TIMES DURING CONSTRUCTION.
- 9. METHODS AND MATERIALS USED IN THE CONSTRUCTION OF IMPROVEMENTS SHALL CONFORM TO THE CURRENT CONSTRUCTION STANDARDS AND SPECIFICATIONS FOR THE CITY OF WARWICK AND THE STATE OF RHODE ISLAND DEPARTMENT OF TRANSPORTATION. THE STATE OF RHODE ISLAND STANDARD SPECIFICATIONS FOR ROAD AND BRIDGE CONSTRUCTION, 2004 EDITION, AS AMENDED, AND THE RHODE ISLAND STANDARD DETAILS ARE MADE A PART HEREOF, AS IF ATTACHED HERETO.
- 10. THE CONTRACTOR IS RESPONSIBLE FOR REPLACING ANY PAVEMENT, DRIVEWAYS, SIDEWALKS, WALL, CURBS, ETC. DAMAGED DURING CONSTRUCTION WITH MATCHING MATERIALS.
- 11. THE CONTRACTOR AGREES THAT HE WILL ASSUME SOLE AND COMPLETE RESPONSIBILITY FOR THE PROJECT SITE CONDITIONS THROUGHOUT CONSTRUCTION. INCLUDING SAFETY OF ALL PERSONS AND PROPERTY. THIS REQUIREMENT WILL APPLY CONTINUOUSLY AND NOT BE LIMITED TO NORMAL WORKING HOURS AND THAT THE CONTRACTOR SHALL DEFEND, INDEMNIFY AND HOLD THE OWNER AND THE ENGINEER HARMLESS FROM ANY AND ALL LIABILITY, REAL OR ALLEGED IN CONJUNCTION WITH THE PERFORMANCE OF WORK ON THIS
- 12. ALL MATERIALS USED FOR CONSTRUCTION MUST BE NEW AND FREE OF DEFECTS. USED OR SALVAGED MATERIAL WILL NOT BE ALLOWED UNLESS WRITTEN APPROVAL FROM THE OWNER IS OBTAINED BY THE CONTRACTOR.
- 13. AT ALL TIMES THE CONTRACTOR MUST MAINTAIN ACCESS FOR EMERGENCY VEHICLES AROUND AND TO ALL BUILDINGS. (I.E. IN TIMES OF RAIN OR SNOW, ROADS MUST ABLE TO CARRY A FIRE TRUCK BY BEING PAVED OR HAVING A CRUSHED STONE BASE, ETC.). WDTH OF EMERGENCY VEHICLE ACCESS MUST BE A MINIMUM OF 20 FEET WIDE. ACCESS TO BUILDINGS THAT HAVE A FIRE SPRINKLER SYSTEM OR STANDPIPE MUST BE WITHIN 40 FEET OF THE FIRE DEPARTMENT CONNECTION (FDC). NFPA 1141 3-1.
- 14. NECESSARY BARRICADES, LIGHTS, SIGNS AND OTHER TRAFFIC CONTROL METHODS AS MAYBE NECESSARY FOR THE PROTECTION AND SAFETY OF THE PUBLIC MUST BE PROVIDED AND MAINTAINED THROUGHOUT CONSTRUCTION BY THE CONTRACTOR.
- 15. ALL RI HIGHWAY BOUNDS AND PERMANENT SURVEY MARKERS SHALL BE PROTECTED THROUGHOUT CONSTRUCTION.
- 16. ALL TRAFFIC CONTROL SHALL CONFORM TO THE MANUAL ON UNIFORM TRAFFIC CONTROL DEVICES 2009 INCLUDING ALL REVISIONS.
- 17. REFER TO ARCHITECTURAL, STRUCTURAL, AND MECHANICAL PLANS FOR ALL BUILDING INFORMATION.
- 18. ALL CURB RADII ARE 5' UNLESS OTHERWISE NOTED ON THE SITE PLAN.
- 19. PRIOR TO THE START OF CONSTRUCTION THE CONTRACTOR IS REQUIRED TO DEVELOP AND IMPLEMENT A PLAN FOR THE TEMPORARY CONTROL OF VEHICULAR AND PEDESTRIAN TRAFFIC FOR WORK WITHIN PUBLIC STREET RIGHT-OF-WAY AT THE SITE EGRESS. CONTRACTOR SHALL OBTAIN APPROVAL OF SAID PLAN FROM APPROPRIATE STATE AND COMMUNITY PUBLIC SAFETY OFFICIALS.
- 20. WHEN IT IS NECESSARY TO CLOSE OFF A STREET, THE FIRE DEPARTMENT AND POLICE DEPARTMENT SHALL BE NOTIFIED BY THE CONTRACTOR.
- 21. PRECAST STRUCTURES MAY BE USED AT CONTRACTOR'S OPTION. SHOP DRAWINGS OF PRECAST STRUCTURES SHALL BE REVIEWED BY THE ENGINEER AND APPROVED BEFORE USE.
- 22. IF ANY EXISTING STRUCTURES AND/OR UTILITIES TO REMAIN ARE DAMAGED DURING CONSTRUCTION, EITHER ON THE PROJECT SITE, ADJACENT PROPERTIES, OR WITHIN STATE RIGHT-OF-WAY, IT SHALL BE THE CONTRACTORS RESPONSIBILITY TO REPAIR AND/OR REPLACE THE EXISTING STRUCTURE AS NECESSARY TO RETURN IT TO EXISTING CONDITIONS OR BETTER.

SURVEY REFERENCE

- 1. THE EXISTING CONDITIONS SHOW HEREIN ARE TAKEN FROM PLAN TITLE "PROPERTY / EXISTING CONDITIONS & TOPOGRAPHY" SITUATED ON 293-304 KILVERT STREET WARWICK, RI PREPARED FOR CENTERVILLE BUILDERS. PREPARED BY GAROFALO & ASSOCIATES INC. JOB NUMBER: 7272-00, DWG: 7272-ECS. DATED MARCH 5, 2021.
- THE PROJECT SITE IS LOCATED WITHIN ZONE "X" (AREA OF MINIMAL FLOODING) AS SHOWN ON F.E.M.A. FLOOD INSURANCE RATE MAP FOR THE CITY OF WARWICK, RHODE ISLAND, KENT COUNTY, COMMUNITY PANEL NO. 44003C0127H, HAVING AN EFFECTIVE DATE OF OCT 2, 2015.
- 3. THE UNDERGROUND UTILITIES SHOWN HAVE BEEN LOCATED FROM FIELD SURVEY INFORMATION AND EXISTING DRAWINGS. THE SURVEYOR MAKES NO GUARANTEE THAT THE UNDERGROUND UTILITIES SHOWN COMPRISE ALL SUCH UTILITIES IN THE AREA, EITHER IN SERVICE OR ABANDONED. THE SURVEYOR FURTHER DOES NOT WARRANT THAT THE UNDERGROUND UTILITIES SHOWN ARE IN THE EXACT LOCATION INDICATED ALTHOUGH HE DOES CERTIFY THAT THEY ARE LOCATED AS ACCURATELY AS POSSIBLE FROM INFORMATION AVAILABLE. THE SURVEYOR HAS NOT PHYSICALLY LOCATED THE UNDERGROUND UTILITIES. (PLEASE CONTACT DIGSAFE PRIOR TO CONSTRUCTION © 1-888-344-7233)

GENERAL UTILITY NOTES:

- THE CONTRACTOR SHALL NOTIFY DIG-SAFE (1-888-344-7233) AND ALL LOCAL AUTHORITIES & UTILITY COMPANIES TO VERIFY LOCATIONS OF UTILITIES WITHIN THE AREA 72 HOURS PRIOR TO BEGINNING ANY EXCAVATION OR DEMOLITION FOR THE PURPOSE OF COORDINATING THE MARKING OF UNDERGROUND UTILITIES. LOCATION AND DEPTHS OF EXISTING UTILITIES SHOWN ARE APPROXIMATE ONLY. THE CONTRACTOR SHALL BE RESPONSIBLE TO VERIFY, LOCATE AND PROTECT EXISTING UTILITIES IN THE FIELD WHETHER OR NOT SHOWN ON THE DRAWINGS.
- 2. ALL WORK SHALL BE IN COMPLETE ACCORDANCE WITH ALL APPLICABLE STATE, FEDERAL AND LOCAL CODES, AND ALL NECESSARY LICENSES AND PERMITS SHALL BE OBTAINED BY THE CONTRACTOR AT HIS EXPENSE UNLESS PREVIOUSLY OBTAINED BY THE OWNER/DEVELOPER. THE CONTRACTOR SHALL REFER TO THE WARWICK WATER DEPARTMENT RULES & REGULATIONS FOR THE SERVICE INSTALLATION & EXTENSION REQUIREMENTS OF WATER LINES.
- 3. THE CONTRACTOR SHALL COORDINATE LOCATION AND INSTALLATION OF ALL UNDERGROUND UTILITIES AND APPURTENANCES TO MINIMIZE DISTURBANCE OF CURBING, PAVING AND COMPACTED SUBGRADE, THE CONTRACTOR SHALL NOTIFY THE TOWN ENGINEER & ALL LOCAL UTILITY COMPANIES 48 HOURS BEFORE EACH PHASE OF CONSTRUCTION. THE CONTRACTOR SHALL IMMEDIATELY INFORM THE ENGINEER OF ANY DISCREPANCIES OR ERRORS DISCOVERED IN THE PLANS.
- 4. BEDDING REQUIREMENTS SPECIFIED HEREIN ARE TO BE CONSIDERED AS MINIMUMS FOR RELATIVELY DRY, STABLE EARTH CONDITIONS. ADDITIONAL BEDDING SHALL BE REQUIRED FOR ROCK TRENCHES AND WET AREA. CONTRACTOR SHALL HAVE THE RESPONSIBILITY TO PROVIDE SUCH ADDITIONAL BEDDING AS MAY BE REQUIRED TO PROPERLY CONSTRUCT THE WORK.
- 5. THE CONTRACTOR SHALL REMOVE ANY ABANDONED FOUNDATIONS, UTILITY STRUCTURES, BURIED DEBRIS ETC. WHICH INTERFERE WITH THE INSTALLATION OF THE UTILITY WORK. ALL SUCH STRUCTURES SHALL BE COMPLETELY REMOVED AND THE EXCAVATED AREA SHALL BE BACKFILLED WITH COMPACTED GRAVEL IN 6" LIFTS TO 95% COMPACTION TO 6" BELOW THE BOTTOM OF THE UTILITY AND PIPE.
- 6. COMPACTION OF THE BACKFILL OF ALL TRENCHES SHALL BE COMPACTED TO THE DENSITY OF 95% OF THE THEORETICAL MAXIMUM DRY DENSITY (ASTM D698). BACKFILL MATERIAL SHALL BE FREE FROM ROOTS, STUMPS OR OTHER FOREIGN DEBRIS AND SHALL BE PLACED IN LIFTS NOT TO EXCEED ONE FOOT IN COMPACTED FILL THICKNESS. CORRECTION OF ANY TRENCH SETTLEMENT WITHIN A YEAR FROM THE DATE OF PROJECT APPROVAL WILL BE THE RESPONSIBILITY OF THE CONTRACTOR.
- 7. ALL PIPING LAYOUT INDICATED ON THESE PLANS IS DIAGRAMMATIC ONLY AND DOES NOT SHOW ALL THE REQUIRED FITTINGS FOR PROPER ALIGNMENT. THE CONTRACTOR SHALL PROVIDE ALL REQUIRED FITTINGS TO OBTAIN PROPER ALIGNMENT AND FOR EXISTING UTILITY CONNECTIONS BASED UPON FIELD CONDITIONS.
- 8. IF DURING EXCAVATION THE TRENCH WIDTH EXCEEDS THE SUM OF THE PIPE O.D. PLUS 2'-0", PLACE AND COMPACT THE FILL TO 12" ABOVE THE PIPE AND RE-EXCAVATE TO REQUIRED GRADE.
- 9. DOMESTIC AND FIRE PROTECTION WATER SERVICE IS PROVIDED TO THE PROPERTY BY THE WARWICK WATER DEPARTMENT. THE ONSITE WATER SYSTEM ON THE PROPERTY IS PRIVATE WATER PIPING AND SHALL BE (AWWA C901) DR9 POLYETHYLENE OR TYPE k COPPER FOR 2" SERVICES OR SMALLER, OR CLASS 52 DOUBLE CEMENT LINED DUCTILE IRON PIPE WITH TYTON JOINTS FOR 4" SERVICES OR LARGER. ALL BENDS, TEES ETC. SHALL BE JOINT RESTRAINED BY THE USE OF CONCRETE THRUST BLOCKS AND "MEG-A-LUG". ALL MATERIALS AND WORKMANSHIP SHALL CONFORM TO THE WARWICK WATER DEPARTMENT REGULATIONS, STANDARDS AND SPECIFICATIONS. NOTIFICATION SHALL BE PROVIDED TO SAID AUTHORITIES AT LEAST 72 HOURS PRIOR TO INITIATING CONSTRUCTION.
- 10. GATE VALVES SHALL BE CAST IRON BODY BRONZE MOUNTED, COMPLETE WITH ROAD BOX AND SHALL CONFORM TO THE WARWICK WATER DEPARTMENT REGULATIONS, STANDARDS AND SPECIFICATIONS.
- 11. ALL FIRE AND PLUMBING FIXTURES MUST CONFORM TO LOCAL SPECIFICATIONS AND AS STIPULATED BY THE LOCAL FIRE MARSHALL AND/OR THE BUILDING OFFICIAL.
- 12. ALL SANITARY SEWER MATERIALS AND WORKMANSHIP ASSOCIATED WITH THE INSTALLATION AND TESTING OF SANITARY SEWERS SHALL CONFORM TO THE WARWICK SEWER AUTHORITY (WSA) REGULATIONS, STANDARDS AND SPECIFICATIONS. ALL SEWER SYSTEM COMPONENTS MUST BE TESTED, CLEANED AND AS—BUILT INFORMATION MUST BE SUBMITTED TO THE CITY OF WARWICK AND APPROVED, PRIOR TO ISSUANCE OF A PERMIT TO CONNECT TO PUBLIC SEWER SYSTEM.
- 13. SANITARY SEWER MAINS AND SERVICES SHALL BE SDR-35 (ASTM D-3034) PVC SEWER PIPE WITH PUSH ON RUBBER RING JOINTS UNLESS NOTED OTHERWISE. CLEANOUTS SHALL BE INSTALLED AT BUILDING FACE (REFER PLUMBING PLANS FOR ALL WORK WITHIN 5' OF THE BUILDING). NEOPRENE COUPLINGS WITH STAINLESS STEEL BAND AND SHEER RINGS SHALL BE REQUIRED FOR JOINING DIFFERENT TYPES OF SANITARY SEWER PIPES.
- 14. SEWER LINES SHALL BE INSTALLED AT A MINIMUM 10 FOOT HORIZONTAL SEPARATION FROM ANY PROPOSED OR EXISTING WATER LINE.
- 15. WHENEVER SEWER LINES MUST CROSS WATER LINES, THE SEWER SHALL BE INSTALLED SO THAT THE TOP OF THE SEWER IS AT LEAST 18 INCHES BELOW THE BOTTOM OF THE WATER MAIN. WHERE 18 INCH VERTICAL SEPARATION & 10 FOOT HORIZONTAL SEPARATION CAN NOT BE MET AT WATER AND SEWER CROSSINGS, THE SEWER PIPE SHALL BE ENCASED IN CONCRETE OR BE EITHER DUCTILE IRON OR C900 BLUE BRUTE FOR A DISTANCE OF 10 FEET ON EACH SIDE OF CROSSING.
- 16. WHENEVER NEW SEWER LINES CONNECT TO EXISTING SEWER MANHOLES THE CONTRACTOR SHALL REBUILD THE EXISTING SEWER MANHOLE CHANNEL TO ACCOMMODATE THE NEW CONNECTION.
- 17. STORM DRAINS 12" AND OVER SHALL BE SMOOTH INTERIOR WALL AND EXTERIOR CORRUGATED HIGH DENSITY POLYETHYLENE (HDPE) PIPE CAPABLE OF WITHSTANDING (H-20) LOAD UNLESS NOTED OTHERWISE. PIPE SHALL BE JOINED USING BELL & SPIGOT JOINTS MEETING OR EXCEED ASTM F2648. THE JOINT SHALL BE SOIL—TIGHT AND GASKETS SHALL MEET OR EXCEED ASTM F477. HDPE PIPE SHALL BE AS MANUFACTURED BY ADVANCED DRAINAGE SYSTEMS INC. (ADS), HANCOR PIPE OR LANE PIPE. ALL STORM DRAINAGE PIPING SHALL BE LAID ON A SMOOTH CONTINUOUS GRADE WITH NO VISIBLE BENDS AT THE JOINTS. WHERE INDICATED ON DRAWINGS REINFORCED CONCRETE PIPE (RCP) PIPE SHALL BE CLASS III RCP WITH "O" RING GASKET JOINTS
- 18. GAS SERVICE FACILITIES SHALL BE DESIGNED BY OTHERS. CONTRACTOR SHALL BE RESPONSIBLE TO COORDINATE UTILITY INSTALLATIONS AS REQUIRED TO ENSURE ADEQUATE GAS SERVICE IS PROVIDED AND SHALL BE RESPONSIBLE FOR ALL INSTALLATION PROCEDURES (TRENCHING, LAYING PIPE, ETC.) AS ARE REQUIRED BY THE GAS COMPANY FOR COMPLETE AND IN PLACE CONSTRUCTION.
- 19. ELECTRIC SERVICE FACILITIES SHALL BE DESIGNED BY OTHERS. ELECTRIC SERVICE AND TRANSFORMER PAD SHALL CONFORM TO THE REQUIREMENTS OF THE ELECTRIC COMPANY. CONTRACTOR SHALL BE RESPONSIBLE FOR ENSURING ADEQUATE ELECTRIC SERVICE IS PROVIDED AND SHALL BE RESPONSIBLE FOR ALL INSTALLATION PROCEDURES (TRENCHING, LAYING PIPE, ETC.) AS ARE REQUIRED BY THE ELECTRIC COMPANY FOR COMPLETE AND IN PLACE CONSTRUCTION. REFER TO ELECTRICAL DRAWINGS FOR DETAILS ON ALL UNDERGROUND ELECTRIC.
- 20. TEL/CABLE SERVICE FACILITIES SHALL BE DESIGNED BY OTHERS. CONTRACTOR SHALL BE RESPONSIBLE FOR ENSURING ADEQUATE UTILITY SERVICE IS PROVIDED AND SHALL BE RESPONSIBLE FOR ALL INSTALLATION PROCEDURES (TRENCHING, LAYING PIPE ETC.) AS IS REQUIRED BY THE LOCAL UTILITY CO. FOR COMPLETE AND IN PLACE CONSTRUCTION. REFER TO ELECTRICAL DRAWINGS FOR ALL UNDERGROUND ELECTRIC.
- 21. SITE LIGHTING ELEMENTS ARE SHOWN FOR INFORMATIONAL PURPOSES ONLY. THE CONTRACTOR SHALL PROVIDE A PHOTOMETRICS PLAN TO THE CITY OF WARWICK PRIOR TO CONSTRUCTION. THE PLAN SHALL MEET THE APPLICABLE REQUIREMENTS OF THE CITY OF WARWICK. SITE CONTRACTOR SHALL BE RESPONSIBLE TO COORDINATE INSTALLATION OF LIGHT POLE BASES IN LOCATIONS INDICATED. REFER TO SITE LIGHTING PLANS FOR INSTALLATION REQUIREMENTS.
- 22. WHENEVER UTILITIES ARE TO BE INSTALLED WITHIN THE SANDY LANE RIGHT OF WAY, THE TRENCH MUST BE BACKFILLED WITH FLOWABLE FILL. ALL AREAS OF ROADWAY PAVEMENT DISTURBED DURING CONSTRUCTION SHALL BE RE-PAVED PER THE CITY OF WARWICK AND STATE STANDARDS AND

SPECIFICATIONS.

GENERAL DRAINAGE & GRADING NOTES:

- THE MAXIMUM RUNNING SLOPE ALONG ANY SIDEWALK SHALL BE 5%. THE MAXIMUM CROSS SLOPE ACROSS
 ANY SIDEWALK SHALL BE 2%. A MINIMUM 5'x5' LANDING SHALL BE PROVIDED IN FRONT OF ALL BUILDING
 ENTRANCES.
- 2. ALL ADAAG PARKING SAPCES AND LOADING SPACES SHALL BE 2% MAXIMUM SLOPE IN ANY DIRECTION.
- CONTRACTOR SHALL ASSURE POSITIVE DRAINAGE AWAY FROM BUILDINGS FOR ALL NATURAL AND PAVED AREAS.
- 4. ALL GRATES AND COVERS IN PAVED AREAS SHALL BE FLUSH WITH PAVEMENT, AND SHALL HAVE TRAFFIC BEARING RING & COVERS. MANHOLES IN UNPAVED AREAS SHALL BE 3" ABOVE FINISH GRADE.
- CONTRACTOR SHALL ADJUST AND/OR CUT EXISTING PAVEMENT AS NECESSARY TO ASSURE A SMOOTH FIT AND CONTINUOUS GRADE.
- 6. ALL UNSURFACED AREAS DISTURBED BY GRADING OPERATION SHALL RECEIVE 4 INCHES OF TOPSOIL. CONTRACTOR SHALL APPLY STABILIZATION FABRIC TO ALL SLOPES 3H:1V OR STEEPER. CONTRACTOR SHALL GRASS DISTURBED AREAS IN ACCORDANCE WITH THE CITY OF PROVIDENCE SPECIFICATIONS UNTIL A HEALTHY STAND OF GRASS IS OBTAINED.

STORMWATER SYSTEM MAINTENANCE NOTES:

THE DRAINAGE SYSTEMS ARE TO BE MONITORED THROUGHOUT THE ENTIRE CONSTRUCTION PERIOD BY THE CONTRACTOR. UPON COMPLETION OF THE PROJECT THE CONTRACTOR MUST DO A FINAL FULL MAINTENANCE & CLEAN UP OF THE STORMWATER MANAGEMENT SYSTEM AND THE SITE. UPON COMPLETION OF THE CONTRACTOR'S FINAL MAINTENANCE & CLEAN UP OF THE PROJECT, MONITORING OF THE STORMWATER MANAGEMENT SYSTEM SHALL BE THE RESPONSIBILITY OF THE OWNER.

CONSTRUCTION MONITORING/MAINTENANCE PROCEDURES SHALL BE AS FOLLOWS: (RESPONSIBILITY OF CONTRACTOR)

SILT BARRIER:

MONITOR SILT BARRIER ON A WEEKLY BASIS AND AFTER EVERY RAIN STORM EVENT AND REPAIR OR REPLACE ANY DAMAGED AREAS IMMEDIATELY. IMMEDIATELY CLEAN THE SILT BARRIER IF SIX INCHES OR MORE OF SEDIMENT HAS ACCUMULATED ON THE HAYBALE & SILT BARRIER.

2. PAVED AREAS:

PARKING LOTS, PUBLIC & PRIVATE ROADWAYS AND GUTTERS SHALL BE SWEPT CLEAN OF ALL SEDIMENT & DEBRIS. SWEEPING & REMOVAL OF DEBRIS SHALL BE PERFORMED ON A WEEKLY BASIS AT A MINIMUM.

CATCH BASINS: ALL CATCH BASINS:

ALL CATCH BASINS SHALL BE INSTALLED AS DETAILED AND INSPECTED AFTER EVERY RAIN STORM EVENT. IMMEDIATELY CLEAN THE CATCH BASIN SUMP IF TWO FEET OR MORE OF SEDIMENT HAS ACCUMULATED WITHIN THE CATCH BASIN.

DRAIN MANHOLES: DRAIN MANHOLES

DRAIN MANHOLES SHALL BE INSTALLED AS DETAILED AND INSPECTED AFTER EVERY RAIN STORM EVENT. IMMEDIATELY CLEAN THE DRAIN MANHOLE IF ANY SEDIMENT HAS ACCUMULATED WITHIN THE DRAIN MANHOLE.

STORMWATER BMPS: NO CONSRUCTION F

NO CONSRUCTION RUNOFF SHALL BE DIRECTED TO STORMWATER BMPS UNTIL UPGRADIENT AREAS ARE STABILIZED.

POST CONSTRUCTION MONITORING/MAINTENANCE PROCEDURES SHALL BE AS FOLLOWS: (RESPONSIBILITY OF OWNER)

1. PAVED AREAS

PARKING LOTS, ROADS AND ALL ACCESS WAYS AND GUTTERS MUST BE SWEPT CLEAN OF ALL SEDIMENT AND DEBRIS ON BI-ANNUAL BASIS IN SPRING AND FALL OF EACH YEAR OR AS NECESSARY.

2. CATCH BASINS:

ALL CATCH BASINS MUST BE INSPECTED AND MAINTAINED ON A BI-ANNUAL BASIS IN MARCH AND OCTOBER OF EACH YEAR. CATCH BASINS MUST BE INSPECTED TO ENSURE THEY HAVE ADEQUATE SUMP CAPACITY, FRAMES AND GRATES ARE NOT DAMAGED, AND OIL/WATER SEPARATING DEVICES ARE IN PLACE. CATCH BASIN SUMPS ARE TO BE CLEANED OUT DURING BI-ANNUAL INSPECTIONS IN MARCH AND OCTOBER OF EACH YEAR. IMMEDIATELY CLEAN THE CATCH BASIN SUMP IF TWO FEET OR MORE OF SEDIMENT HAS ACCUMULATED WITHIN THE CATCH BASIN.

3. DRAIN MANHOLES:

ALL DRAIN MANHOLES:

ALL DRAIN MANHOLES MUST BE INSPECTED AND MAINTAINED ON A BI-ANNUAL BASIS IN MARCH AND OCTOBER OF EACH YEAR. DRAIN MANHOLES MUST BE INSPECTED TO ENSURE FRAMES AND COVERS ARE NOT DAMAGED AND NO BLOCKAGES HAVE OCCURRED WITHIN THE MANHOLE. DRAIN MANHOLES ARE TO BE CLEANED OUT DURING BI-ANNUAL INSPECTIONS IN MARCH AND OCTOBER OF EACH YEAR. IMMEDIATELY CLEAN THE DRAIN MANHOLE IF ANY SEDIMENT HAS ACCUMULATED.

4. STORMWATER MANAGEMENT FACILITIES — REFER TO OPERATIONS AND MAINTENANCE PLAN UNDER SEPARATE COVER.

INFILTRATION AREA CONSTRUCTION PROTECTION

FOR THE LONG-TERM FUNCTION OF THE INFILTRATING SYSTEMS, CARE MUST BE TAKEN IN THIS AREA DURING CONSTRUCTION. THE CONTRACTOR SHALL EMPLOY THE FOLLOWING MINIMUM BEST MANAGEMENT PRACTICES (BMP'S):

- 1. THE INFILTRATION AREAS SHALL NOT BE USED AS A CONSTRUCTION SEDIMENTATION SYSTEM.
- 2. CONSTRUCTION EQUIPMENT, VEHICULAR TRAFFIC, PARKING OF VEHICLES, AND STOCKPILING OF CONSTRUCTION AND EARTH MATERIALS SHALL BE OUTSIDE THE LIMITS OF THE INFILTRATION AREA UNTIL INSTALLATION IS COMPLETED. THE SUBGRADE BENEATH THE SYSTEM SHALL NOT BE COMPACTED.
- 3. EXCAVATION FOR CONSTRUCTION OF THE INFILTRATION AREAS SHALL BE PERFORMED MANUALLY OR BY HYDRAULIC EXCAVATOR OR SOME OTHER SIMILAR MEANS TO ENSURE THAT THE EQUIPMENT IS NOT IN DIRECT CONTACT WITH THE NATURAL INFILTRATION EARTH MATERIAL AND DOES NOT CAUSE COMPACTION OF THE MATERIAL AND THE ENTIRE AREA IS TO BE SCARIFIED PRIOR TO INSTALLATION.
- 4. THE CONTRACTOR SHALL INSTALL TEMPORARY CONSTRUCTION FENCING AND EROSION CONTROLS AROUND THE PERIMETER OF THE INFILTRATION AREA TO PREVENT THE USE OF THIS AREA FOR ALL ACTIVITIES THAT MIGHT DAMAGE THE INFILTRATION CAPABILITIES OF THE AREA. THIS FENCING MAY BE REMOVED FOR BACKFILLING AND FINAL CONSTRUCTION.

SITE PLAN LEGEND (RIDOT)

- (BCP) BITUMINOUS CONCRETE PAVEMENT
- CM CUT AND MATCH PAVEMENT
- LS 4" LOAM AND SEEDING, TYPE 2
- 3.3.4) BRICK/ SOLID BLOCK DOUBLE GRATE CATCH BASIN GRATE
- PARALLEL TO EDGE OF PAVEMENT

 (6.2.1) HEAVY DUTY ROUND FRAME AND COVER
- (6.3.2) HIGH CAPACITY FRAME AND GRATE (BICYCLE SAFE)
- 7.1.0 PRECAST CONCRETE CURB
- 7.3.0 GRANITE CURB

 (7.3.9) GRANITE RAMP STONE
- (7.6.0) CURB SETTING DETAIL
- (8.4.0) PAVED WATERWAY

- (9.9.0) CONSTRUCTION ACCESS
- (20.1.0) PAVEMENT MARKINGS- ARROWS AND ONLY
- (43.1.0) CEMENT CONCRETE SIDEWALK
- 43.2.0 BITUMINOUS CONCRETE SIDEWALK
- 43.3.0 WHEELCHAIR RAMP

6W

- (43.3.1) WHEELCHAIR RAMP FOR LIMITED RIGHT-OF-WAY AREAS
- 48.1.0 DETECTIBLE WARNING PANEL PLACEMENT

6" PAVEMENT MARKINGS

- 4" PAVEMENT MARKINGS
- 12" PAVEMENT MARKINGS-CROSSWALKS & STOP BAR

<u>ABBREVIATIONS</u>

SITE LEGEND

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—— E——

——F——

____FD____

____ G ____

——онw——

___s__

____T___

x 64.00(BC)

 \times 64.50(TC)

64.50(BW)

64.50(TW)

-0-0-0-

(Ⅲ) CB#1

CTB ►

DMH

B

SEV

(1)

GEN

⊖GC0

•-

(X.X.X.)

x 64.00

DESCRIPTION

STORM DRAIN

FIRE SERVICE

GAS

FOOTING DRAIN

OVERHEAD WIRE

PROPERTY LINE

TELEPHONE

WATER

CONTOUR

SPOT GRADE

SANITARY SEWER

SITE LIGHTING SERVICE

SPOT GRADE (BOT. OF CURB)

SPOT GRADE (TOP OF CURB)

SPOT GRADE (BOT. OF WALL)

SPOT GRADE (TOP OF WALL)

PRECAST CONC. CURB

CHAINLINK FENCE (CLF)

BORING LOCATION

CATCH BASIN

DRAIN MANHOLE

SEWER MANHOLE

WATER SERVICE

UTILITY POLE

FIRE HYDRANT

WETLAND

STOCKADE FENCE (STKF)

DOUBLE GRATE CATCH BASIN

CONCRETE THRUST BLOCK

FLARED END STRUCTURE

GATE VALVE AND CURB BOX

SOIL EVALUATION LOCATION

FIRE DEPARTMENT CONNECTION

POST INDICATOR VALVE (PIV)

ELECTRIC MANHOLE (EMH)

TELEPHONE MANHOLE (TMH)

TEST PIT LOCATION

TRANSFORMER PAD

GROUND CLEANOUT

SIGHT LIGHT POLE

LIMIT OF DISTURBANCE

TRAFFIC FLOW DIRECTION

PAVEMENT SAWCUT & MATCH

RIDOT STD DETAIL REFERENCE

COMPOST SILT SOCKS

TO EXISTING

GENERATOR PAD

HANDICAP SYMBOL (PRKG. SPACE)

CENTERLINE (LAYOUT)

ELECTRIC (UNDERGROUND)

EXISTING

____F

____ G ____

----OHW-----

____ S ____

_____ SI ____

____64 -----

×64.0(BC)

x 64.5(TC)

64.5(BW)

64.5(TW)

-0-0-0-0-

0 0 0 0

□ CB

CTB ▷

DMH

SEV.

DFDC

GEN

⊖GCO

O LP

 \Rightarrow

CB(DG)

 $\times 64.0$

CAST IRON PIPE CLDI CEMENT LINED DUCTILE IRON PIPE CLF CHAINLINK FENCE CTE POINT OF CONNECTION TO EXISTING D.I. DUCTILE IRON PIPE **ESHWT** ESTIMATED SEASONAL HIGH WATER TABLE ETR EXISTING TO REMAIN EX. EXISTING F&I FURNISH AND INSTALL HDPE HIGH DENSITY POLYETHYLENE PIPE INV. INVERT ELEVATION MTE MATCH TO EXISTING NIC NOT IN CONTRACT NTS NOT TO SCALE PVC POLYVINYL CHLORIDE PIPE RCP REINFORCED CONCRETE PIPE VIF VERIFY IN FIELD WATER QUALITY STRUCTURE

GENERAL NOTES & LEGEND

FOR HILLSGROVE AT CITY CENTRE

SITUATED AT

A.P. 278, LOT 144

298 KILVERT STREET

WARWICK, RI

REV. PER PRELIMINARY SSH 05/03/2		REVISION	BY	DATE
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MENTAL SCIENTISTS

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STREET 45 E, R.I. 02940

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P.O. BO
PROVID

JOB NO.
7272-00
DWG. NO.
7272-00-Cover.dwg

SCALE:
AS SHOWN

DRAWN BY K.Y.Y.

CHECK BY S.S.H.

APPROVED S.B.G.


DATE:
JANUARY 26, 2021

SHEET

C-1

2 OF 19 SHEETS


.\7272-00 Kilvert Street (Centerville) - Warwick, RI\dwq\01-Current\7272-00-Cover.dwq 06/08/2021 ky

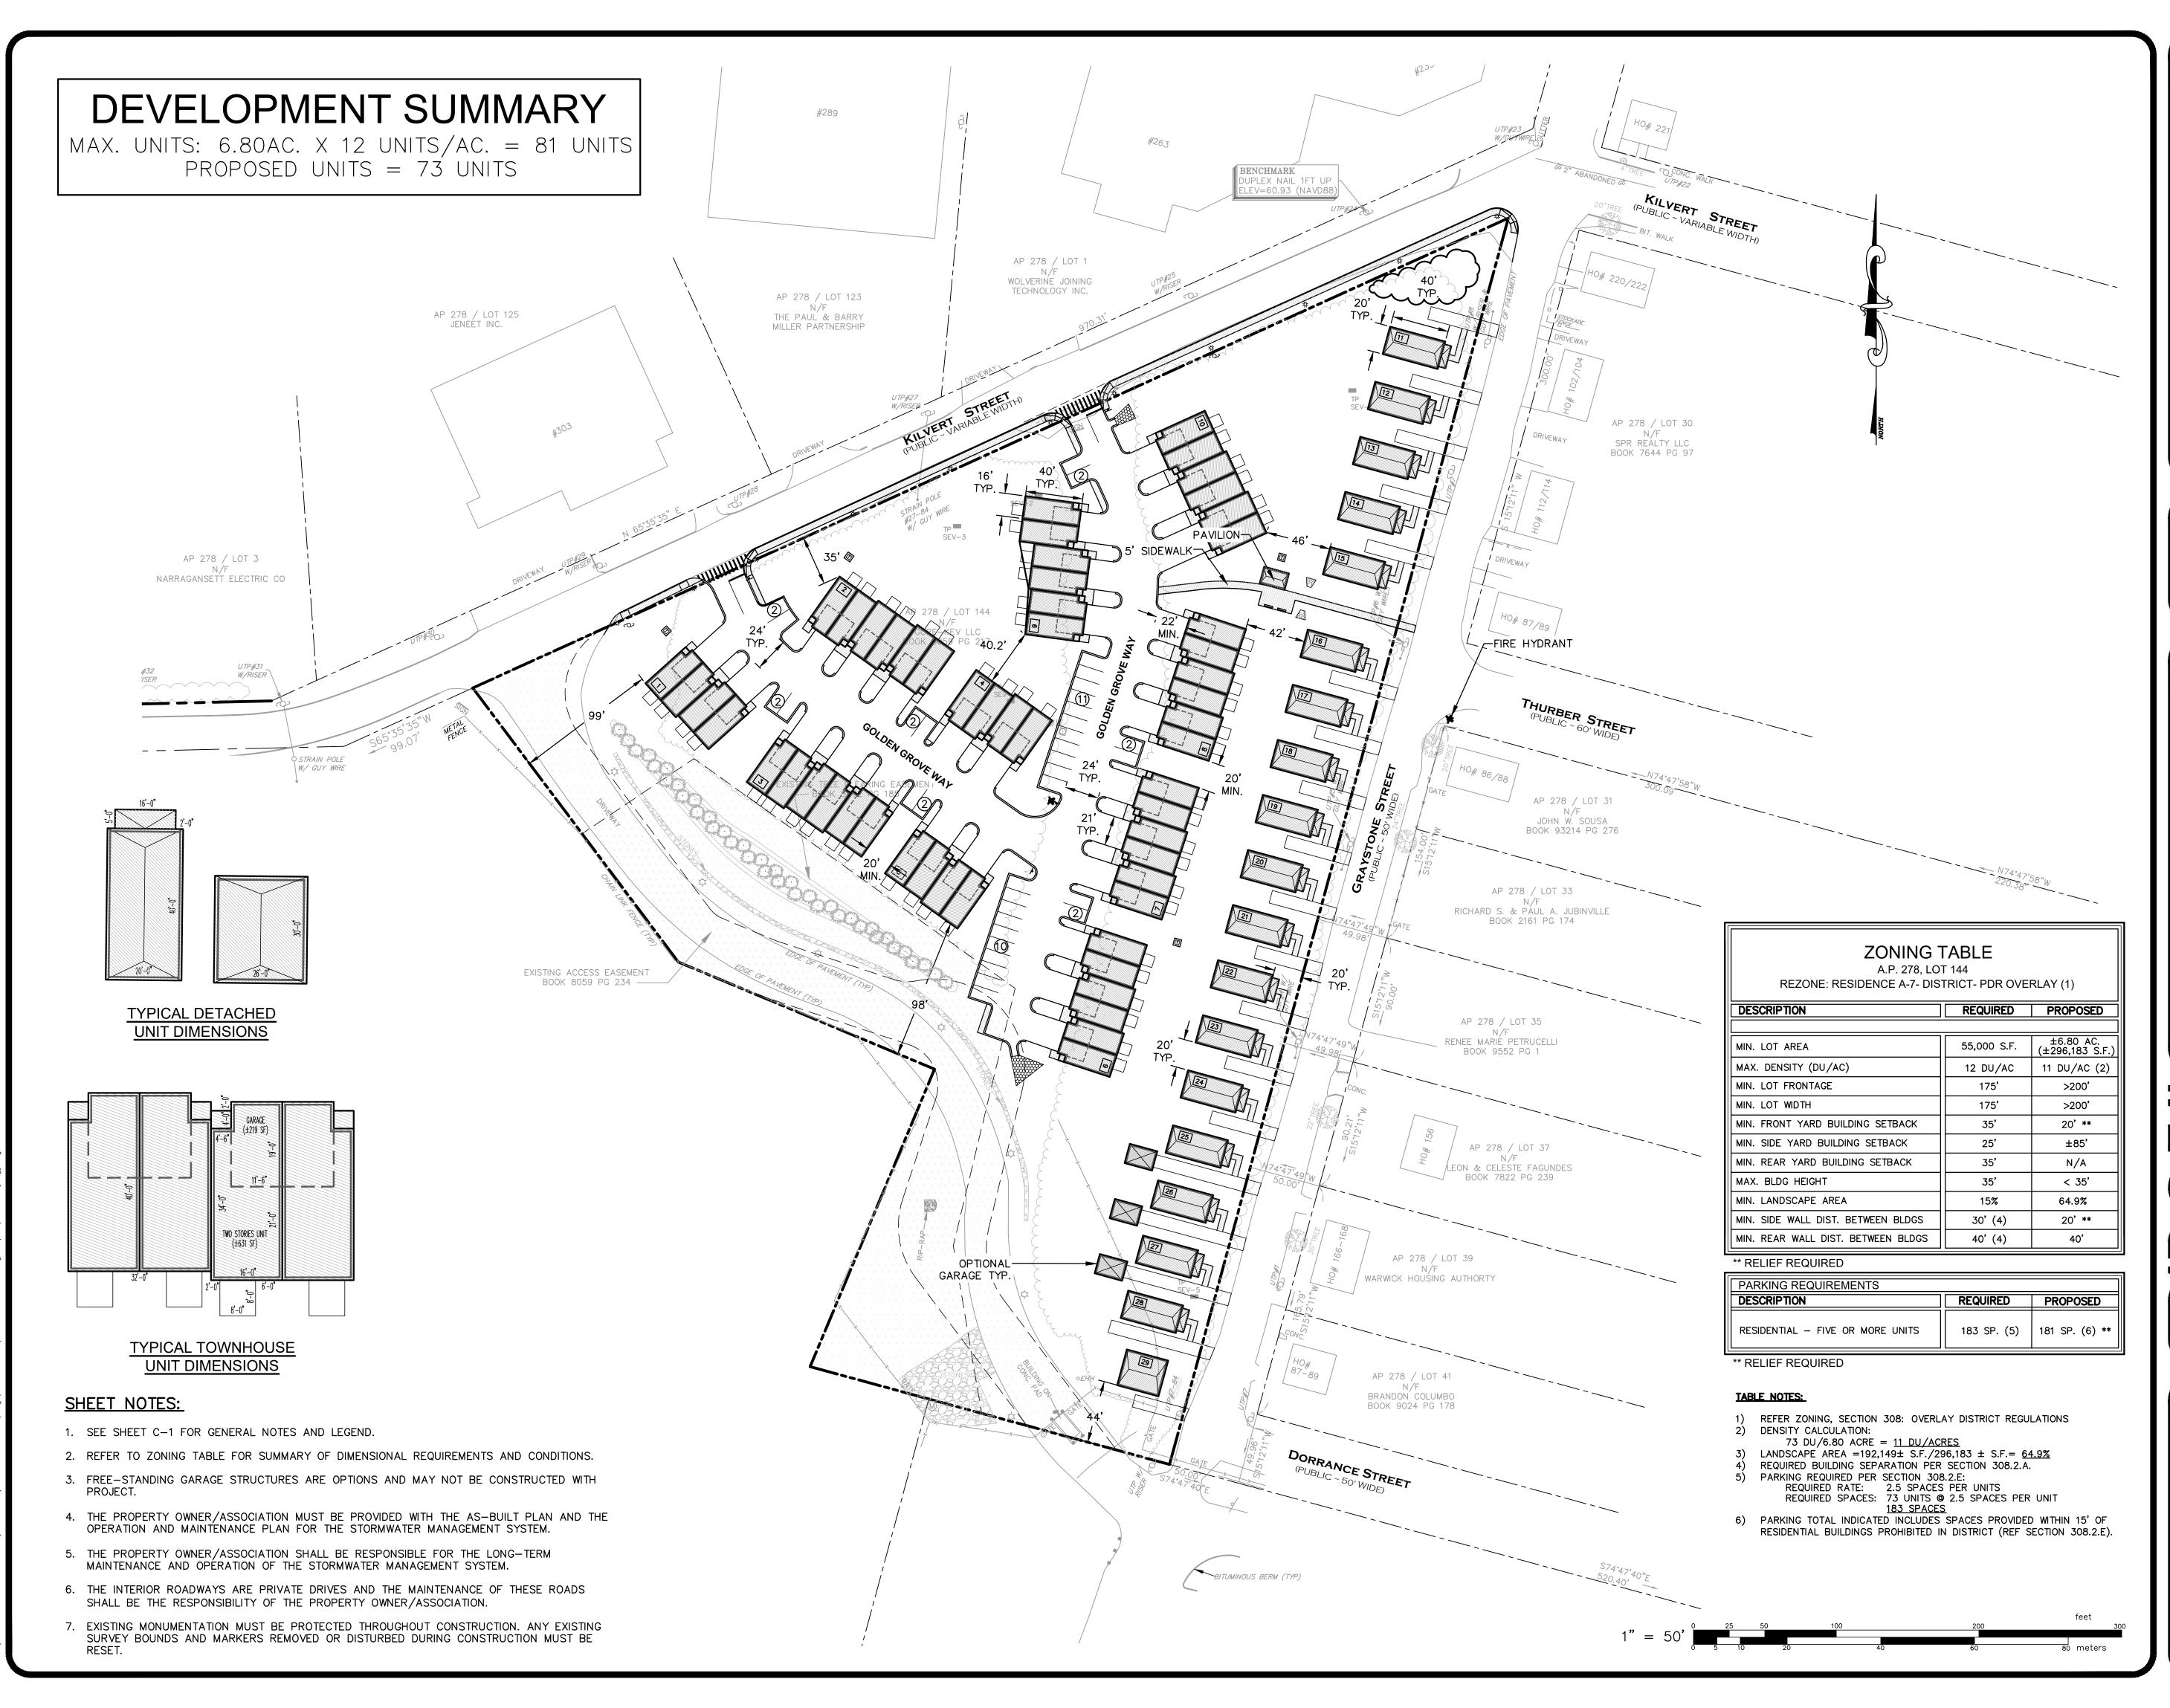

NO.	REVISION	BY	DATE
1	REV. PER PRELIMINARY	SSH	05/03/2021
2	PER CITY COMMENTS	KYY	05/27/2021
4	NOTES PER CITY COMMENTS	KYY	07/06/2021

JANUARY 26, 2021

JOB NO. 7272–00	DRAWN BY	K.Y.Y.
DWG. NO. 7272-00-Base.dwg	СНЕСК ВҮ	S.S.H.
SCALE:	APPROVED	S.B.G.
AS SHOWN	DATE:	

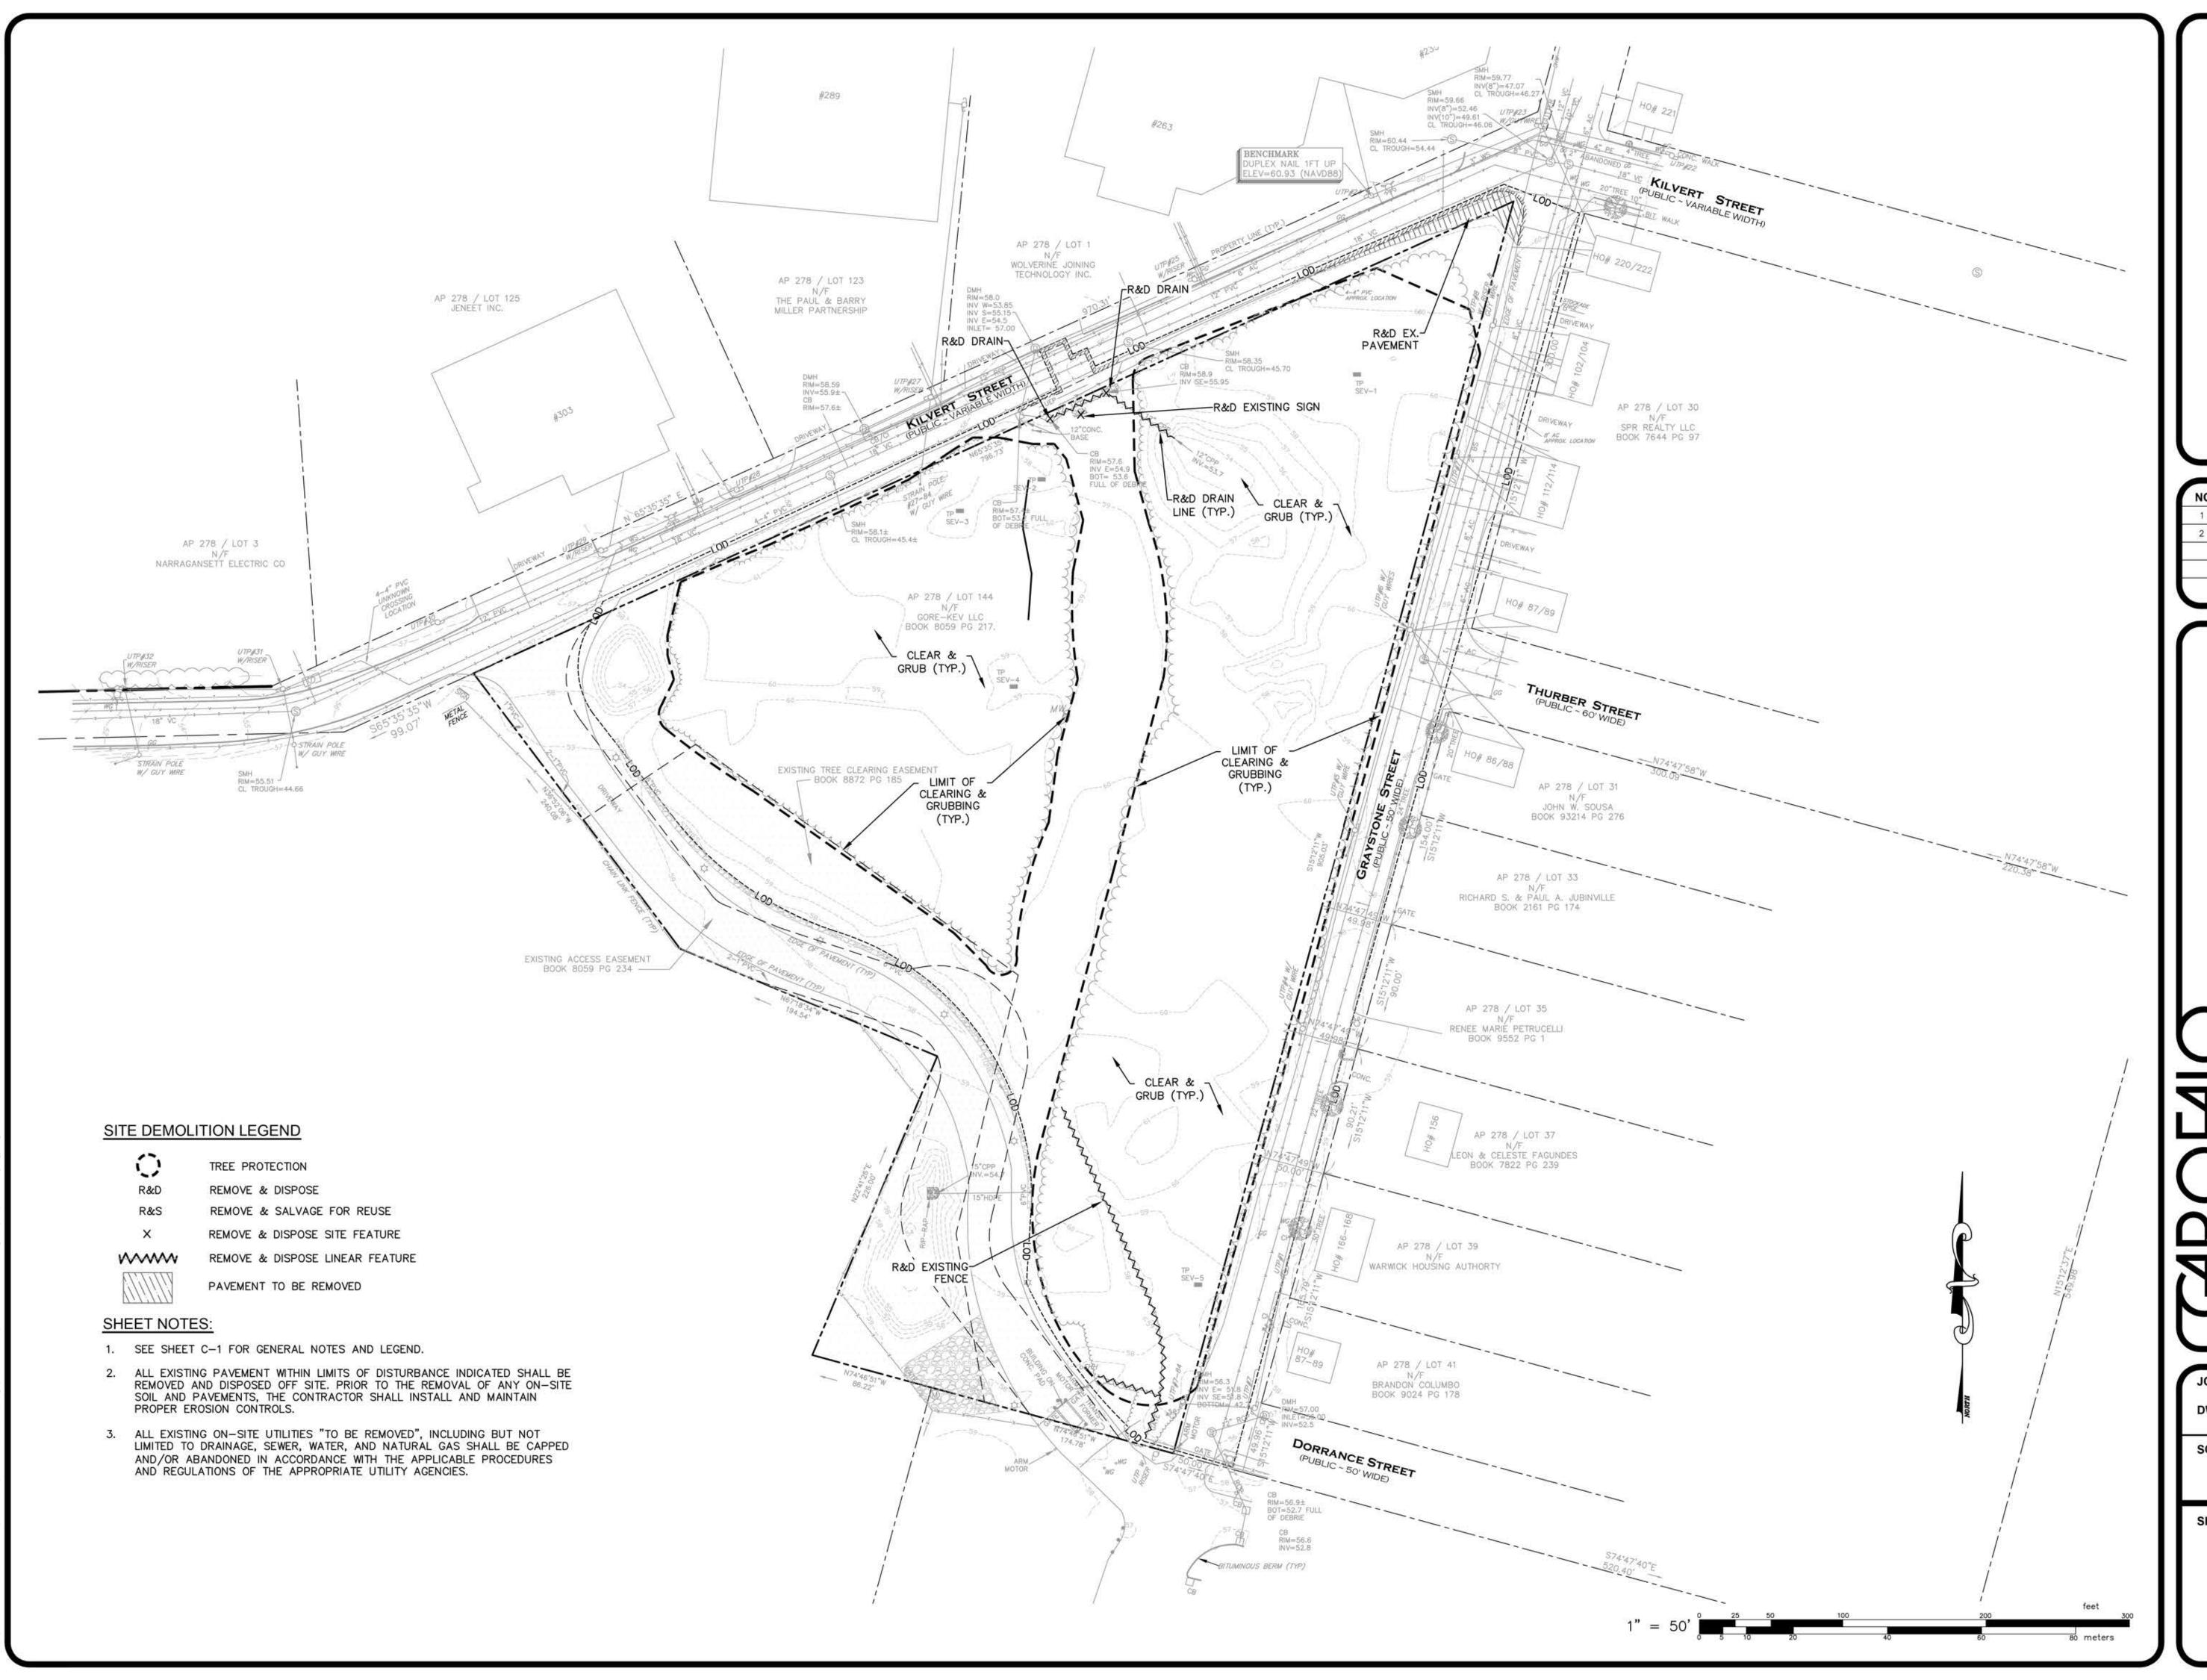



NO.	REVISION	BY	DATE
1	REV. PER PRELIMINARY	SSH	05/03/2021
2	PER CITY COMMENTS	KYY	05/27/2021
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		-	

DRAWN BY K.Y.Y. 7272-00 DWG. NO. 7272-00-Base.dwg SCALE: AS SHOWN

CHECK BY S.S.H. APPROVED S.B.G. DATE: JANUARY 26, 2021

SHEET

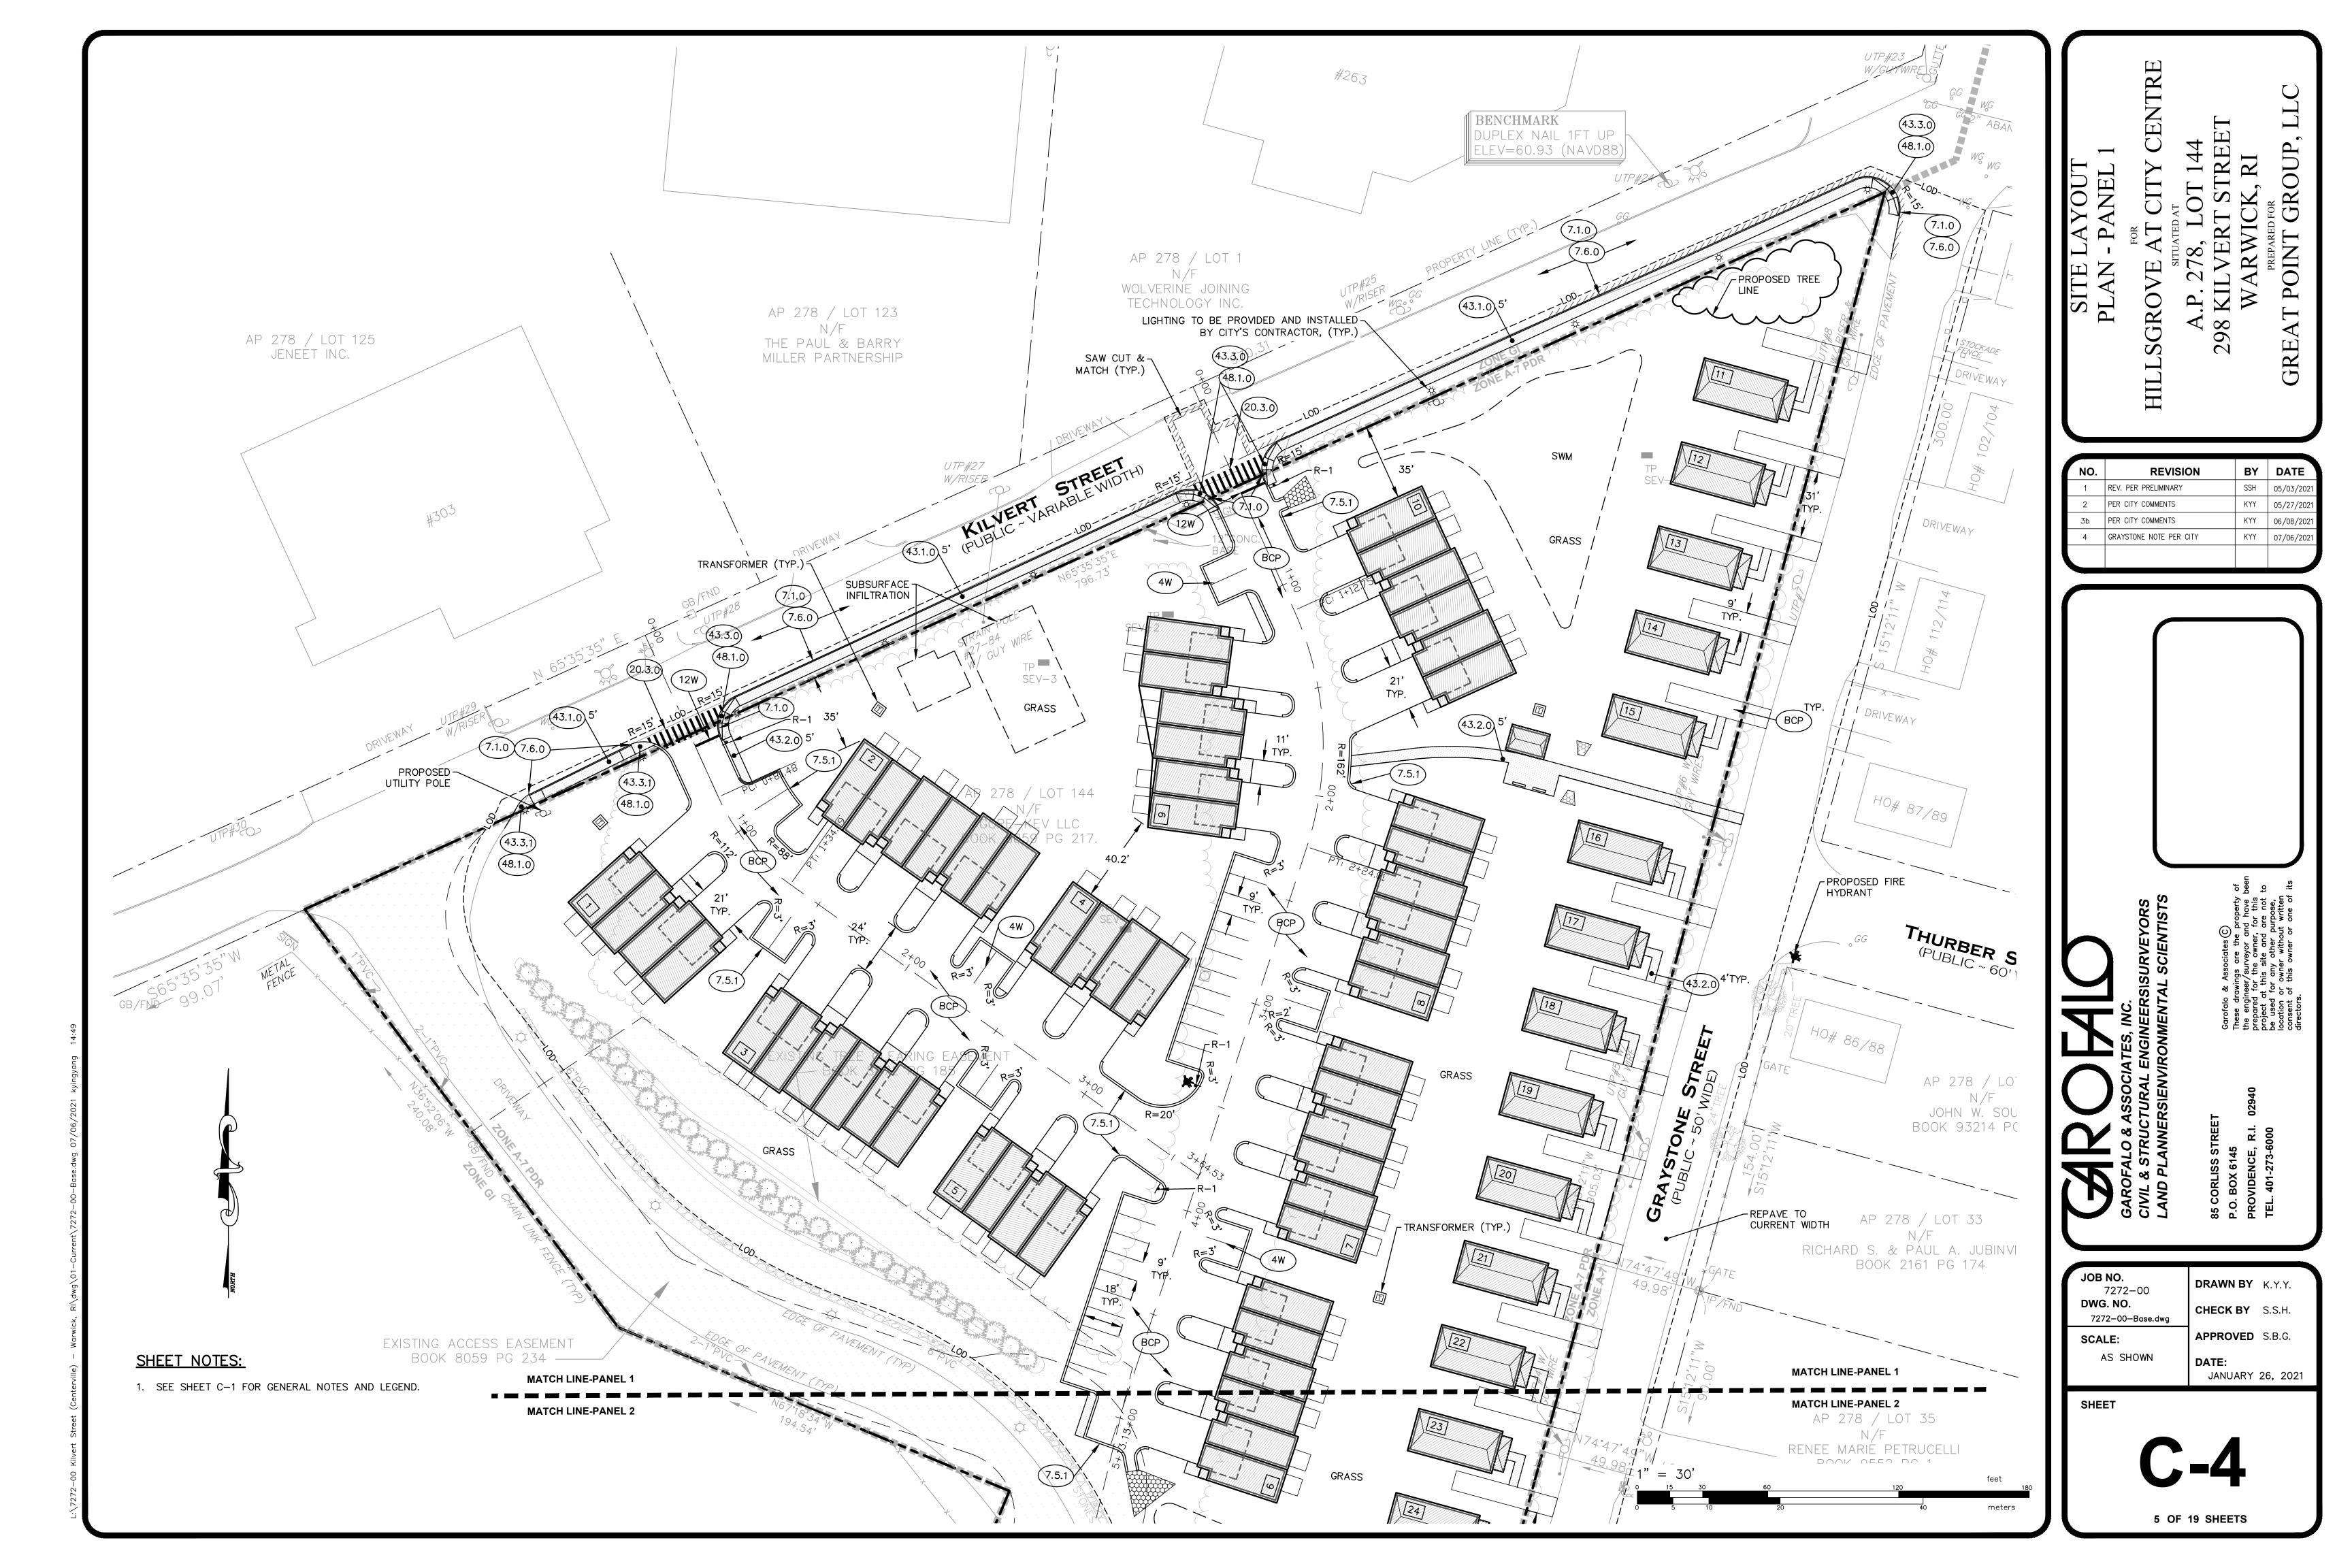


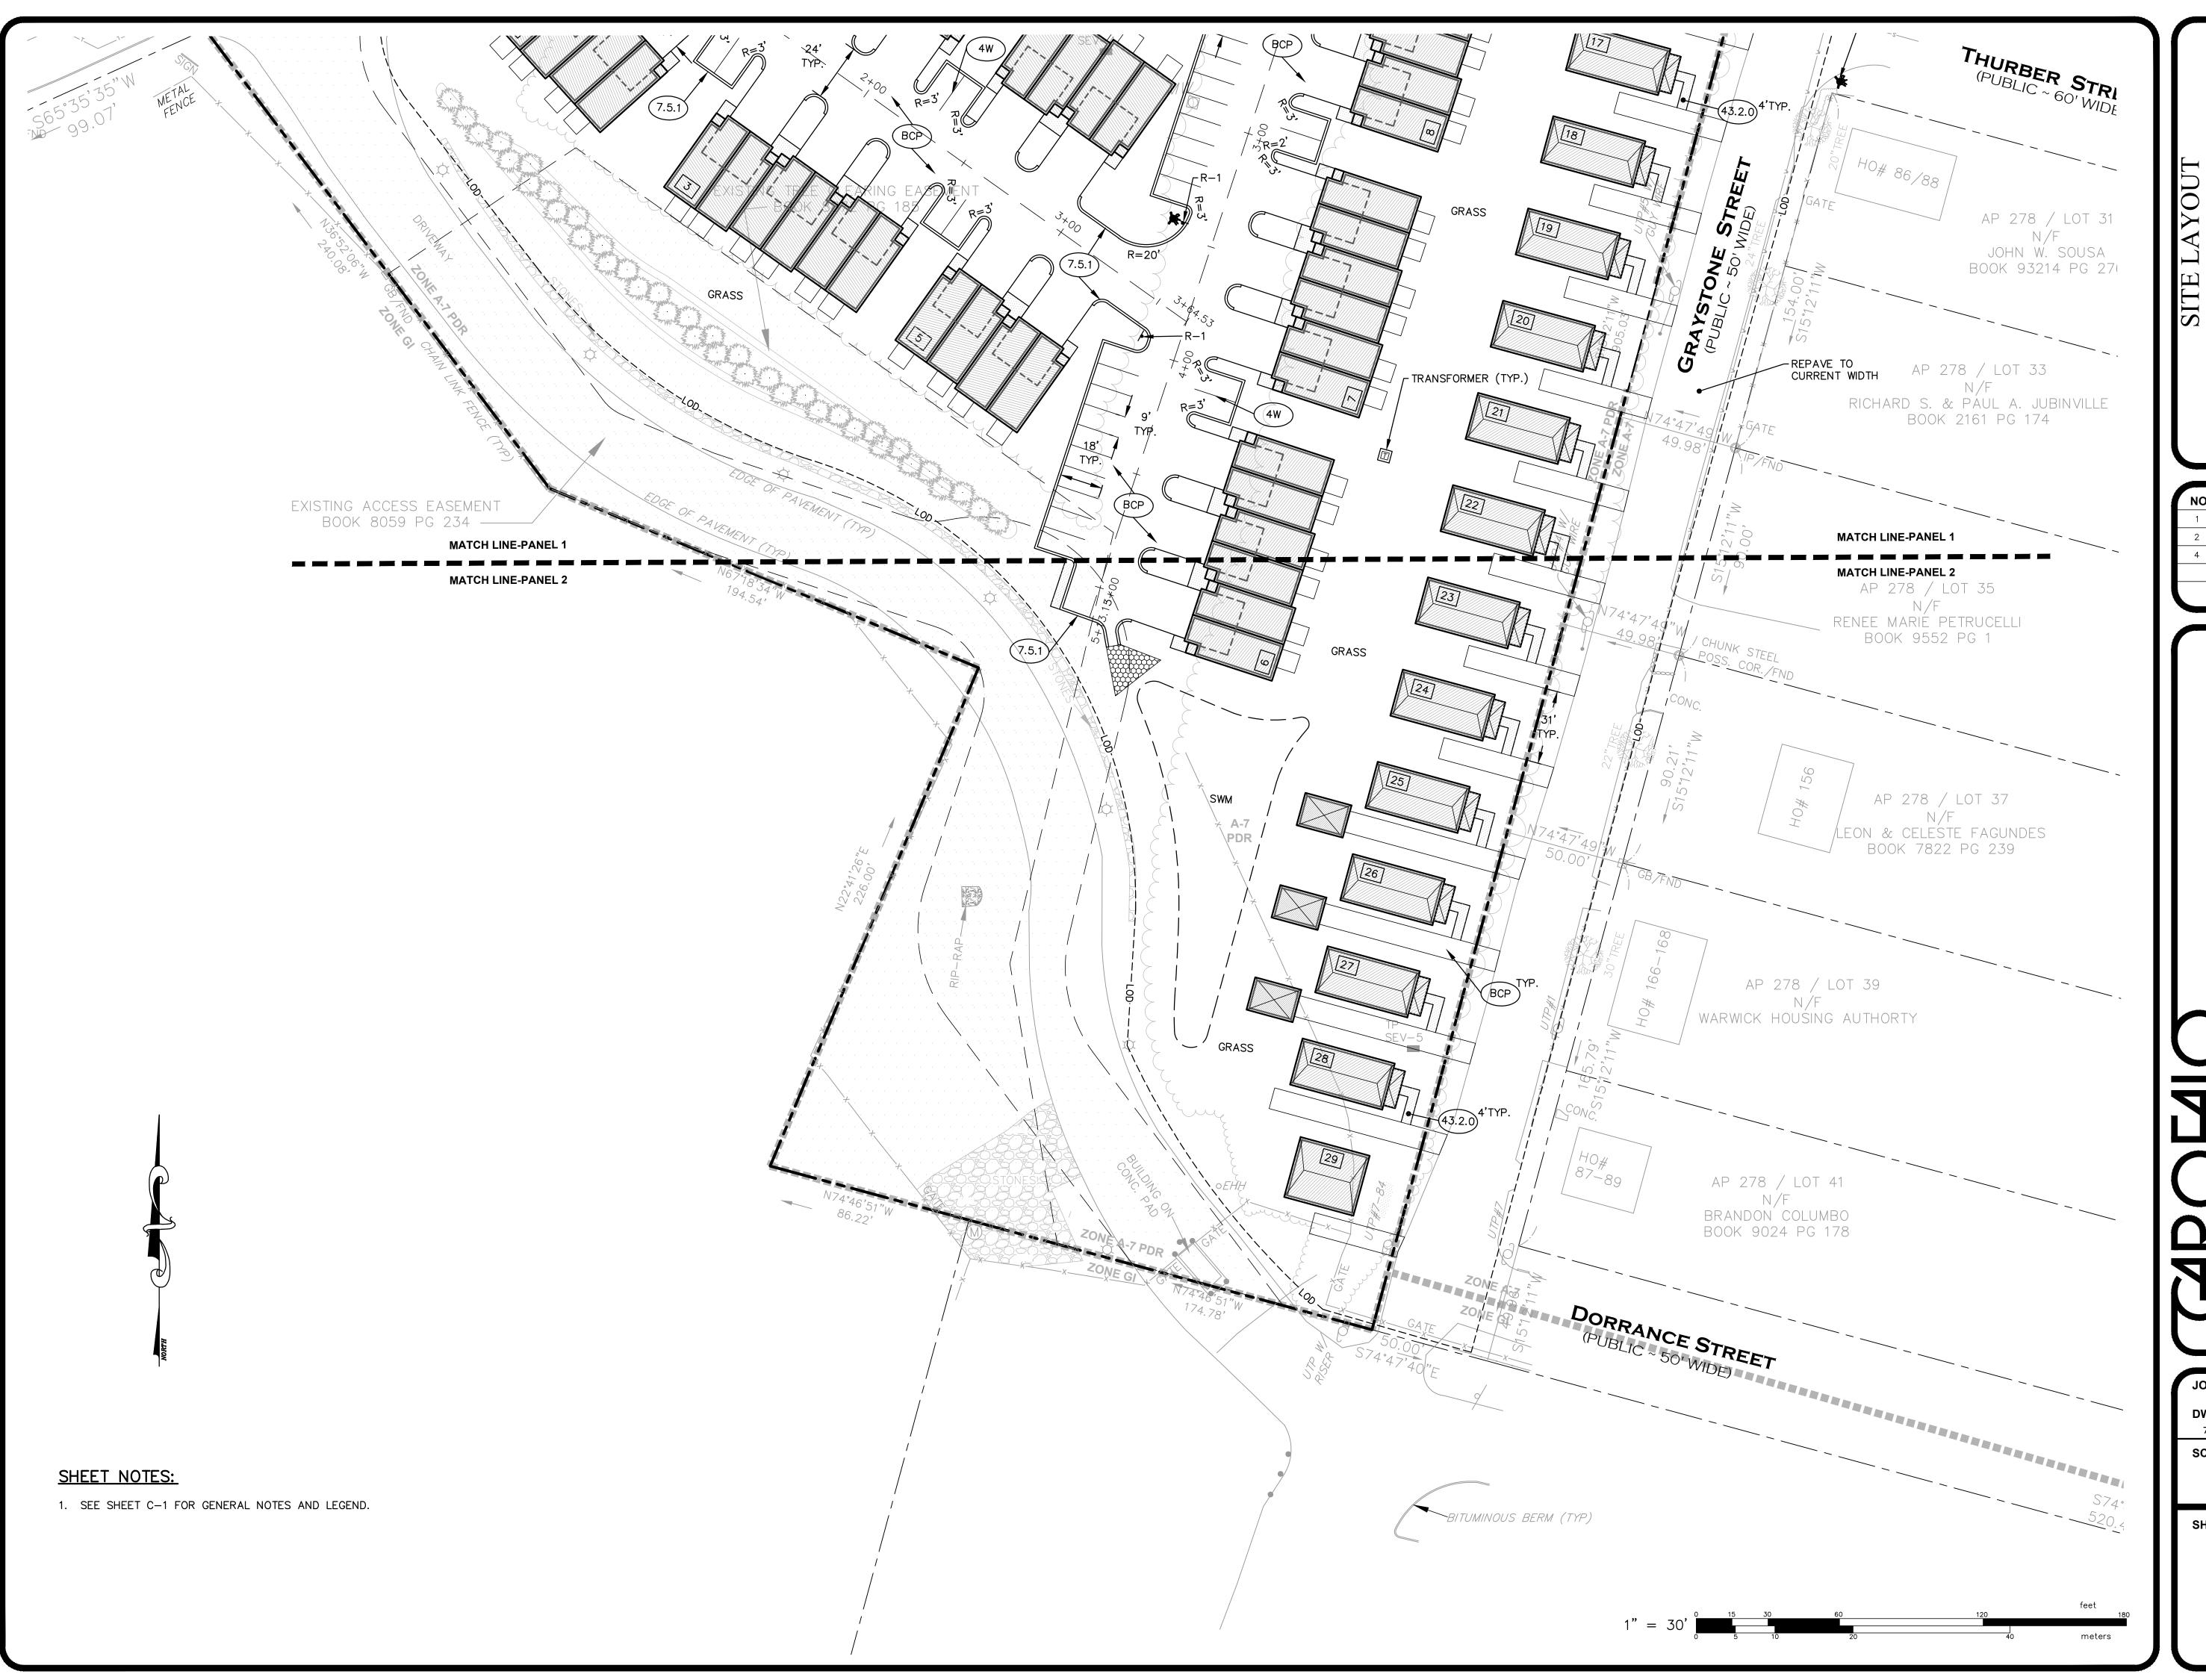


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NO.	REVISION	BY	DATE
1	REV. PER PRELIMINARY	SSH	05/03/2021
2	PER CITY COMMENTS	KYY	05/27/2021
4	GRAYSTONE NOTE PER CITY	KYY	07/06/2021

JANUARY 26, 2021

JOB NO. DRAWN BY K.Y.Y. 7272-00 CHECK BY S.S.H. 7272-00-Base.dwg **APPROVED** S.B.G. SCALE: AS SHOWN DATE:

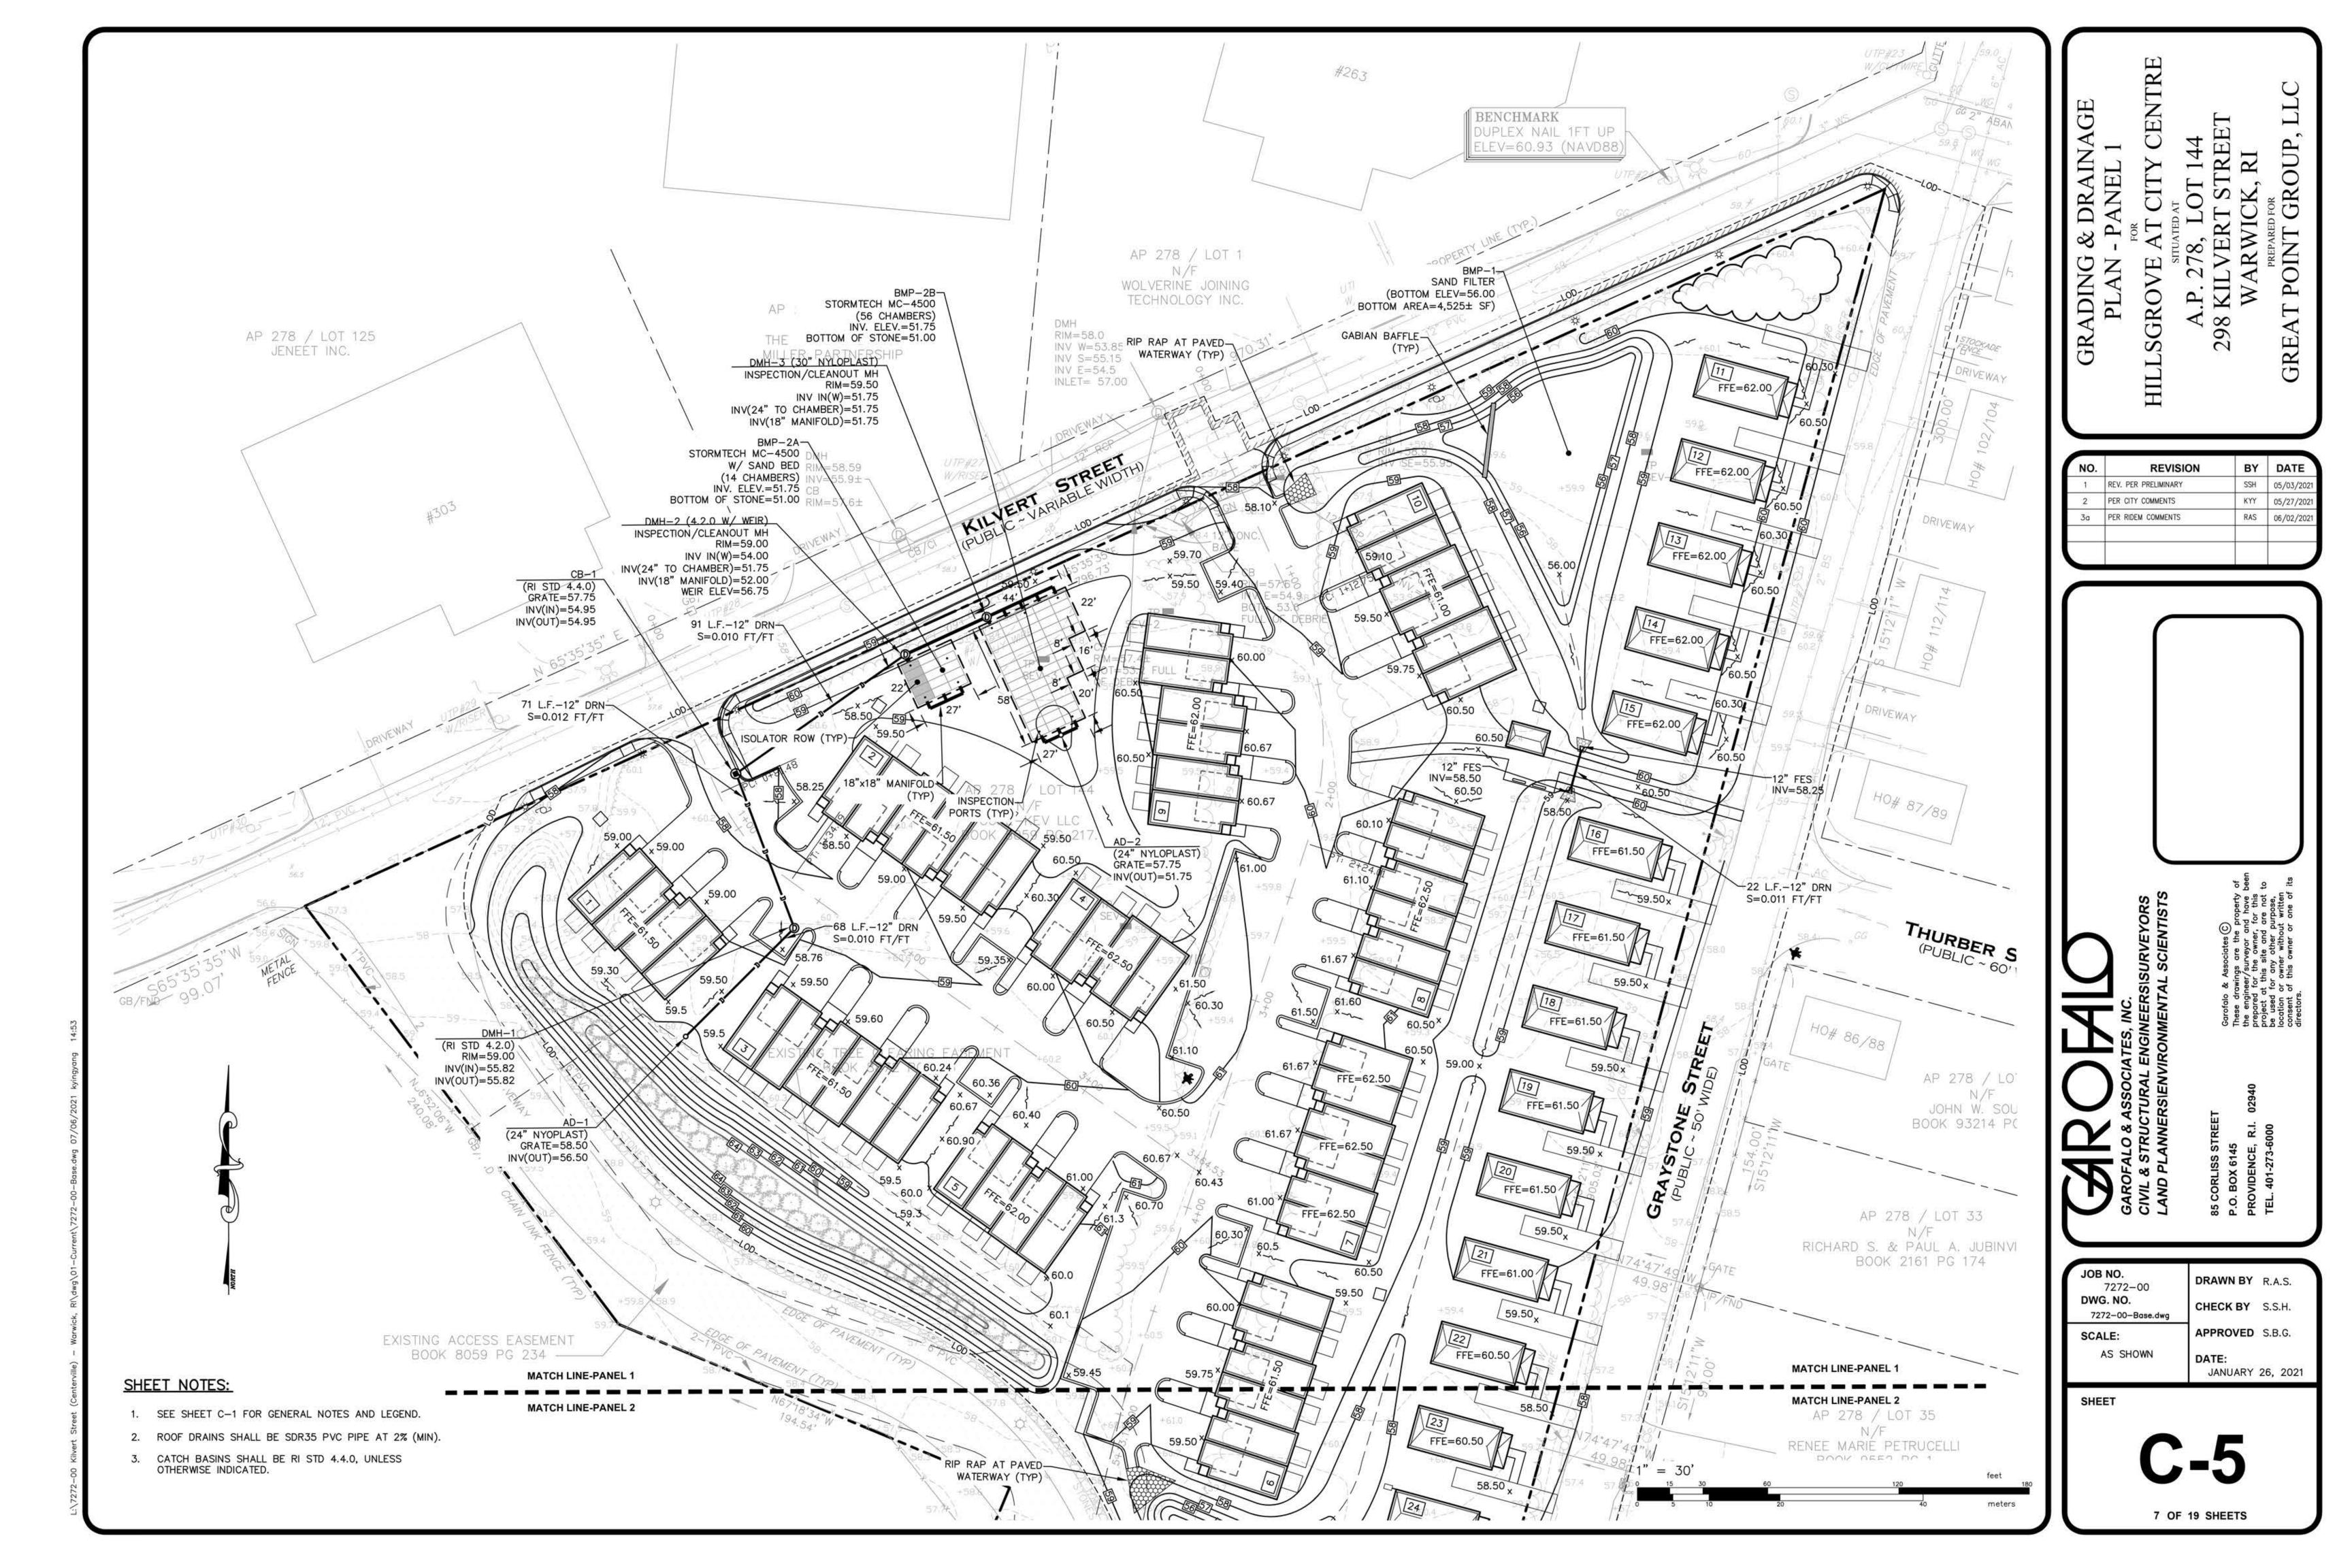

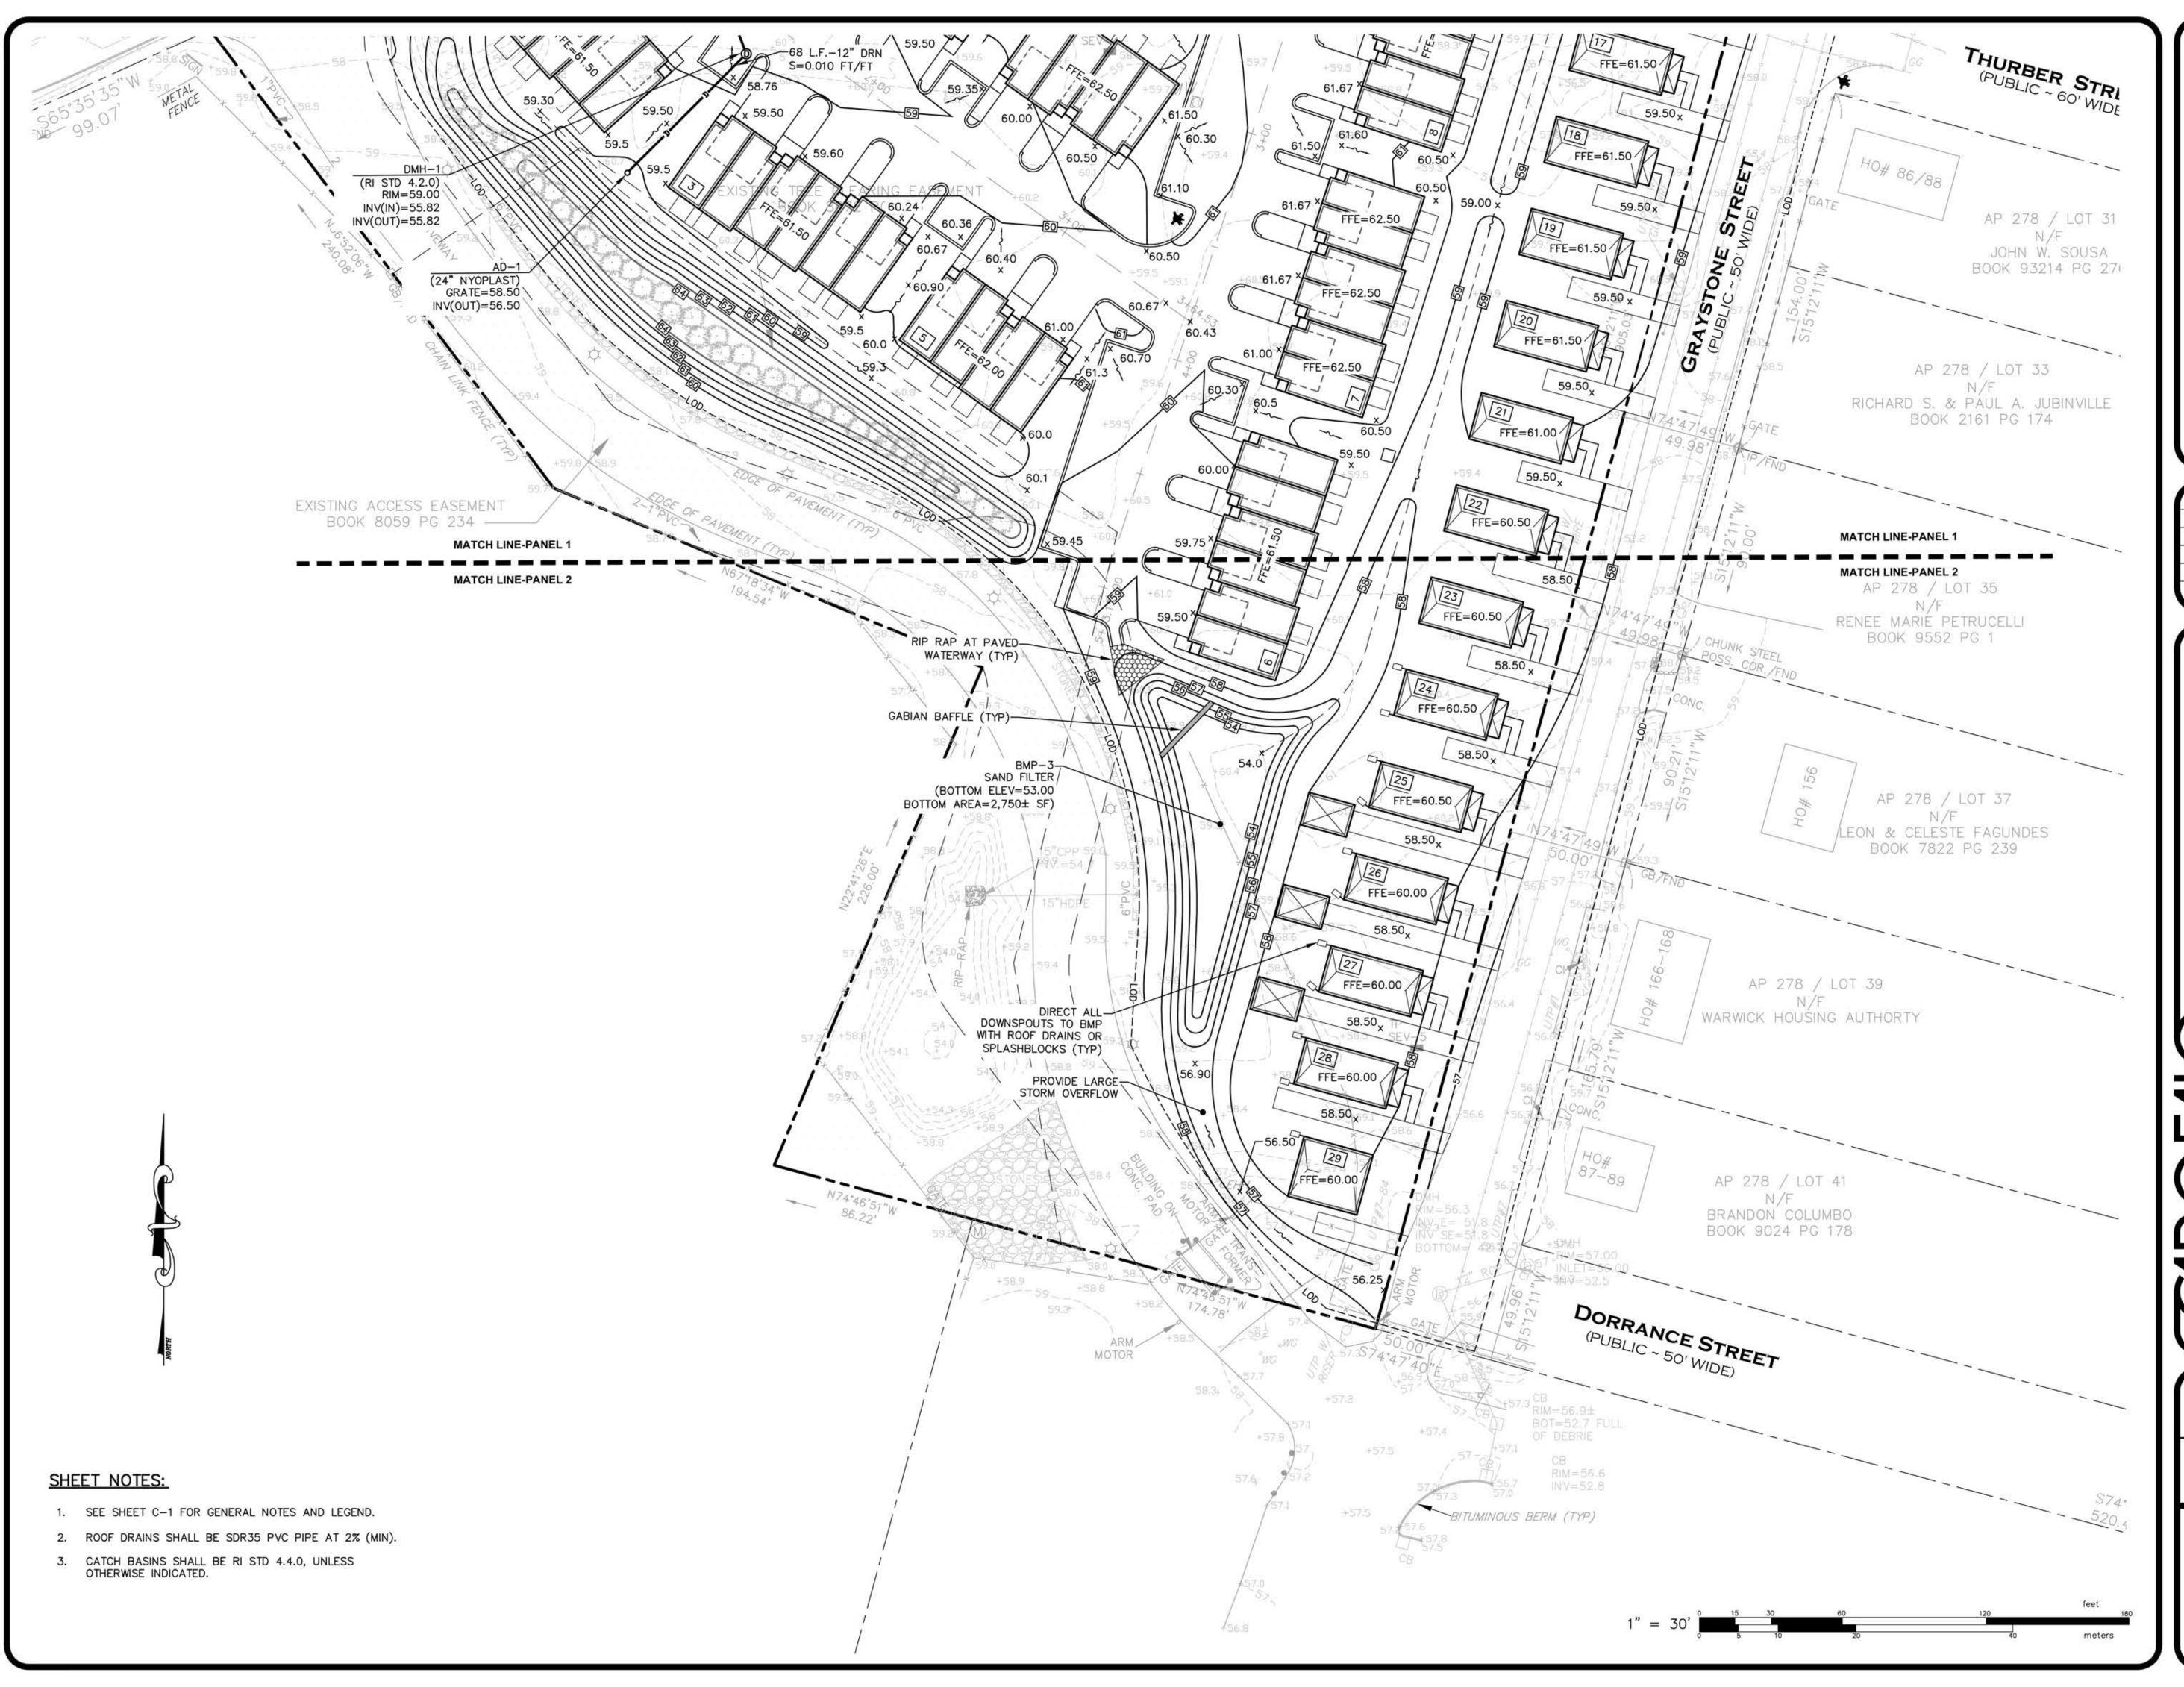

HILLSGROVE AT CITY CENTRE

STUATED AT

A.P. 278, LOT 144

298 KILVERT STREET

WARWICK, RI

PREPARED FOR

GREAT POINT GROUP, LLC

NO.	REVISION	BY	DATE
1	REV. PER PRELIMINARY	SSH	05/03/2021
2	PER CITY COMMENTS	KYY	05/27/2021

INC.
VEERSISURVEYORS
MENTAL SCIENTISTS

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P.O. BOX 6145
PROVIDENCE, R.I. 029
TEL. 401-273-6000

JOB NO.
7272-00
DWG. NO.
7272-00-Base.dwg

SCALE:
AS SHOWN

DRAWN BY R.A.S.

CHECK BY S.S.H.


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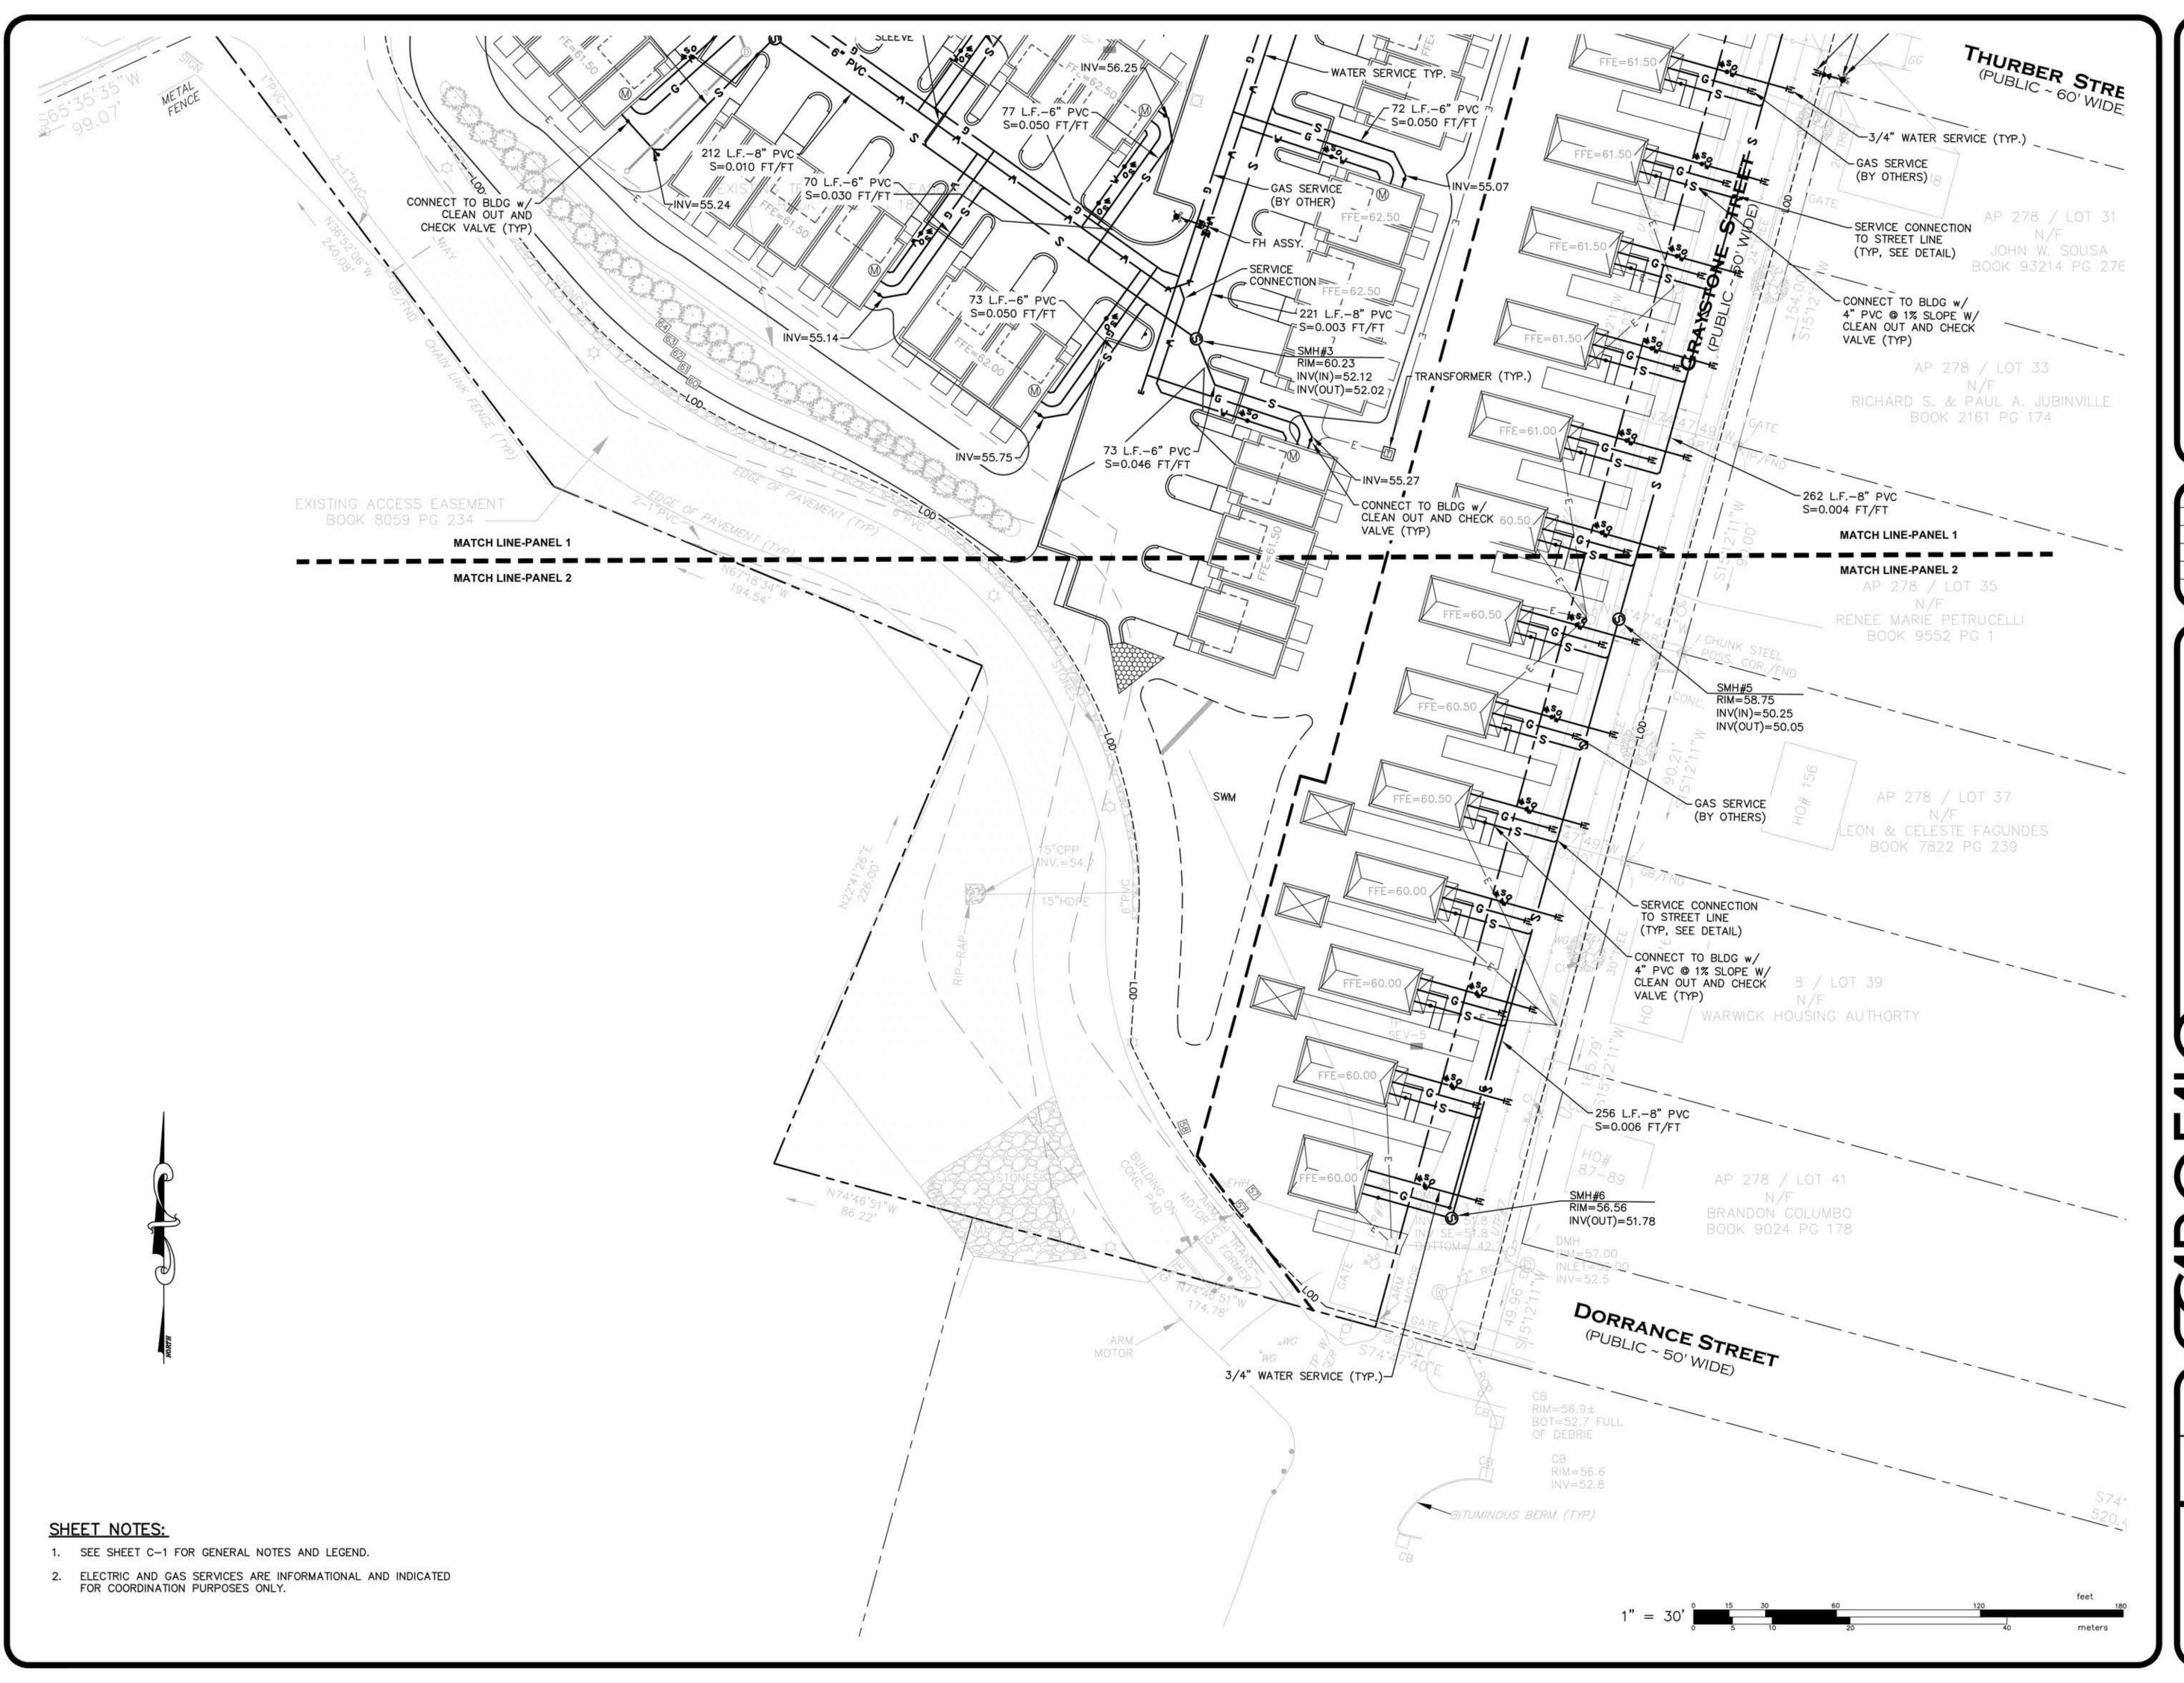
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JANUARY 26, 2021

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RI N.P. 278, LOT KILVERT ST WARWICK, SGROVE


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1	REV. PER PRELIMINARY	SSH	05/03/2021
2	PER CITY COMMENTS	KYY	05/27/2021

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CHECK BY S.S.H. APPROVED S.B.G. DATE: JANUARY 26, 2021

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REVISION

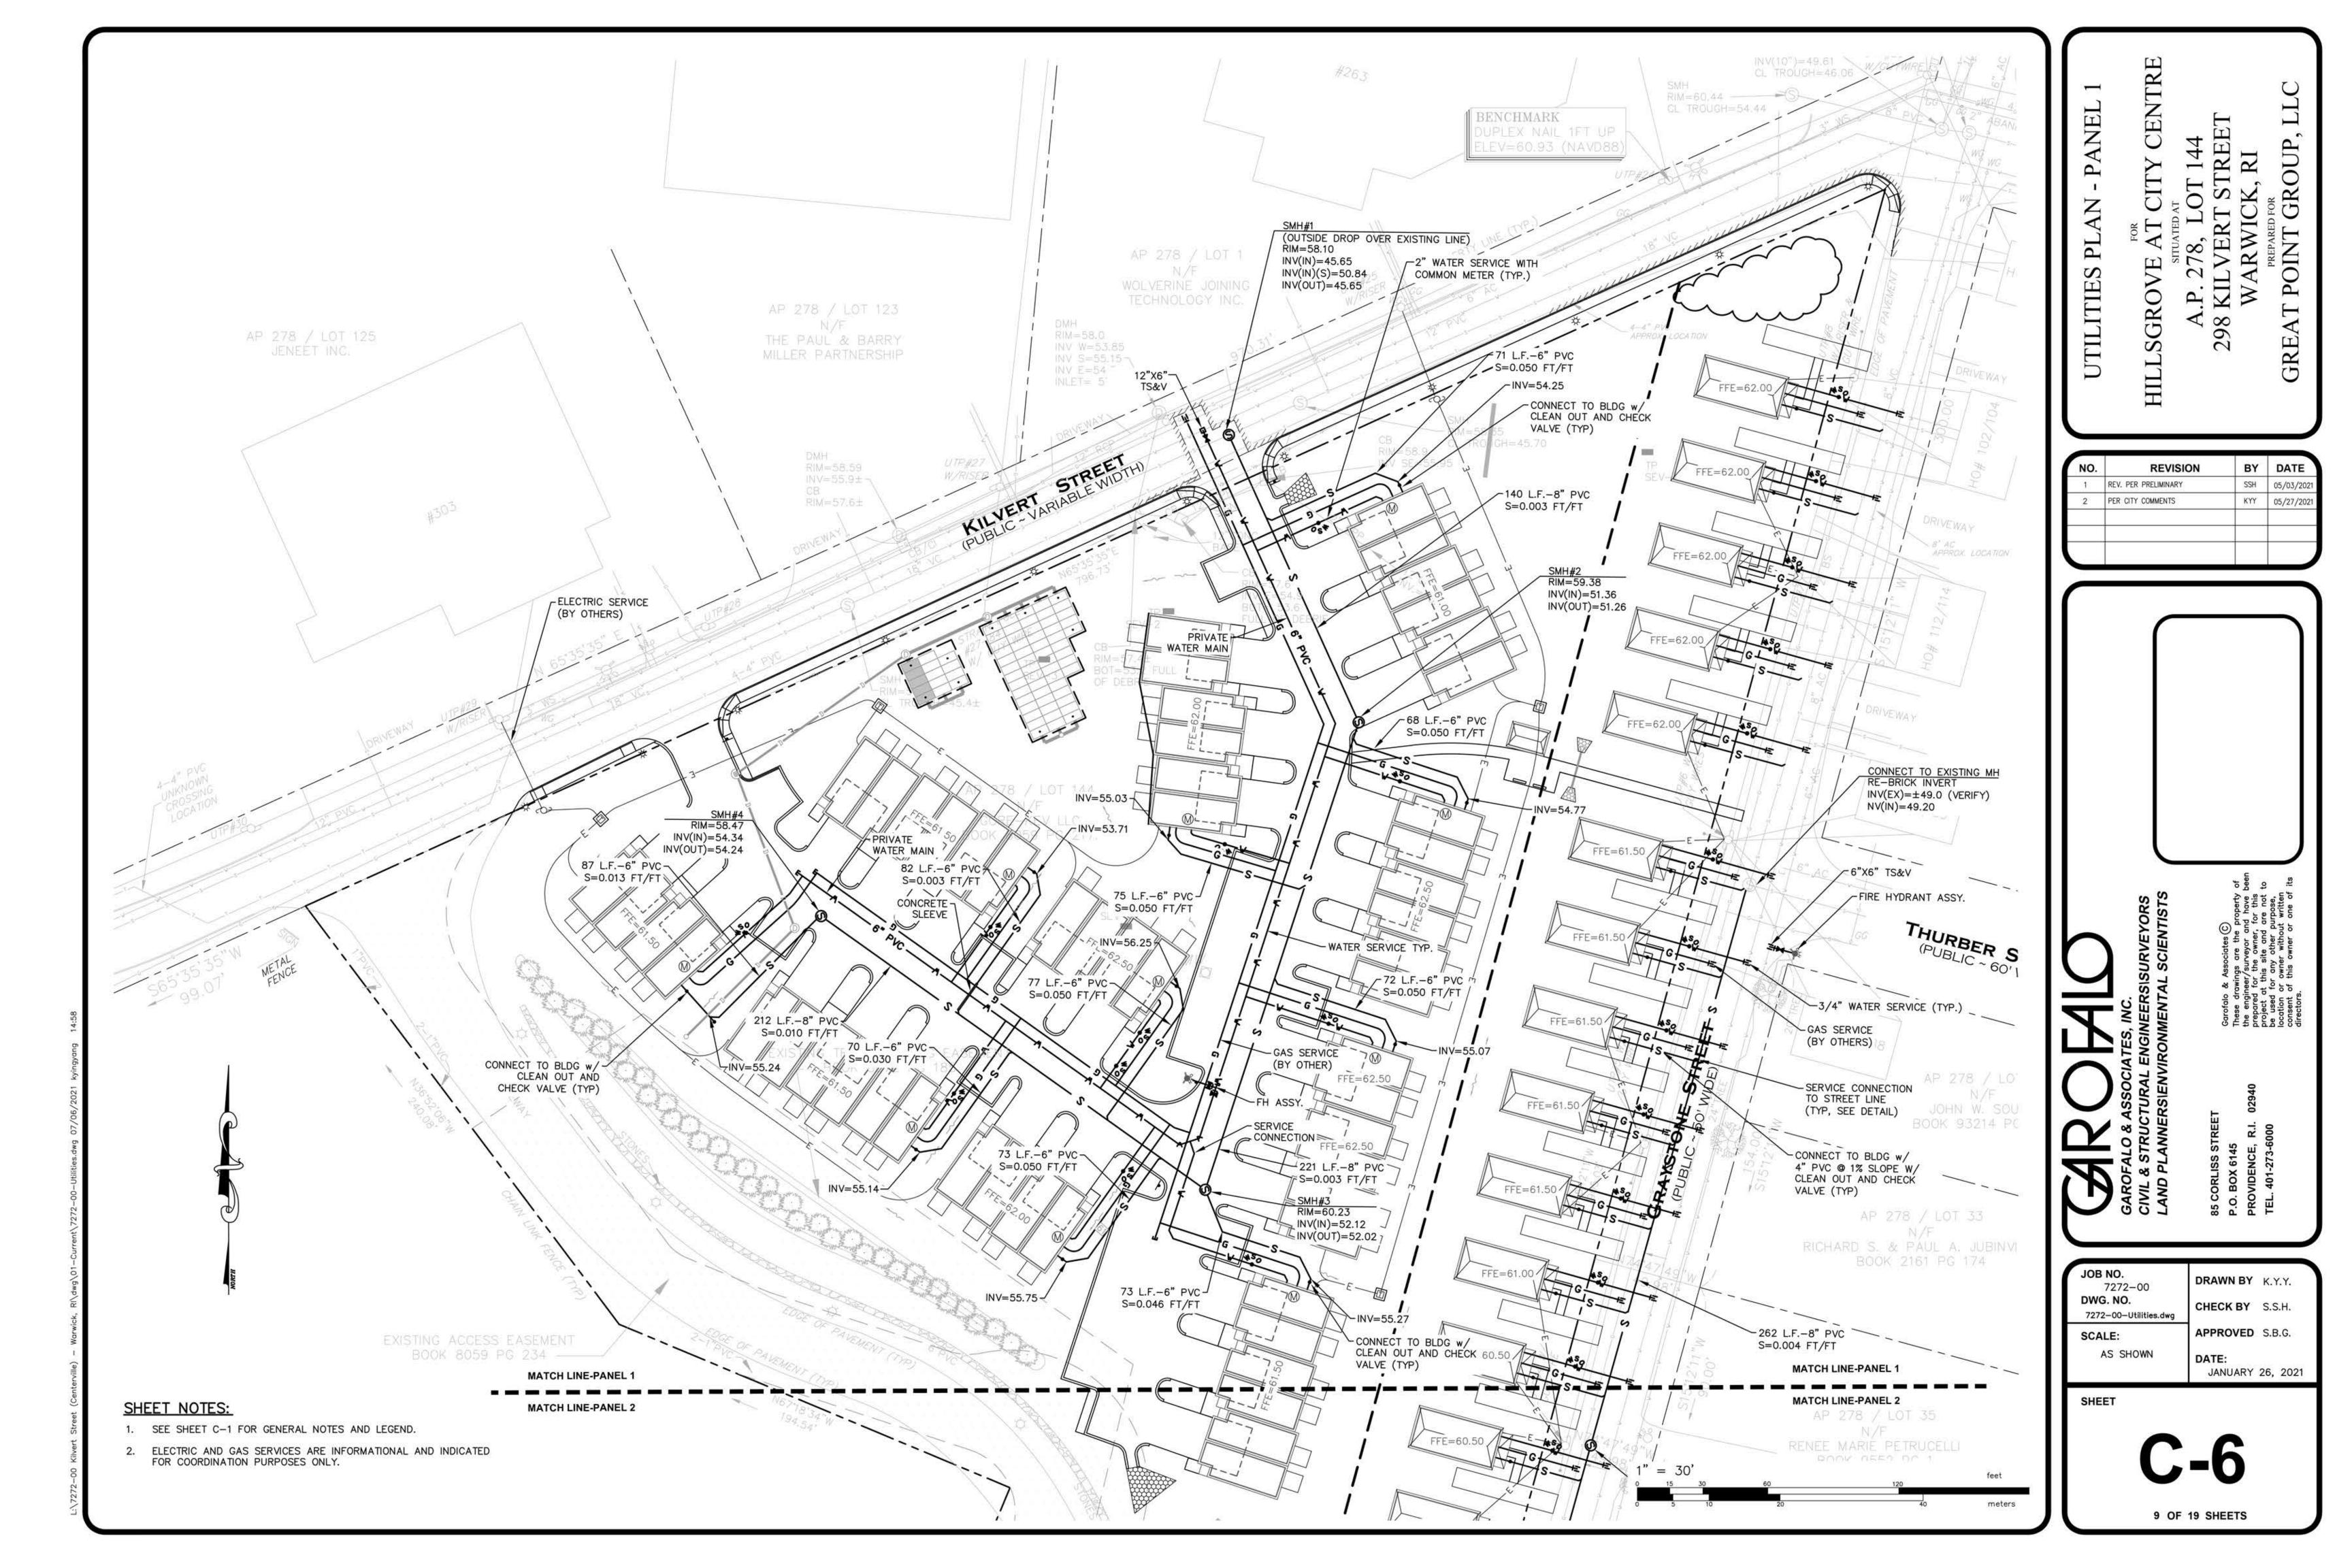REV. PER PRELIMINARY

PER CITY COMMENTS
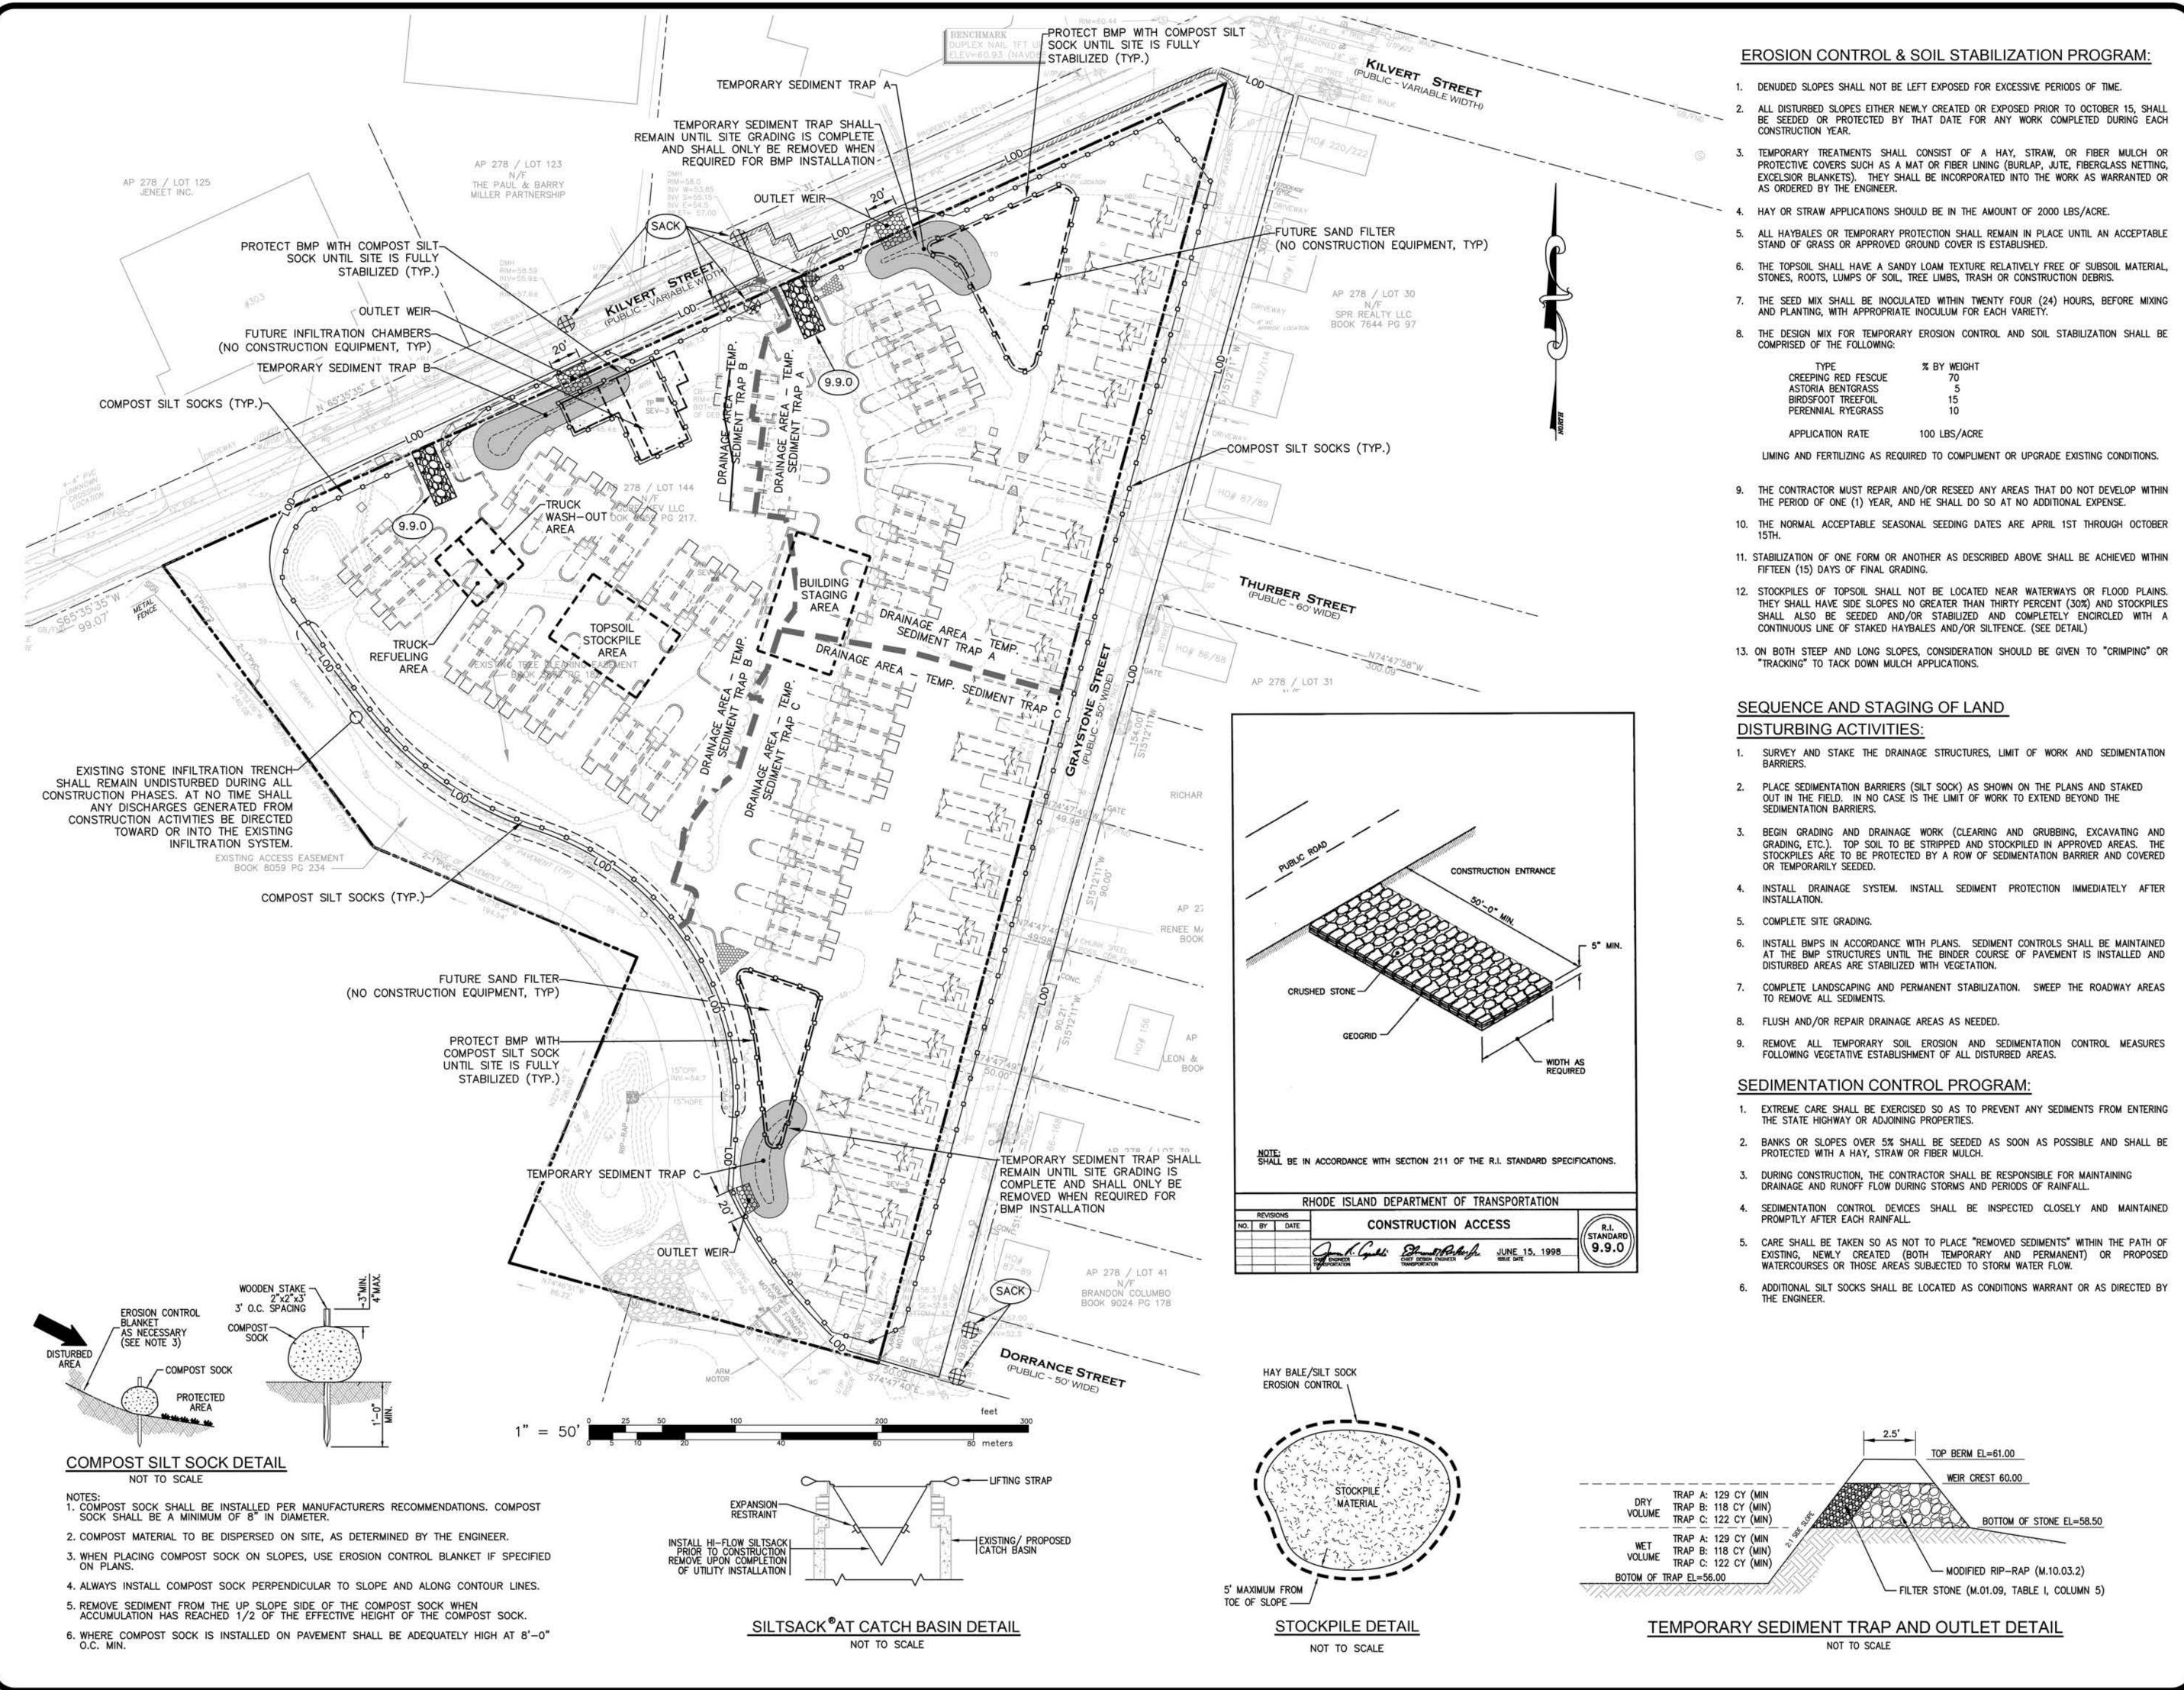
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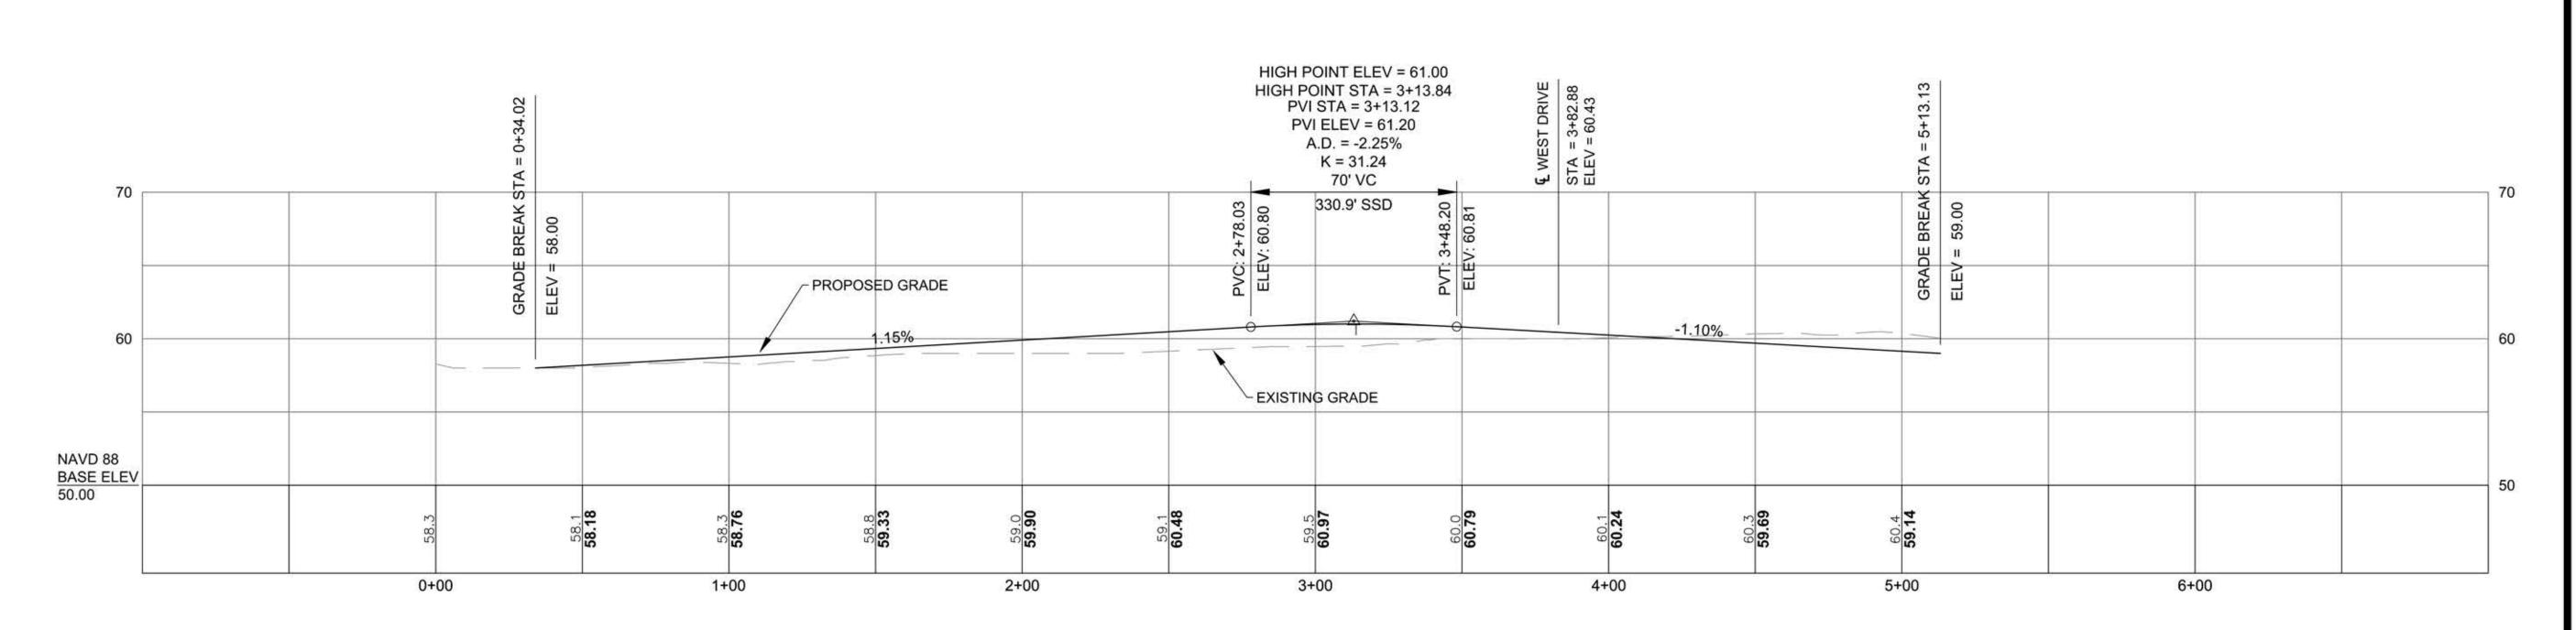
BY DATE

KYY 05/27/202


JANUARY 26, 2021

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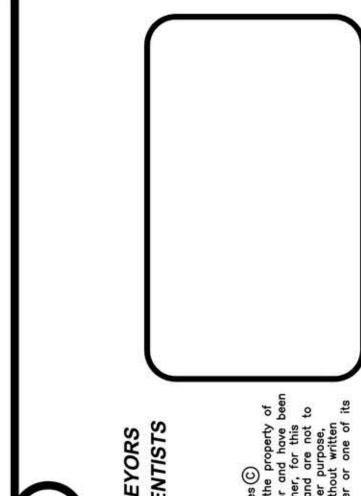


EAST DRIVE



WEST DRIVE

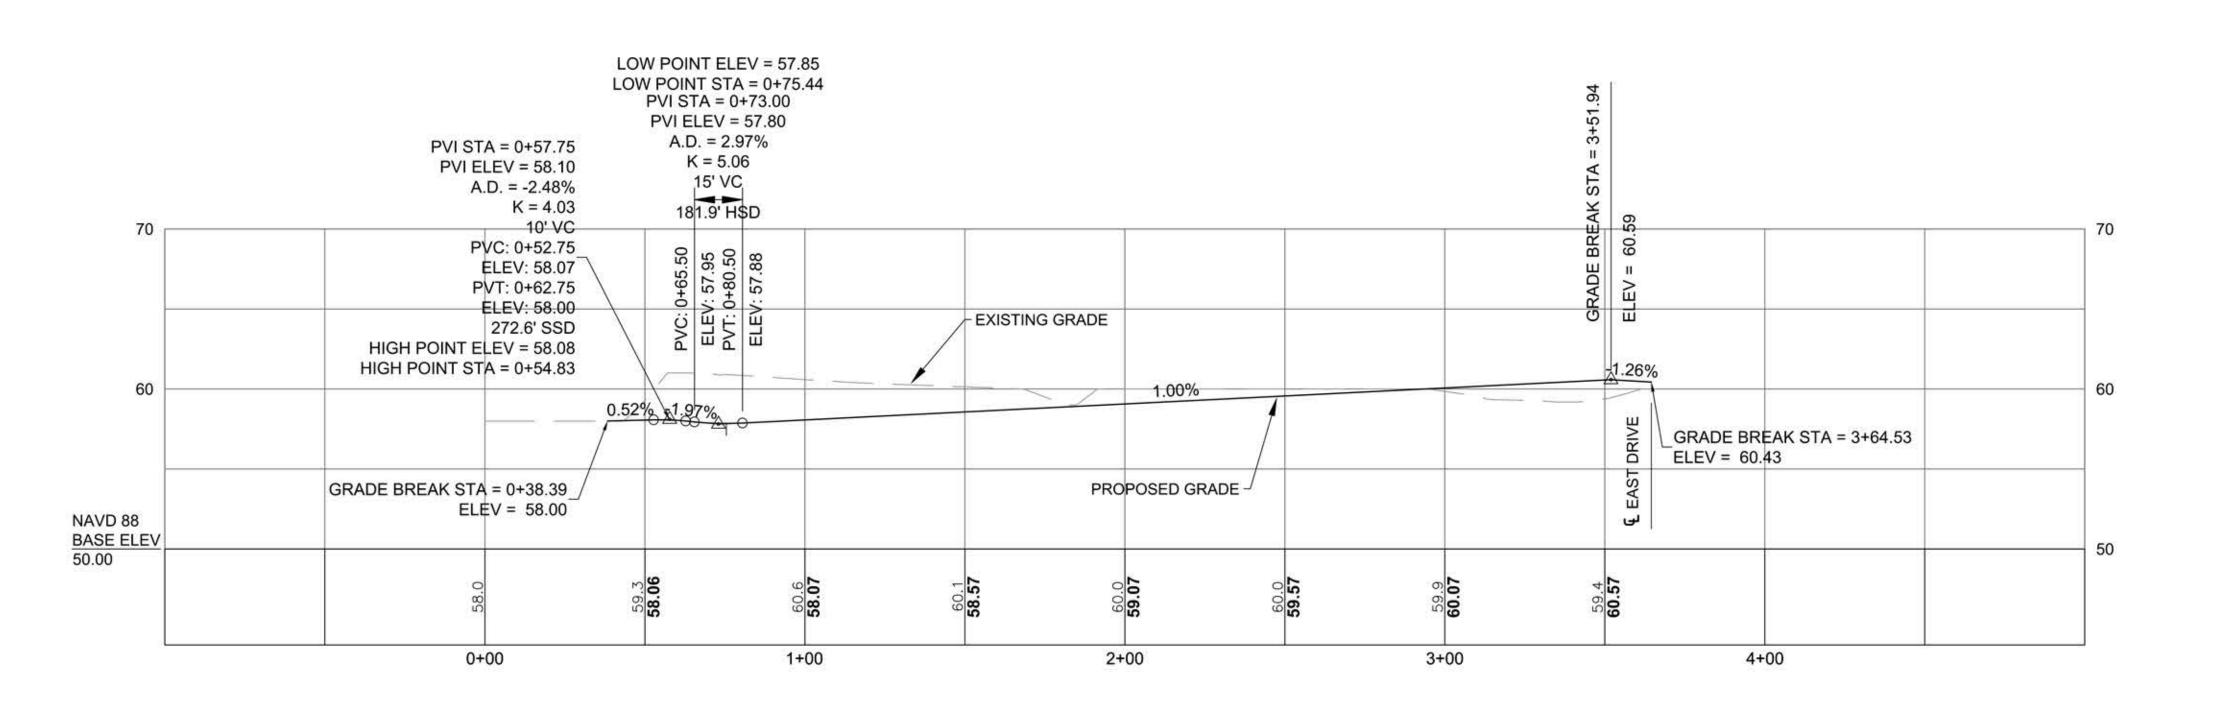
REVISION	BY	DATE
REV. PER PRELIMINARY	SSH	05/03/2021
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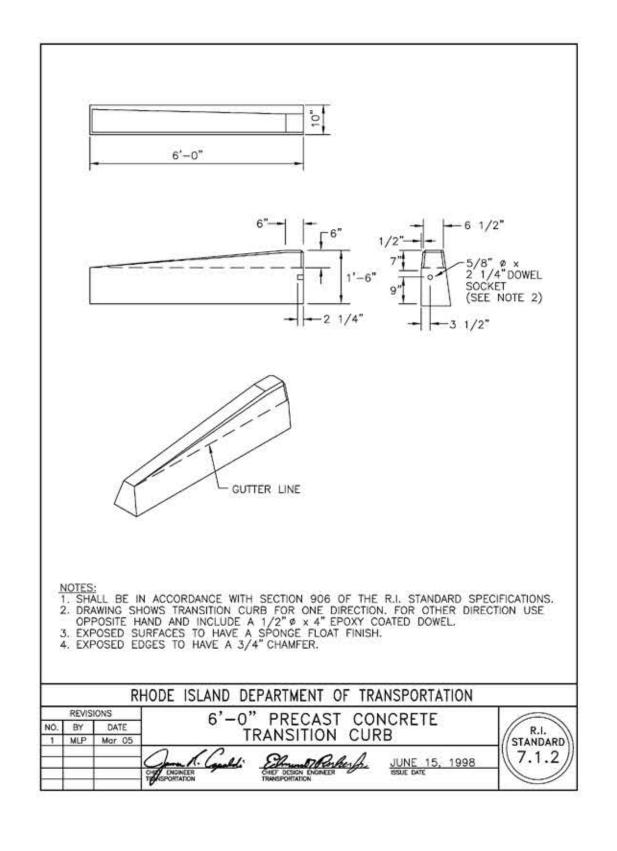



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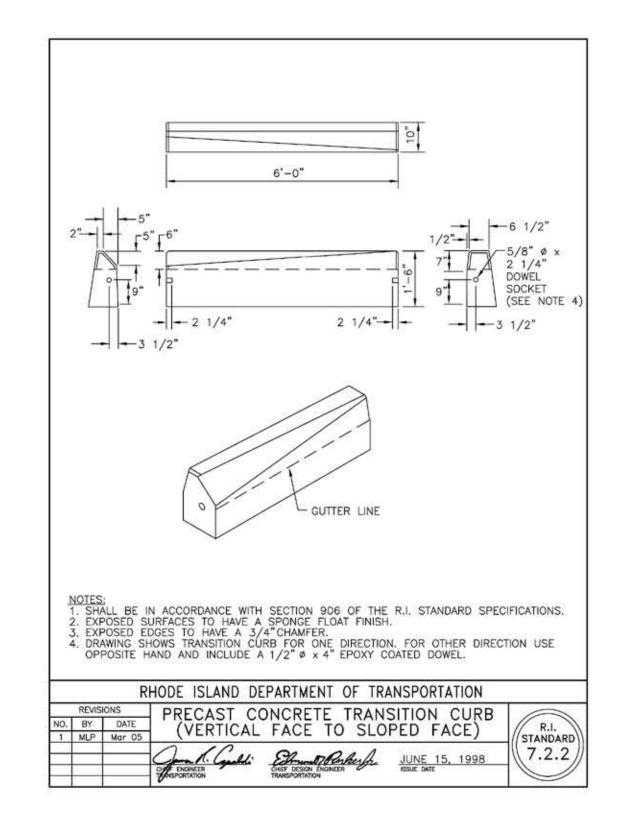
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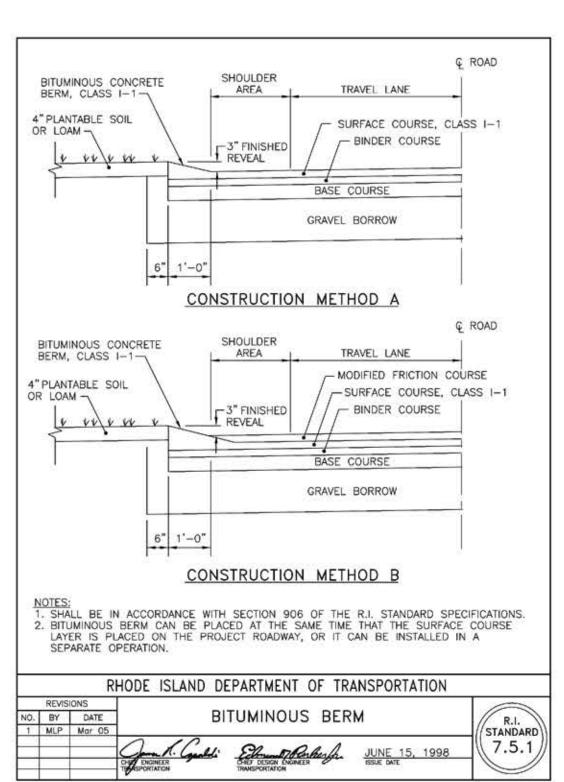
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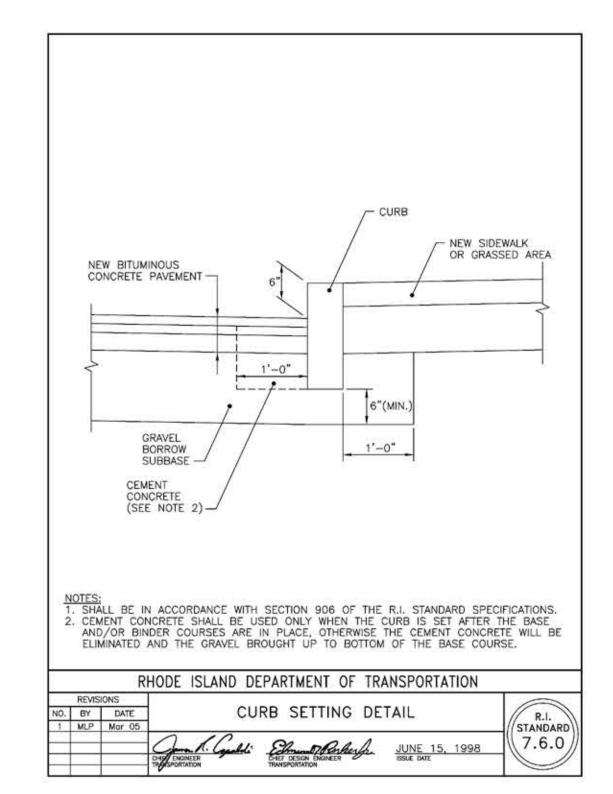











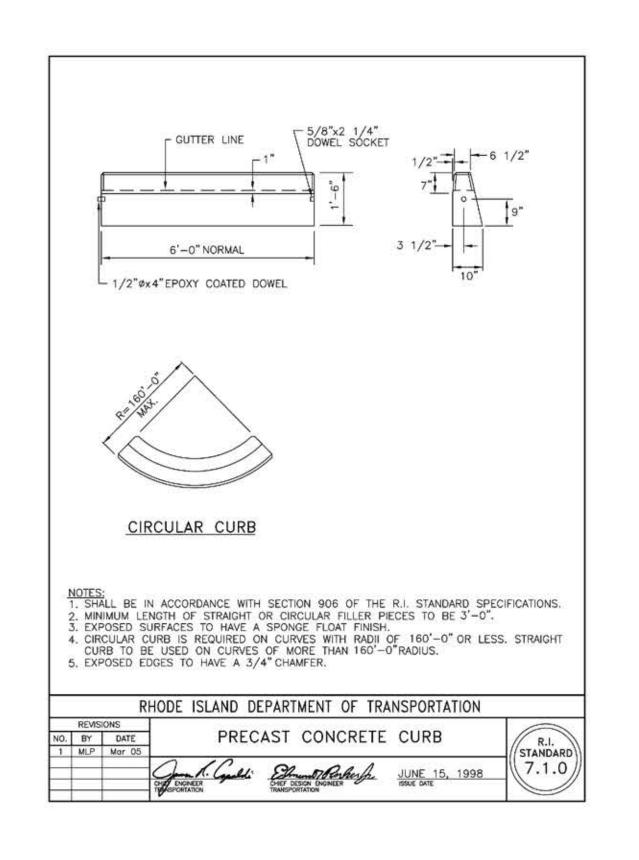

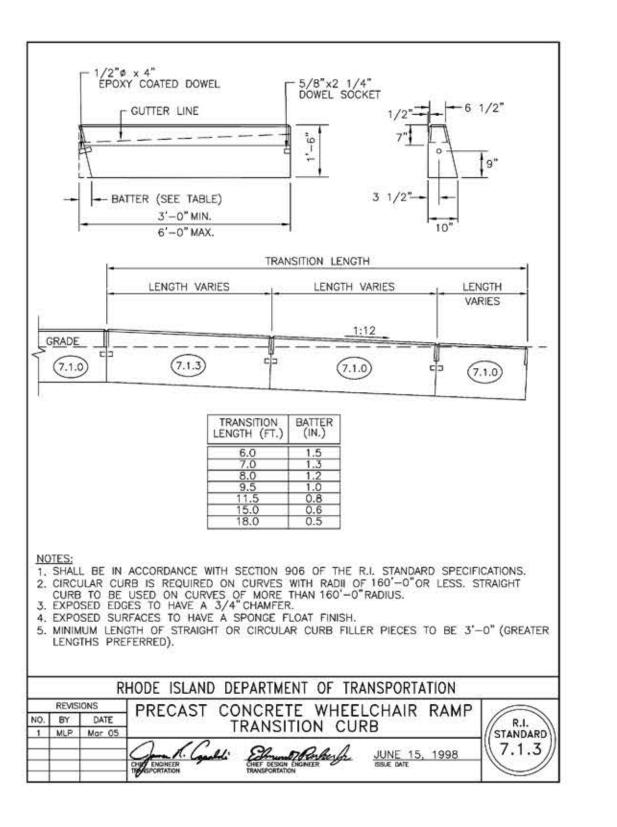

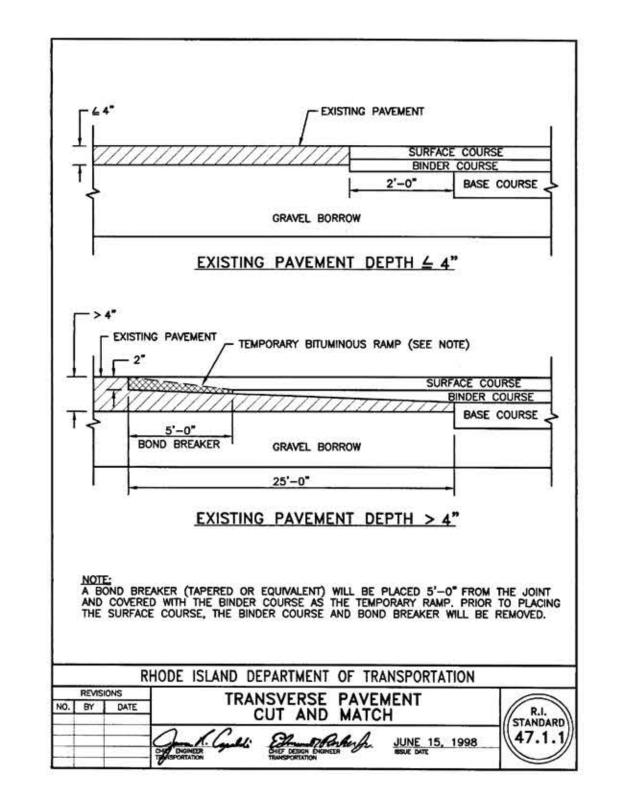

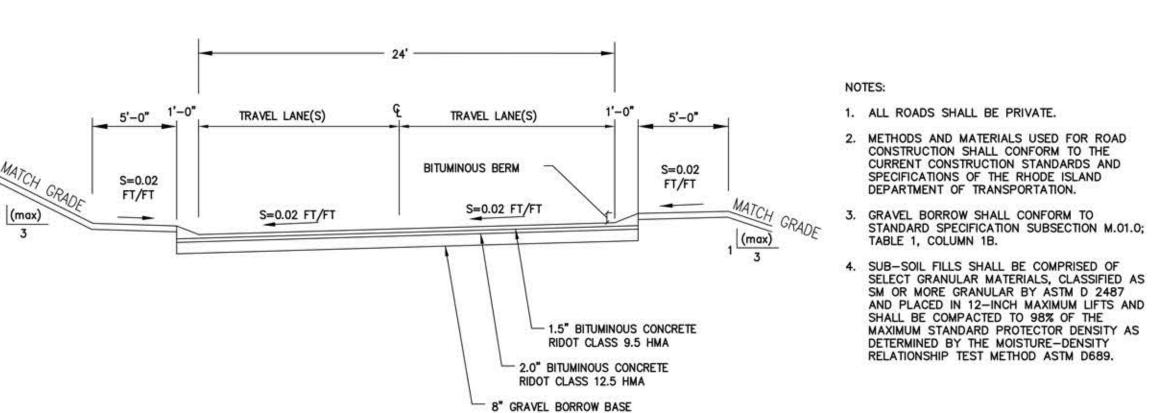

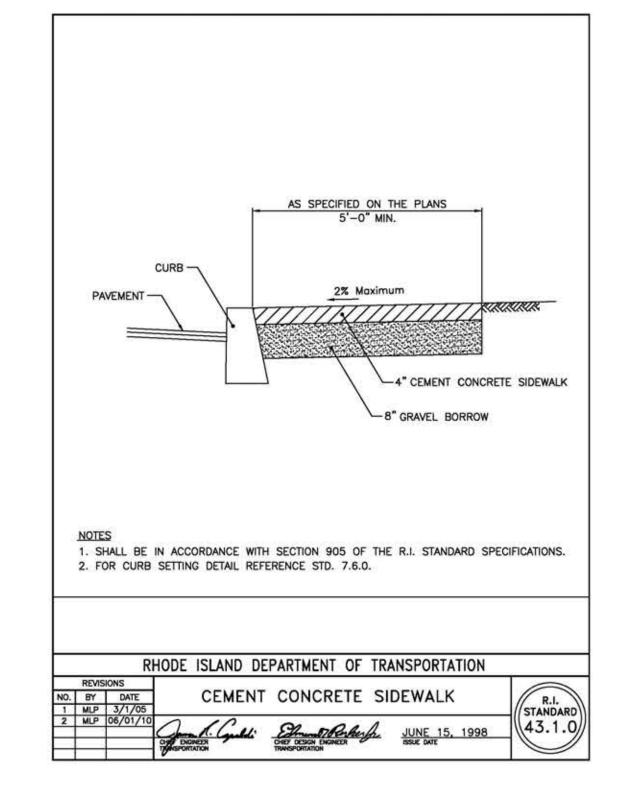




SIGNAGE

NOT TO SCALE

NOTES:

1. SIGN INSTALLATIONS SHALL BE IN ACCORDANCE WITH RI STD 24.2.0.

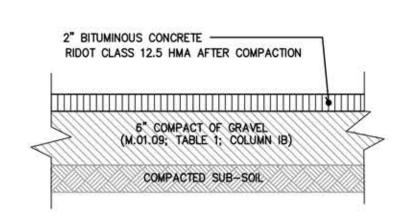

BITUMINOUS CONCRETE DRIVEWAYS

NOT TO SCALE

ROAD TYPICAL SECTION

NOT TO SCALE

JOB NO.
7272-00
DWG. NO.
7272-00-Details.dwg
SCALE:
AS SHOWN
SHEET

2000 - 10

C-9

DATE:

DRAWN BY K.Y.Y.

CHECK BY S.S.H.

APPROVED S.B.G.

JANUARY 26, 2021

13 OF 19 SHEETS

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REVISION

REV. PER PRELIMINARY

PER CITY COMMENTS

STREE


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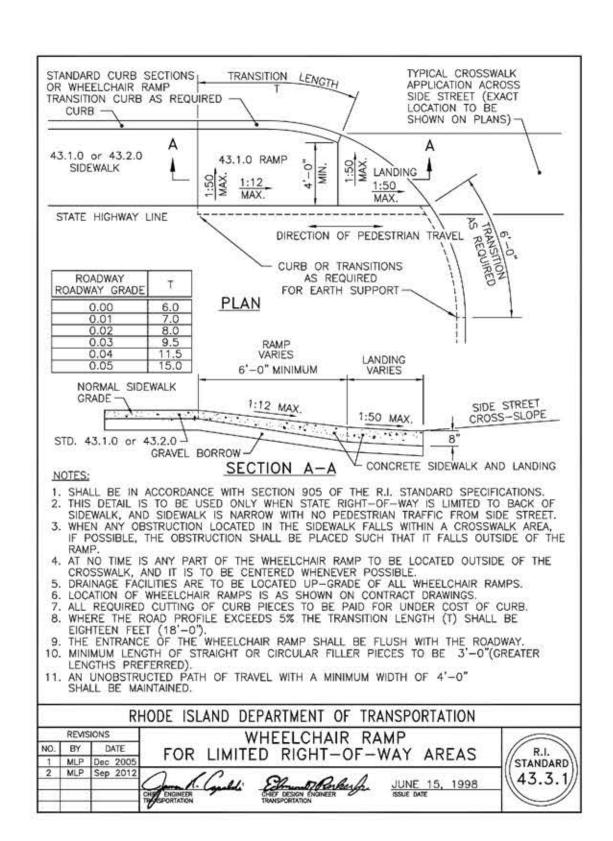
BY DATE


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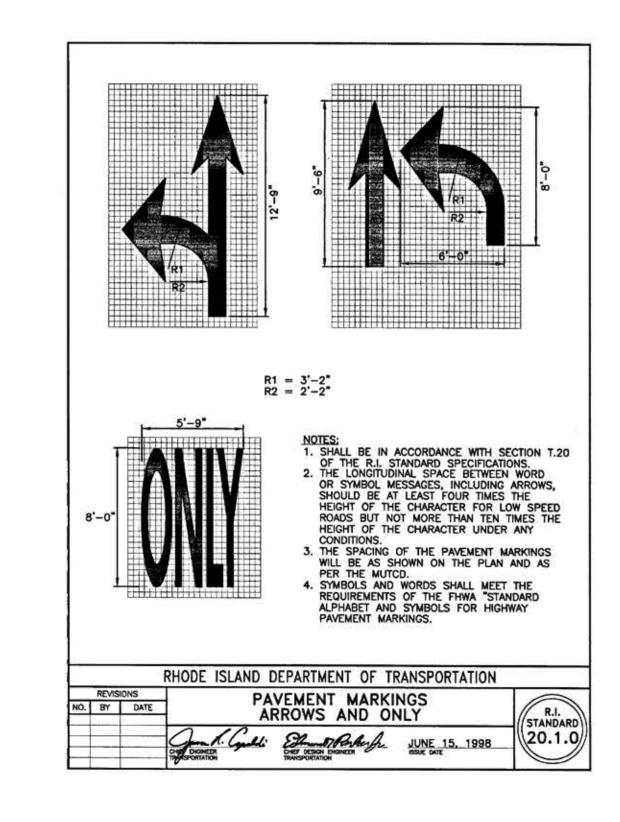
KYY 06/08/202


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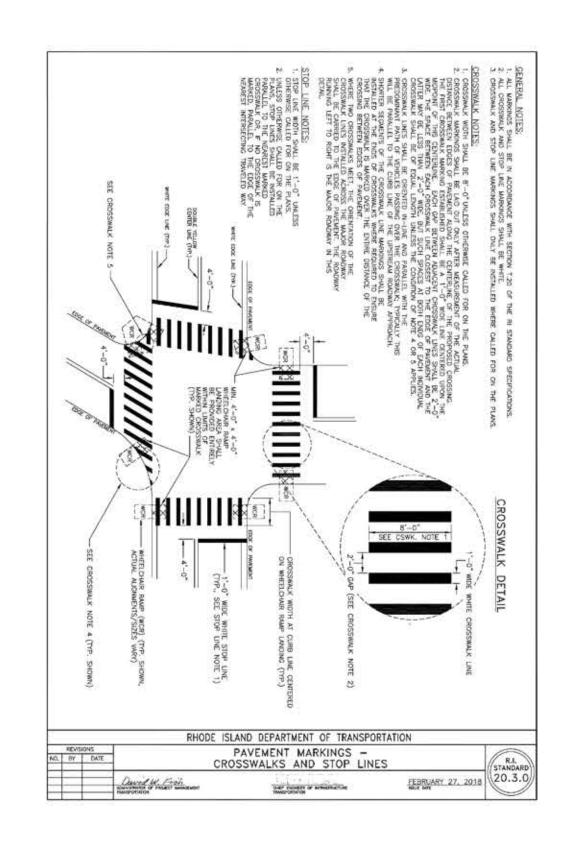







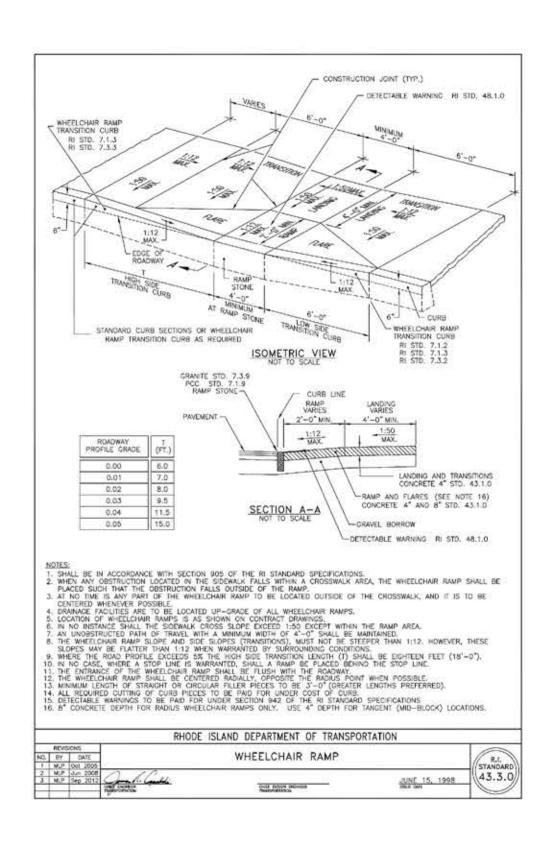

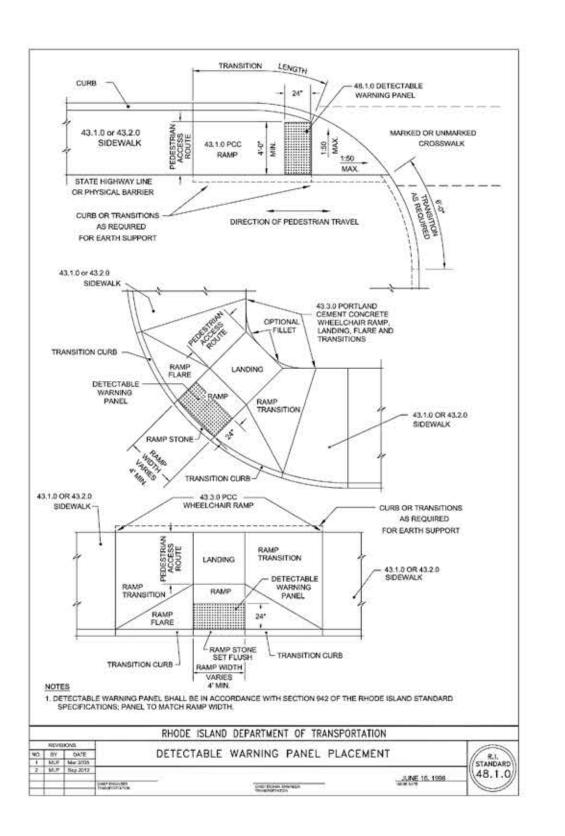


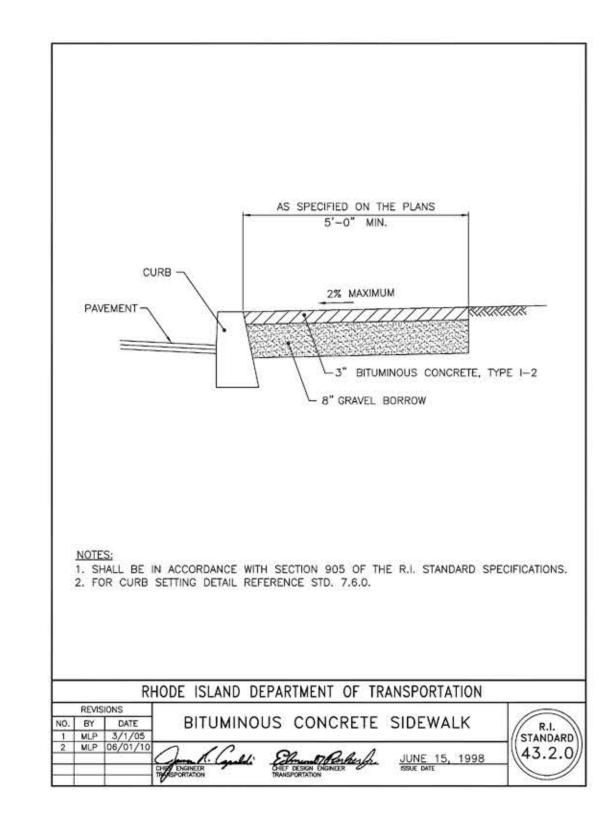

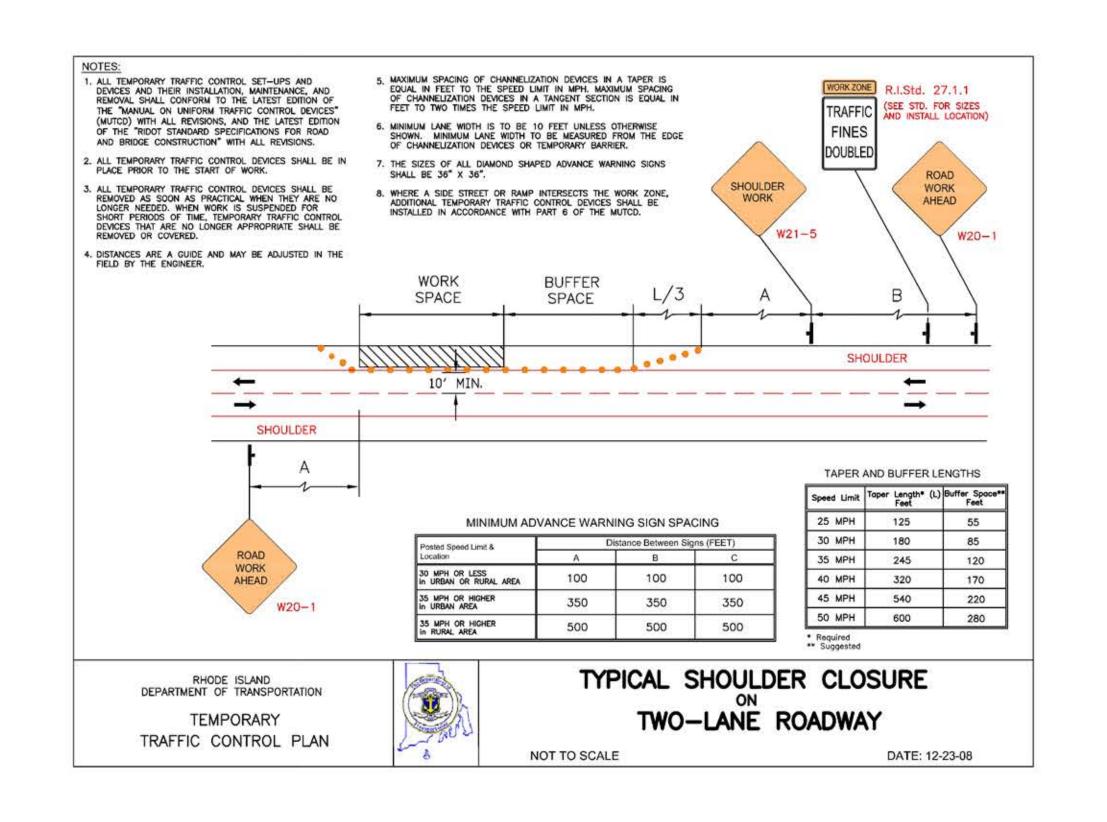

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NO.	REVISION	BY	DATE
1	REV. PER PRELIMINARY	SSH	05/03/2021
2	PER CITY COMMENTS	KYY	05/27/2021
3ь	PER CITY COMMENTS	KYY	06/08/2021

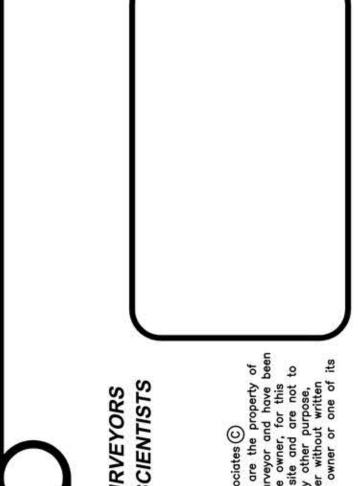



JANUARY 26, 2021

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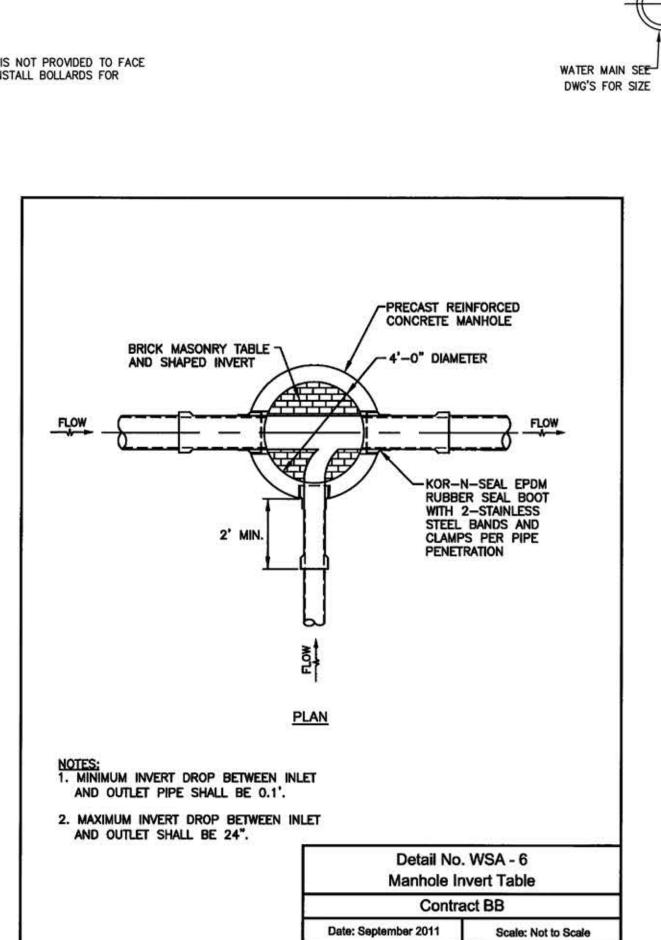
APPROVED S.B.G. SCALE: AS SHOWN DATE:


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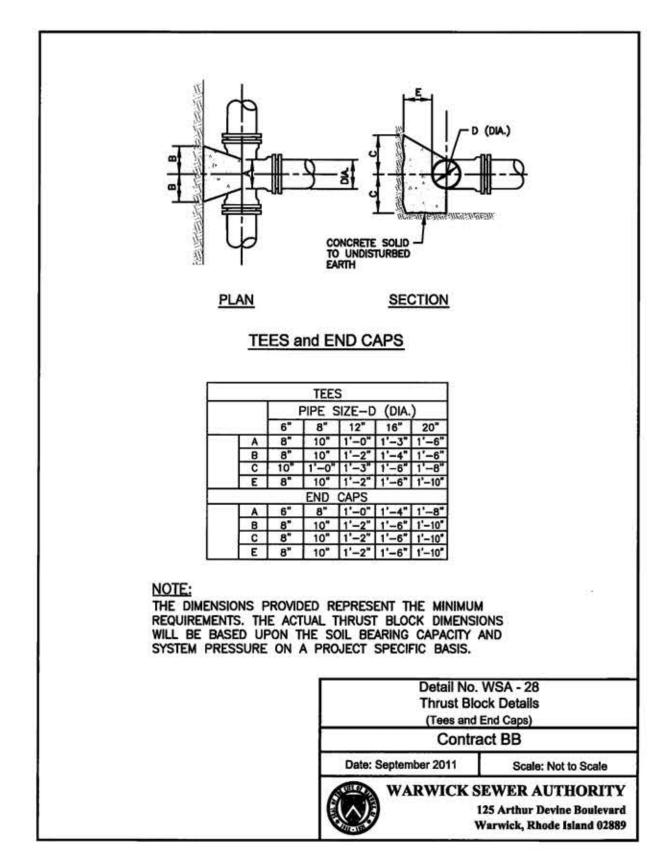



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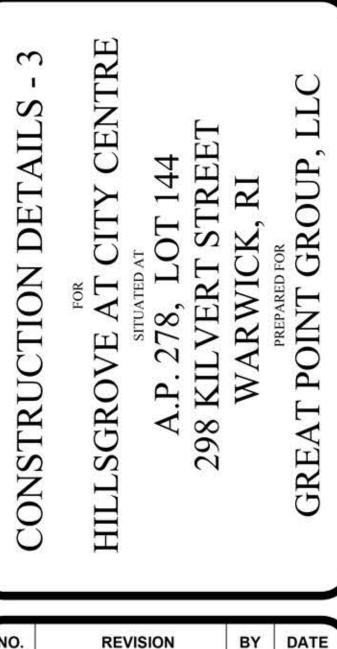


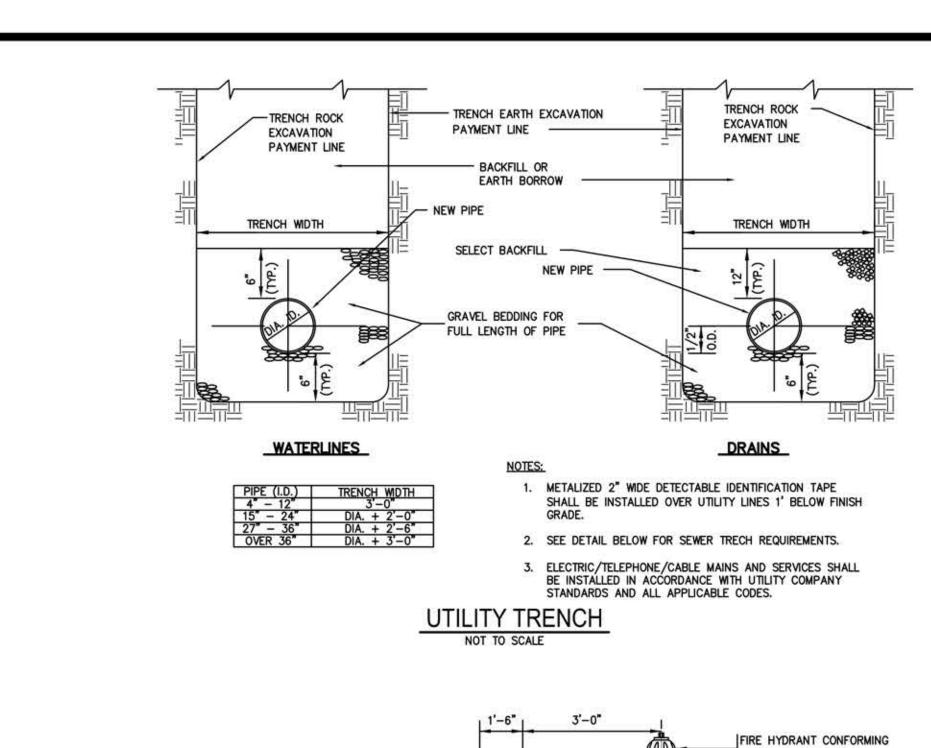


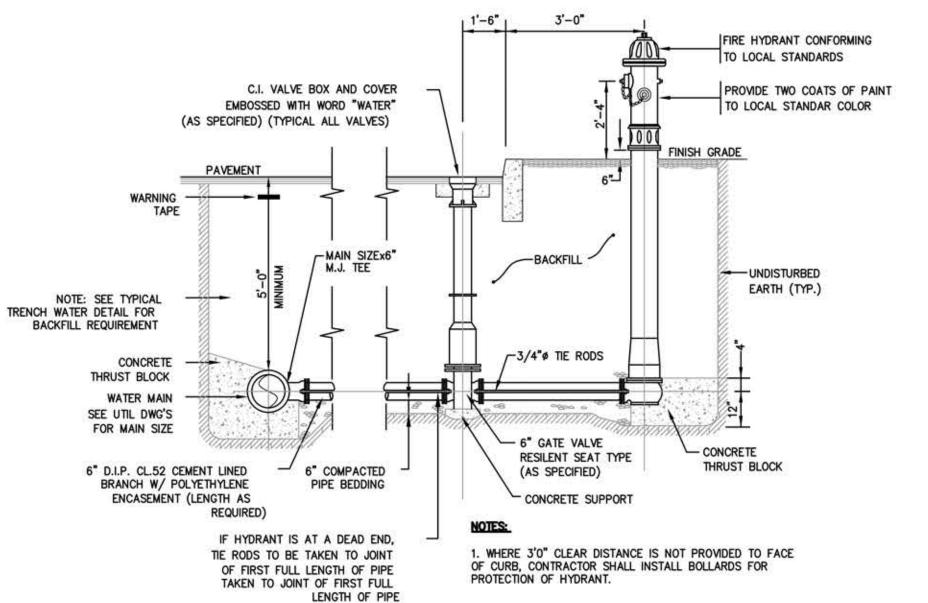RELOCATED WATER LINE



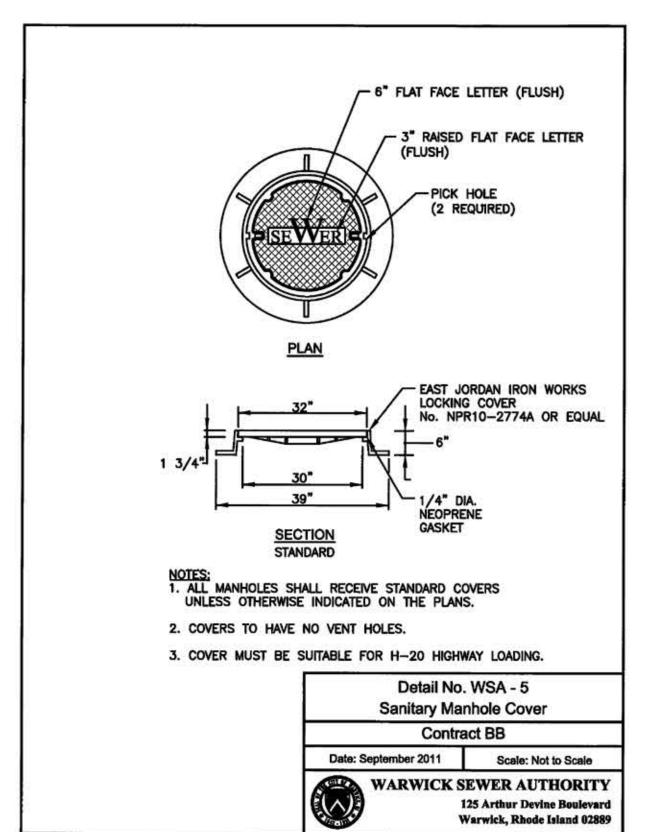

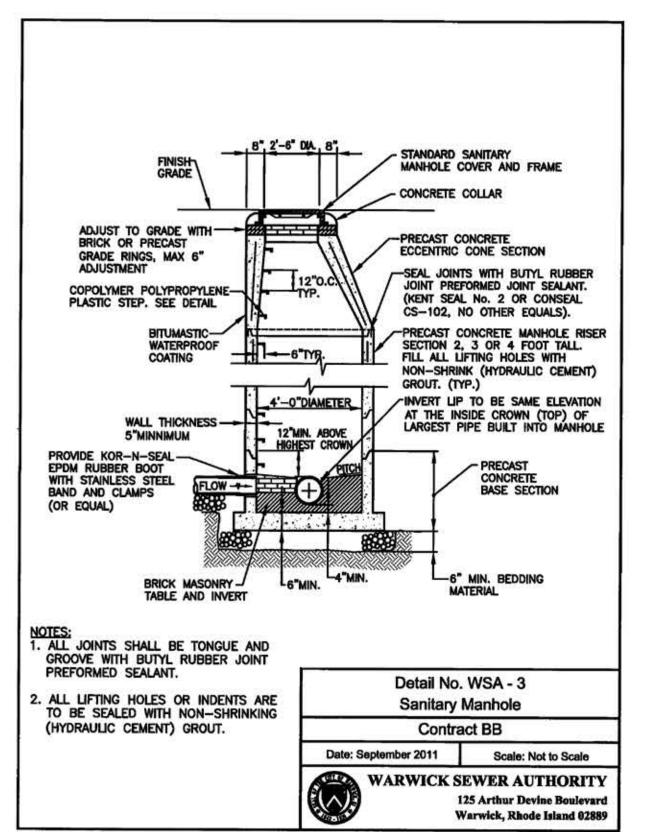

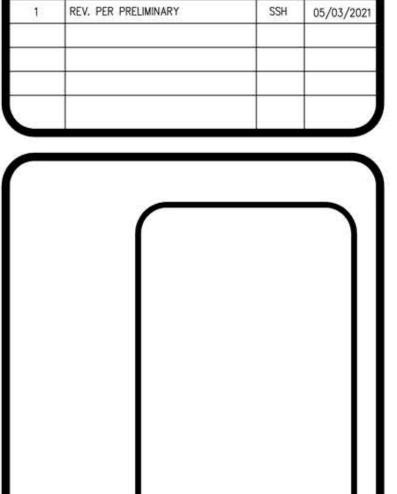



JANUARY 26, 2021

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SHEET

15 OF 19 SHEETS



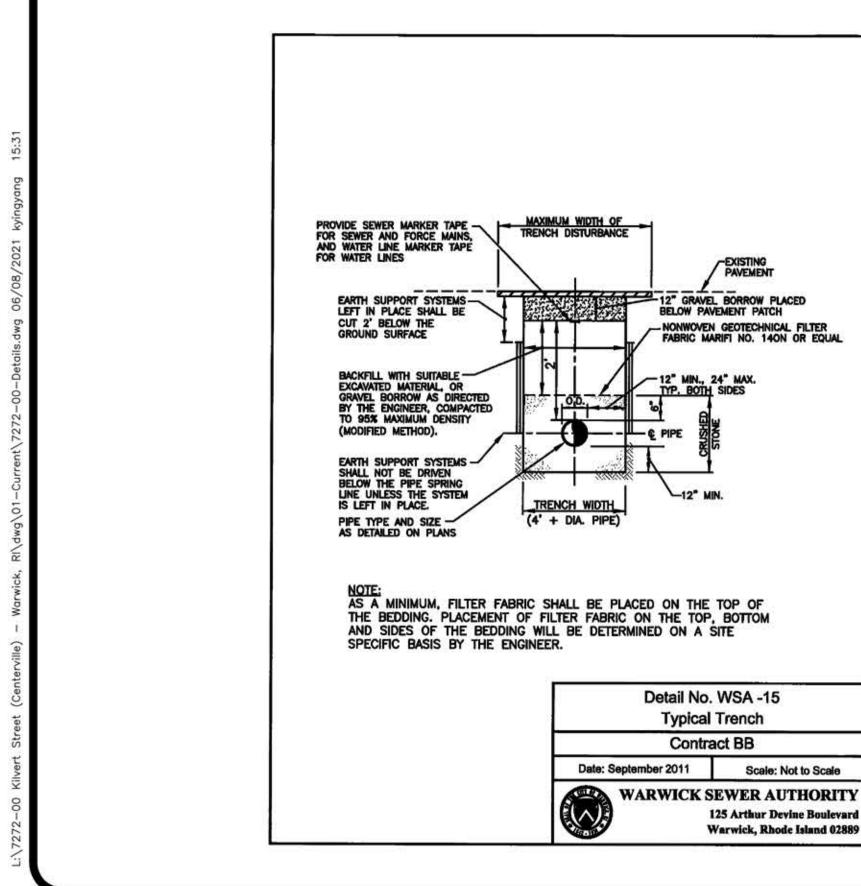

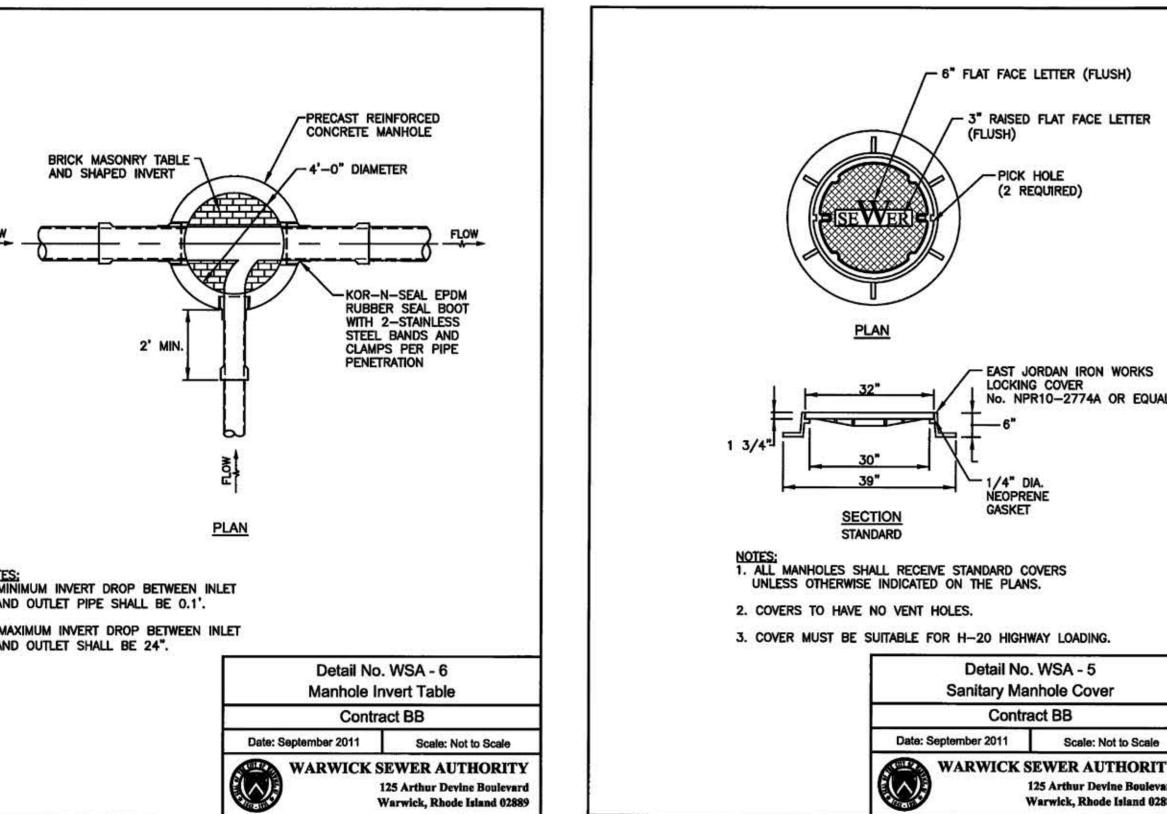CONCRETE

GRAVEL BEDDING

ELEVATION VIEW

FORCE MAIN OR GRAVITY SEWER

CONCRETE

BEDDING

SECTION

5'-0" MIN

BRASS PLUG

LOCKING CAST IRON

COVER CONFORMING

TO LOCAL STANDARDS

TRENCH WIDTH ---

CONCRETE SLEEVE

NOT TO SCALE

FINISH GRADE

SERVICE BOX COVER CONFORMING TO LOCAL

STAINLESS STEEL

CAST IRON

1" HDPE TUBING

SERVICE BOX

- CORPORATION STOP

WATER SERVICE

NOT TO SCALE


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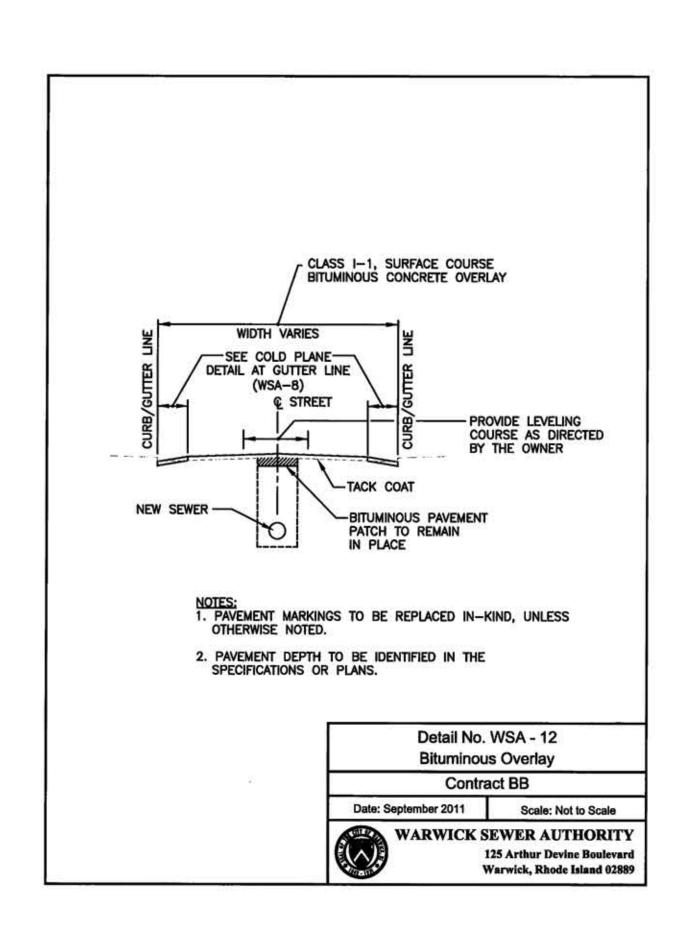
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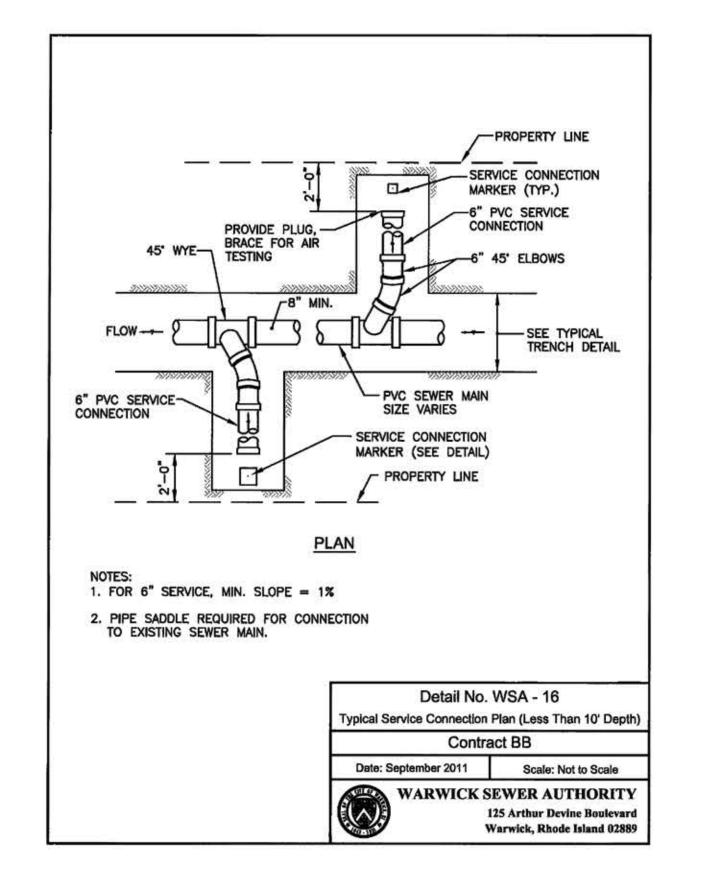
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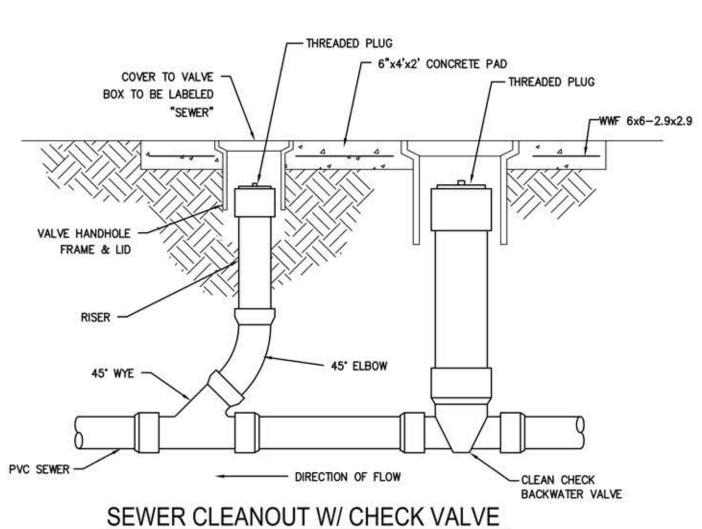
STANDARDS

FORCE MAIN OR








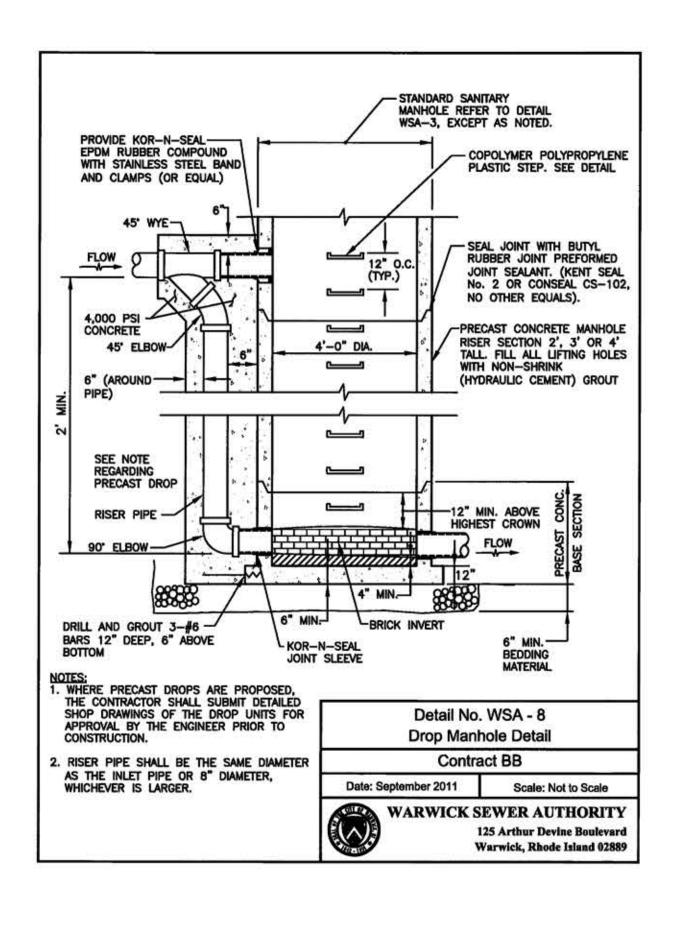

NOT TO SCALE

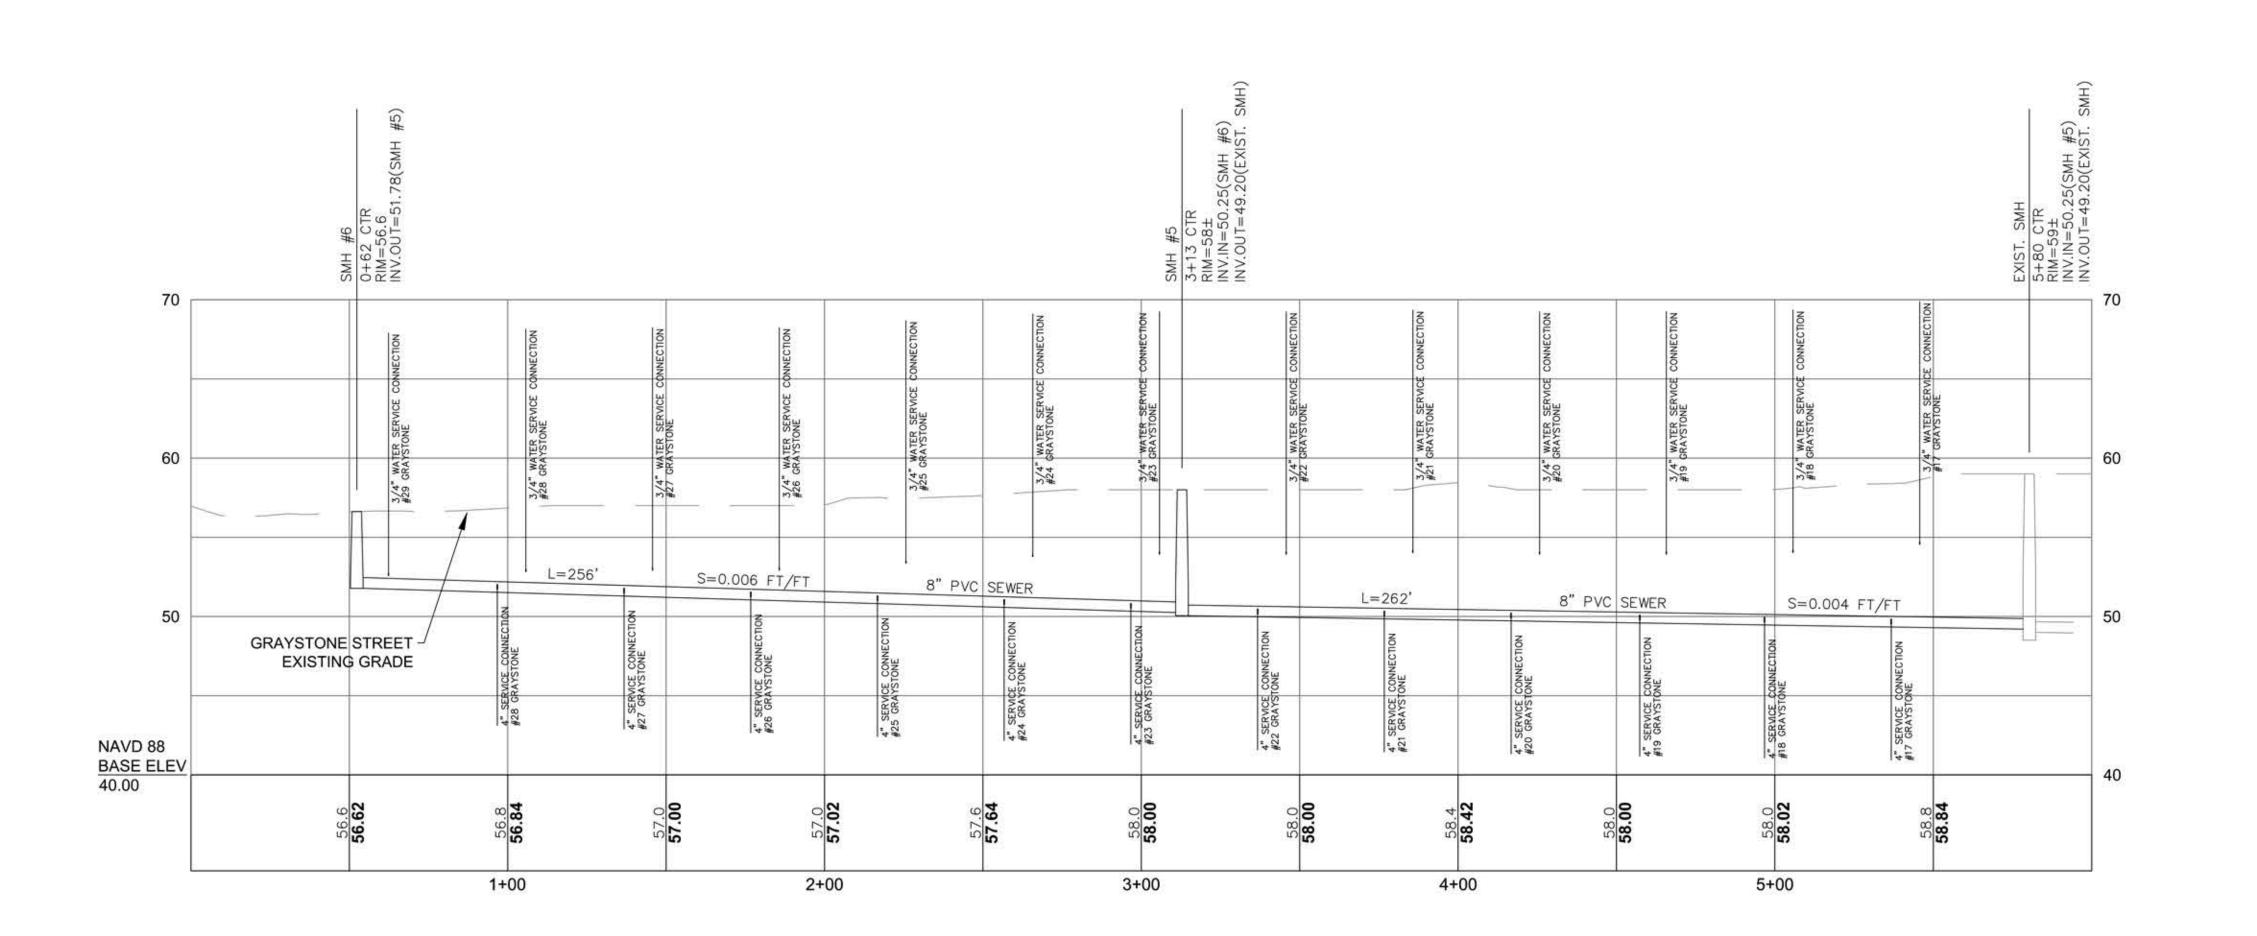

CONSTRUCTION DETAILS - 4

FOR STRUCTS - 4

HILLSGROVE AT CITY CENTRE

STRUCTS AT CITY CENTRE

A.P. 278, LOT 144

298 KILVERT STREET

WARWICK, RI

PREPARED FOR

CAP FAT DOINT GROUP II C

10.	REVISION	BY	DATE
1	REV. PER PRELIMINARY	SSH	05/03/202

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401-273-6000

JANUARY 26, 2021

JOB NO.
7272-00
DWG. NO.
7272-00-Details.dwg

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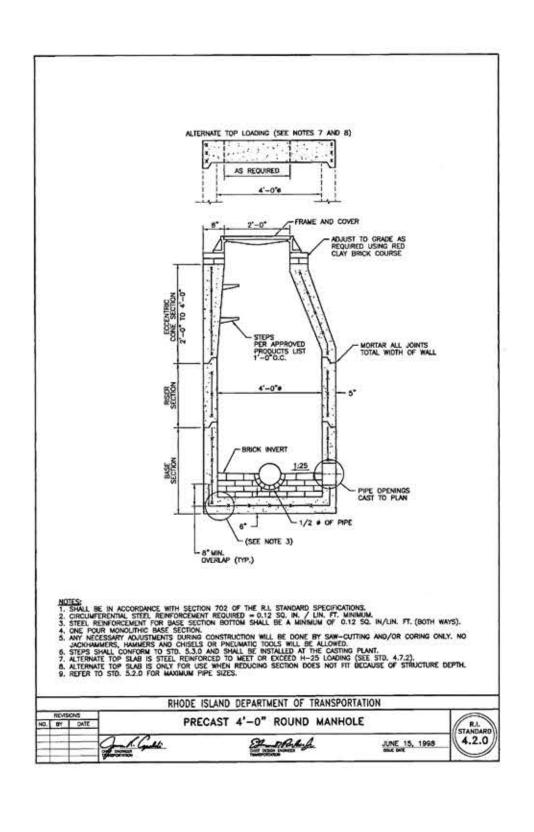
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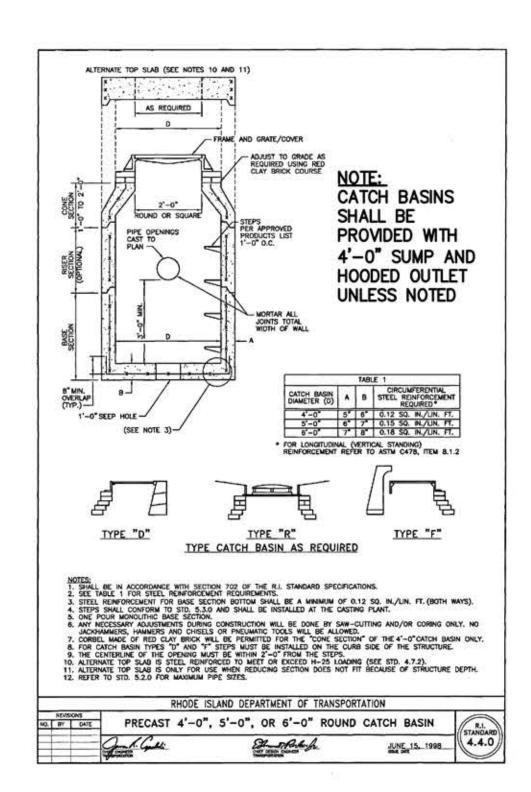
APPROVED S.B.G.


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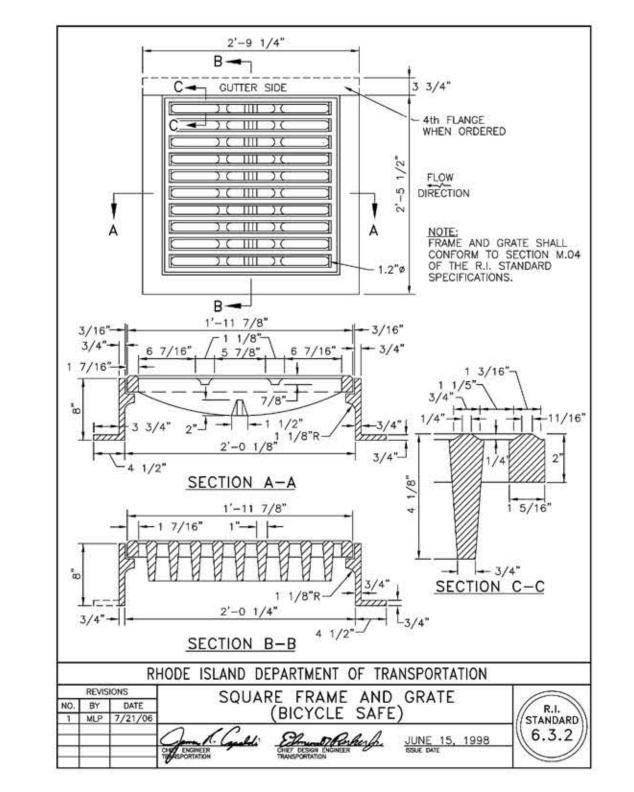
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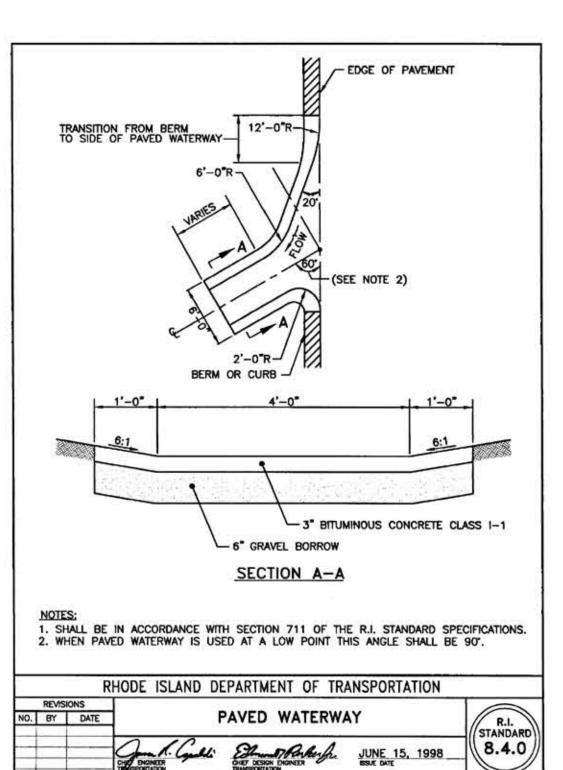
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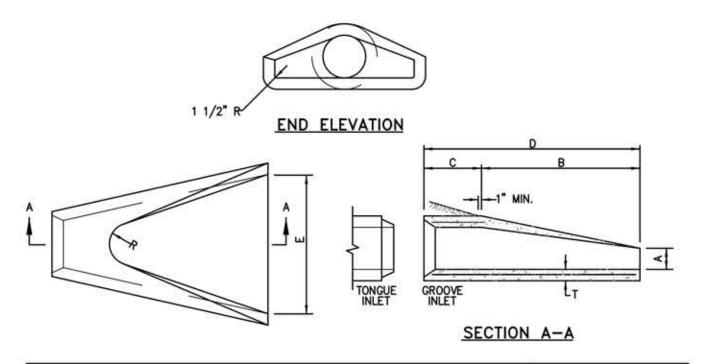










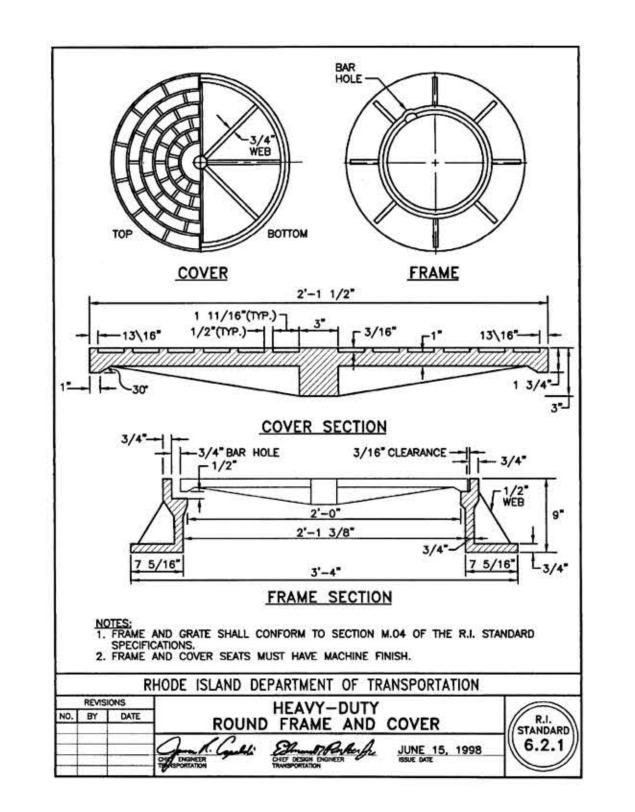


			DIME	ENSIONS				REINFORCEMENT
214	L.S				-		į.	ONE LAYER REINFORCEMENT IN CENTER OF WALL
DIA.	A	В	С	D	E	R	Ţ	MIN. AREA OF EACH WAY (SQ. IN./FT.)
1'-0"	4"	2'-0"	4'-0 7/8"	6'-0 7/8"	2'-0"	9"	2"	0.048
1'-3"	6"	2'-3"	3'-10"	6'-1"	2'-6"	11"	2 1/4"	0.054
1'-6"	9"	2'-3"	3'-10"	6'-1"	3'-0"	12"	2 1/2"	0.060
2"-0"	9 1/2"	3'-7 1/2"	2'-6"	6'-1 1/2"	4'-0"	1'-2"	3"	0.072
2'-6"	1'-0"	4'-6"	1'-7 3/4"	6'-1 3/4"	5'-0"	1'-3"	3 1/2"	0.084
3'-0"	1'-3"	5'-3"	2'-10 3/4"	8'-1 3/4"	6'-0"	1'-8"	4"	0.096
3'-6"	1'-9"	5'-3"	2'-11"	8'-2"	6'-6"	1'-10"	4 1/2"	0.108
4'-0"	2'-0"	6'-0"	2'-2"	8'-2"	7'-0"	1'-10"	5"	0.120
4'-6"	2'-3"	5'-5"	2'-11"	8'-4"	7'-6"	2'-0"	5 1/2"	0.132
5'-0"	2'-6"	5'-0"	3'-3"	8'-3*	8'-0"	2'-0"	6"	0.144

NOTE: SHALL BE IN ACCORDANCE WITH SECTION 701 OF THE R.I. STANDARD SPECIFICATIONS.

PRECAST CONCRETE FLARED END SECTION


NOT TO SCALE (RIDOT STD. 2.3.0)

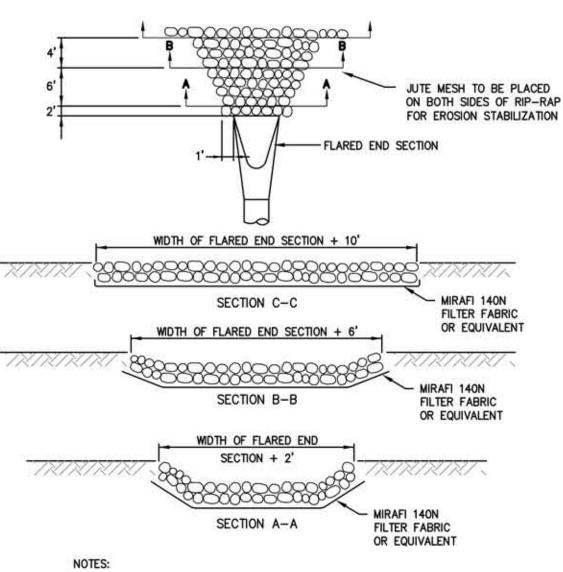

- 1. UNLESS OTHERWISE SPECIFIED, CLASS "C" RIP-RAP IS TO BE USED FOR ALL FLARED ENDS.
- 2. DIMENSIONS MAY BE MODIFIED BY ENGINEER TO MEET FIELD CONDITIONS.
- 3. UNLESS OTHERWISE SPECIFIED, DUMPED RIP-RAP SHALL
- BE USED. 4. USE ONLY SECTION A-A FOR ROOF DRAINS.

RIP RAP AT FLARED END SECTION


NOT TO SCALE

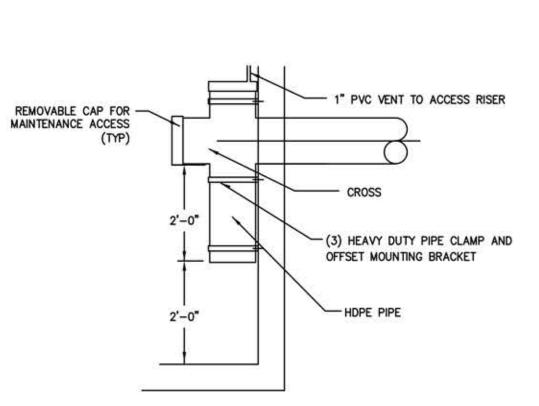

OIL/WATER SEPARATOR ELBOW NOT TO SCALE

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NO.	REVISION	BY	DATE
1	REV. PER PRELIMINARY	SSH	05/03/202
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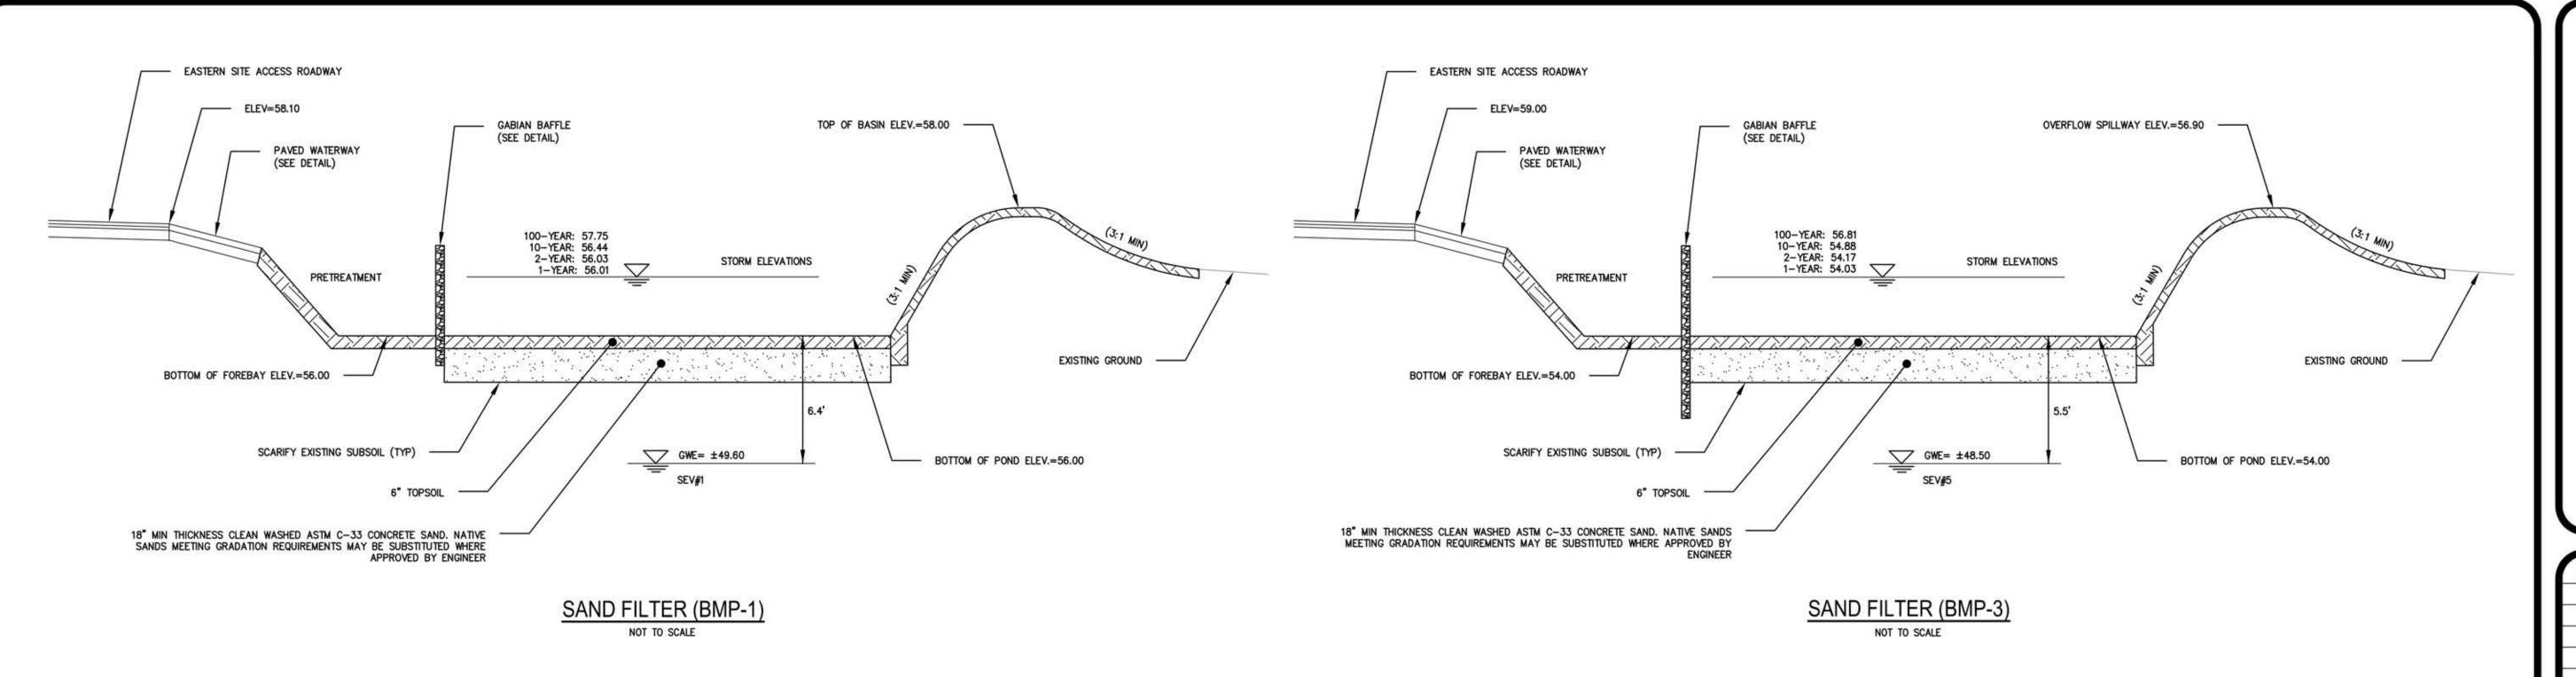
DRAWN BY K.Y.Y. 7272-00 CHECK BY S.S.H.


JOB NO. DWG. NO. 7272-00-Details.dwg APPROVED S.B.G. SCALE: AS SHOWN DATE:

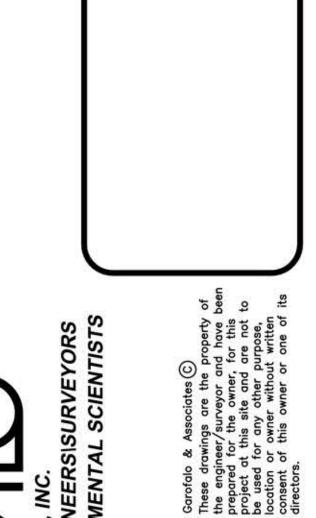
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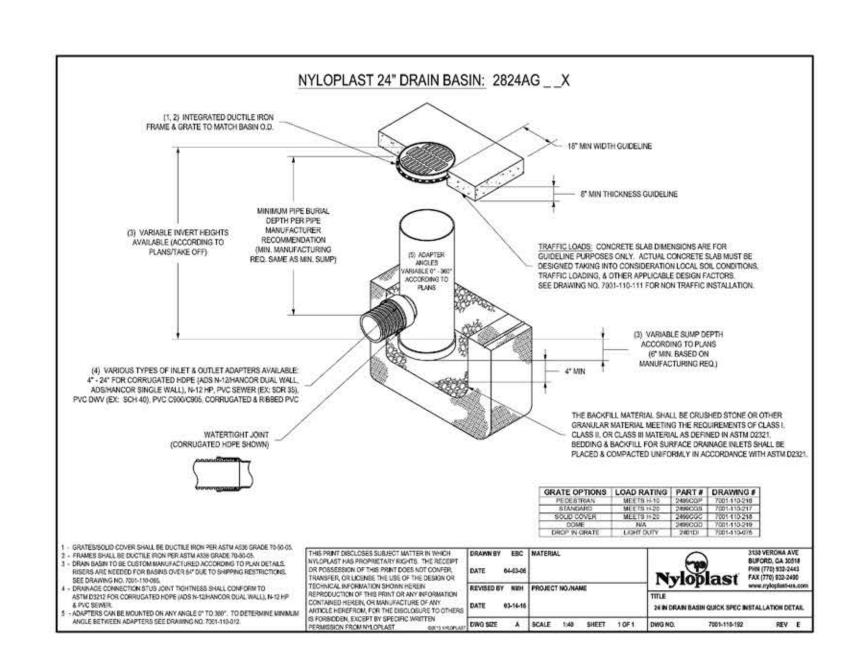
17 OF 19 SHEETS


JANUARY 26, 2021






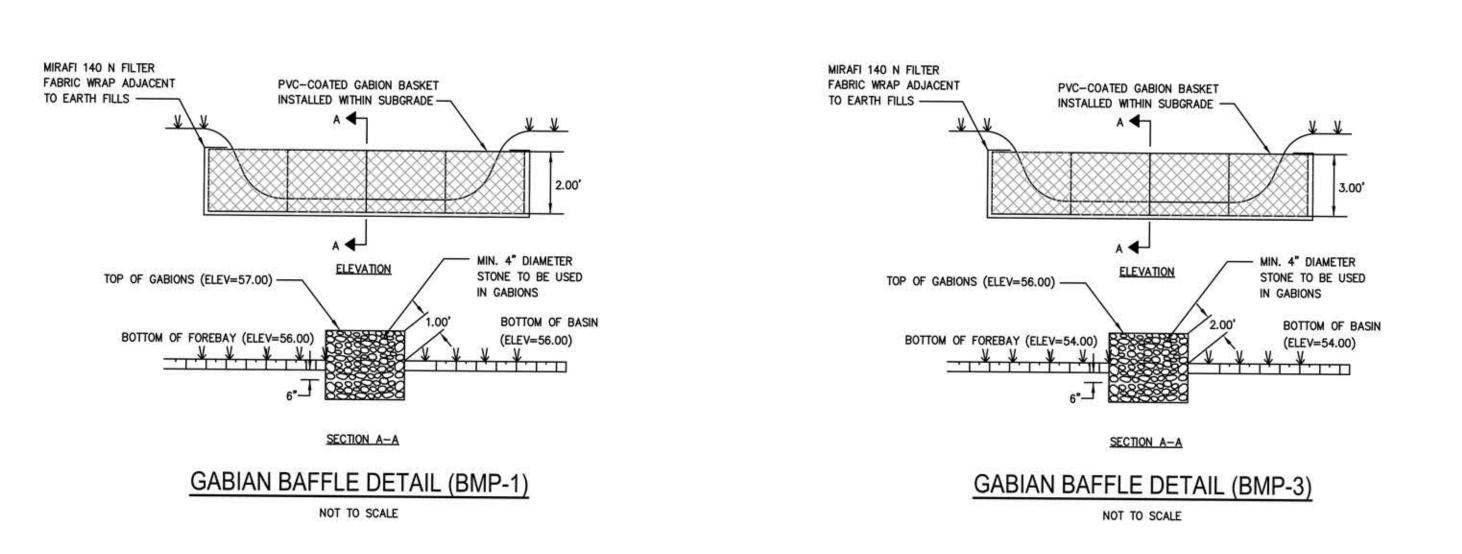

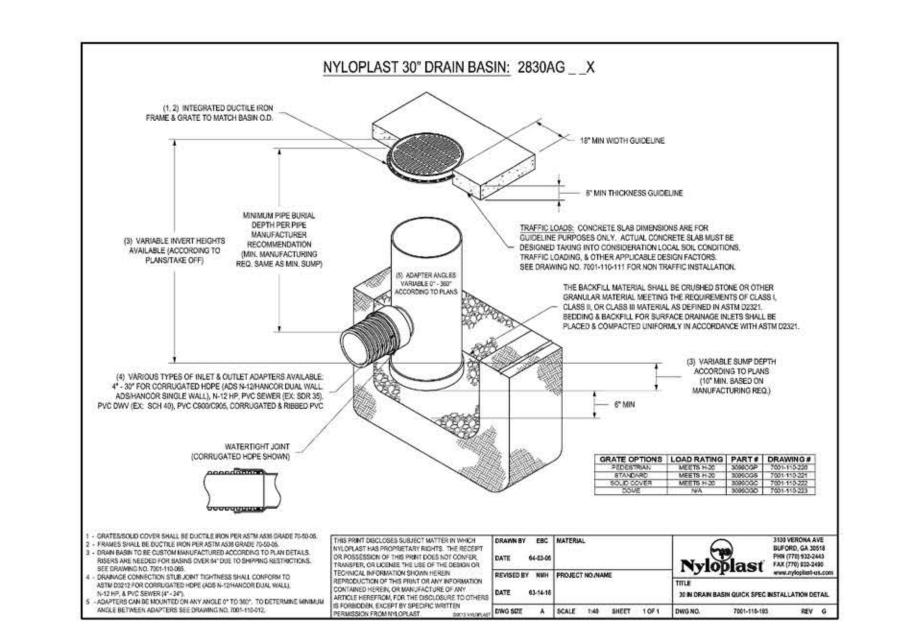


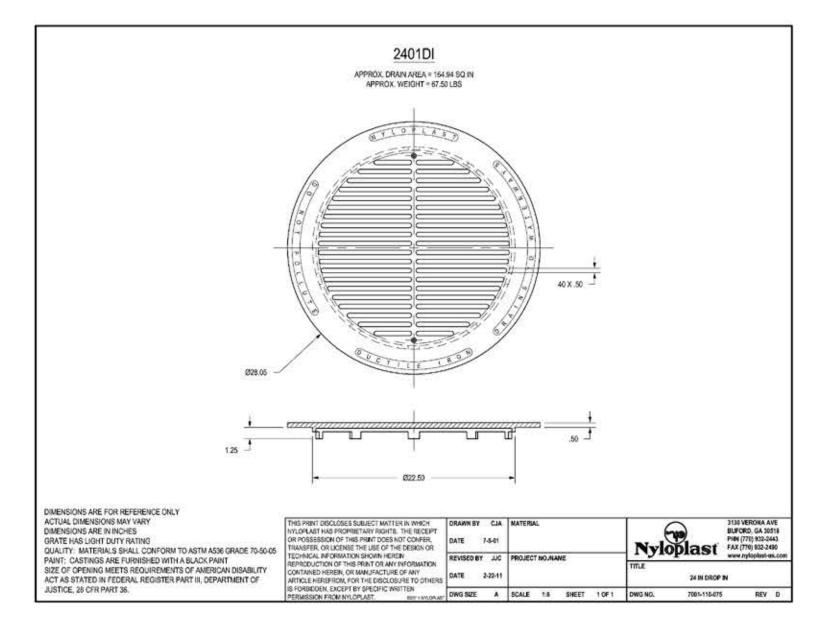

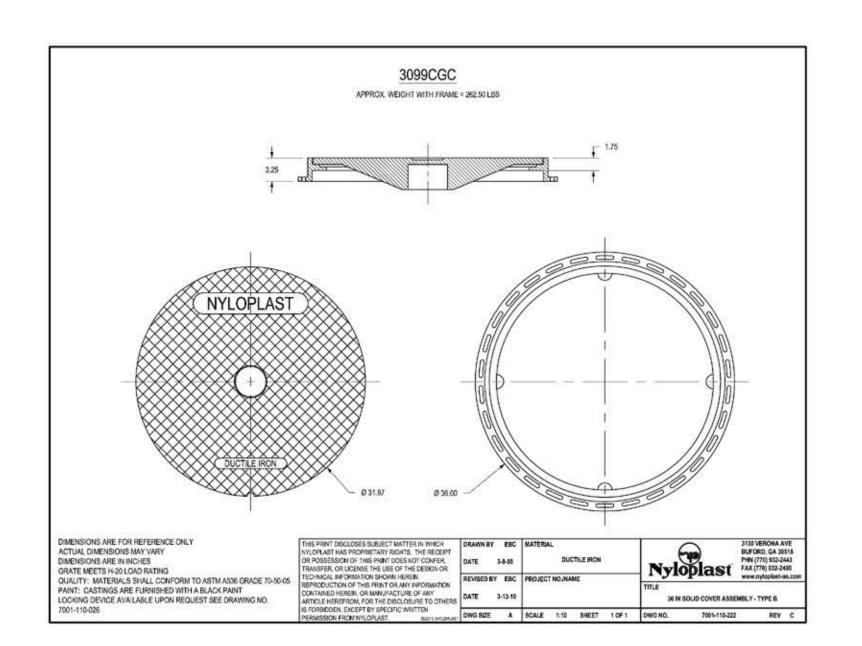

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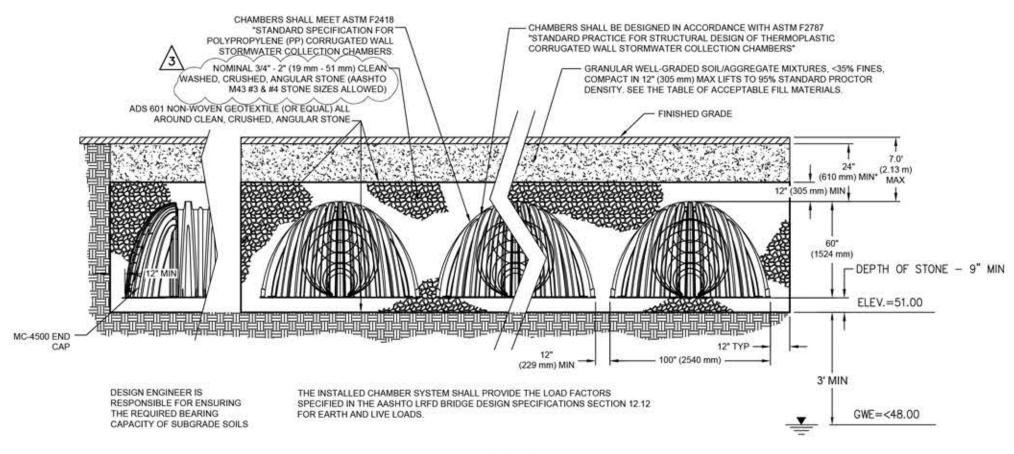
JANUARY 26, 2021

JOB NO. DRAWN BY R.A.S. 7272-00 DWG. NO. CHECK BY S.S.H. 7272-00-Details.dwg APPROVED S.B.G. SCALE: AS SHOWN DATE:

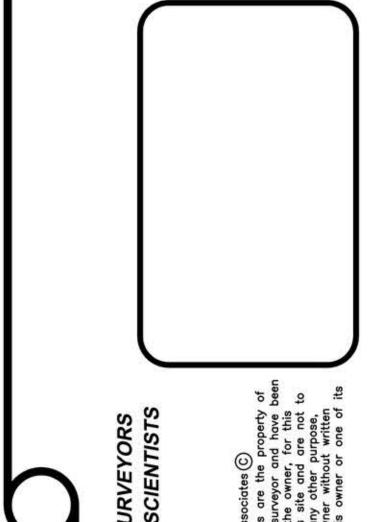
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BMP-2A MC-4500 TYP CROSS SECTION

NOT TO SCALE



BMP-2B MC-4500 TYP CROSS SECTION

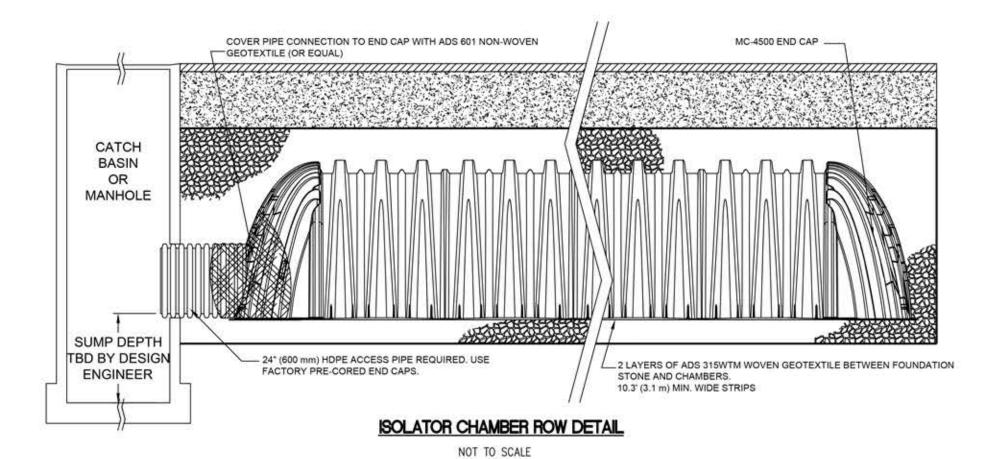

ACCEPTABLE FILL MATERIALS: STORMTECH MC-4500 CHAMBER SYSTEMS

M	ATERIAL LOCATION	DESCRIPTION	AASHTO M43 DESIGNATION ¹	COMPACTION/DENSITY REQUIREMENT
(FILL MATERIAL FOR LAYER 'D' STARTS FROM THE TOP OF THE 'C' LAYER TO THE BOTTOM OF FLEXIBLE PAVEMENT OR UNPAVED FINISHED GRADE ABOVE. NOTE THAT PAVEMENT SUBBASE MAY BE PART OF THE 'D' LAYER.	ANY SOIL/ROCK MATERIALS, NATIVE SOILS, OR PER ENGINEER'S PLANS. CHECK PLANS FOR PAVEMENT SUBGRADE REQUIREMENTS.	N/A	PREPARE PER ENGINEER'S PLANS. PAVED INSTALLATIONS MAY HAVE STRINGENT MATERIAL AND PREPARATION REQUIREMENTS.
©	FILL MATERIAL FOR LAYER 'C' STARTS FROM THE TOP OF THE EMBEDMENT STONE ('B' LAYER) TO 24" [610 mm] ABOVE THE TOP OF THE CHAMBER. NOTE THAT PAVEMENT SUBBASE MAY BE A PART OF THIS LAYER.	GRANULAR WELL-GRADED SOIL/AGGREGATE MIXTURES, < 35% FINES. MOST PAVEMENT SUBBASE MATERIALS CAN BE USED IN LIEU OF THIS LAYER.	3, 357, 4, 467, 5, 56, 57, 6, 67, 68, 7, 78, 8, 89, 9, 10	BEGIN COMPACTION AFTER 24" [610 mm] OF MATERIAL OVER THE CHAMBERS IS REACHED. COMPACT ADD- ITIONAL LAYERS IN 12" [305 mm] MAX LIFTS TO A MIN. 95% STANDARD PROCTOR DENSITY
B	EMBEDMENT STONE SURROUNDING THE CHAMBERS FROM THE FOUNDATION STONE TO THE 'C' LAYER ABOVE.	CLEAN WASHED, CRUSHED, ANGULAR STONE, NOMINAL SIZE DISTRIBUTION BETWEEN 3/4 - 2 INCH [19 - 51 mm]	3, 4	NO COMPACTION REQUIRED.
(A)	FOUNDATION STONE BELOW CHAMBERS FROM THE SUBGRADE UP TO THE FOOT (BOTTOM) OF THE CHAMBER.	CLEAN WASHED, CRUSHED, ANGULAR STONE, NOMINAL SIZE DISTRIBUTION BETWEEN 3/4 - 2 INCH [19 - 51 mm]	3, 4	PLATE COMPACT OR ROLL TO ACHIEVE A 95% STANDARD PROCTOR DENSITY 2.


PLEASE NOTE:


1. THE LISTED AASHTO DESIGNATIONS ARE FOR GRADATIONS ONLY. THE STONE MUST ALSO BE CLEAN, CRUSHED, ANGULAR. FOR EXAMPLE, A SPECIFICATION FOR #4 STONE WOULD STATE: "CLEAN, CRUSHED, ANGULAR NO. 4 (AASHTO M43) STONE".

2. AS AN ALTERNATE TO PROCTOR TESTING AND FIELD DENSITY MEASUREMENTS ON OPEN GRADED STONE, STORMTECH COMPACTION REQUIREMENTS ARE MET FOR 'A' LOCATION MATERIALS WHEN PLACED AND COMPACTED IN 9" [229 mm] (MAX) LIFTS USING TWO FULL COVERAGES WITH AN APPROPRIATE COMPACTOR.

STORMWATER CHAMBER SPECIFICATIONS

- 1. CHAMBERS SHALL BE STORMTECH MC-4500 OR APPROVED EQUAL.
- CHAMBERS SHALL BE MADE FROM VIRGIN, IMPACT-MODIFIED POLYPROPYLENE COPOLYMERS.
- CHAMBER ROWS SHALL PROVIDE CONTINUOUS, UNOBSTRUCTED INTERNAL SPACE WITH NO INTERNAL SUPPORT PANELS THAT WOULD IMPEDE FLOW OR LIMIT ACCESS FOR INSPECTION.
- 4. THE STRUCTURAL DESIGN OF THE CHAMBERS, THE STRUCTURAL BACKFILL AND THE INSTALLATION REQUIREMENTS SHALL ENSURE THAT THE LOAD FACTORS SPECIFIED IN THE AASHTO LRFD BRIDGE DESIGN SPECIFICATIONS, SECTION 12.12 ARE MET FOR: 1) LONG-DURATION DEAD LOADS AND 2) SHORT-DURATION LIVE LOADS, BASED ON THE AASHTO DESIGN TRUCK WITH CONSIDERATION FOR IMPACT AND MULTIPLE VEHICLE PRESENCES.
- CHAMBERS SHALL CONFORM TO THE REQUIREMENTS OF ASTM F 2787, "STANDARD PRACTICE FOR STRUCTURAL DESIGN OF THERMOPLASTIC CORRUGATED WALL STORMWATER COLLECTION CHAMBERS".
- ONLY CHAMBERS THAT ARE APPROVED BY THE ENGINEER WILL BE ALLOWED.
 THE CONTRACTOR SHALL SUBMIT (3 SETS) OF THE FOLLOWING TO THE ENGINEER
 FOR APPROVAL BEFORE DELIVERING CHAMBERS TO THE PROJECT SITE:
 - a. A STRUCTURAL EVALUATION BY A REGISTERED STRUCTURAL ENGINEER THAT DEMONSTRATES THAT THE LOAD FACTORS SPECIFIED IN THE AASHTO LRFD BRIDGE DESIGN SPECIFICATIONS, SECTION 12.12 ARE MET.
 - STRUCTURAL CROSS SECTION DETAIL ON WHICH THE STRUCTURAL CROSS SECTION IS BASED.
- THE INSTALLATION OF CHAMBERS SHALL BE IN ACCORDANCE WITH THE MANUFACTURER'S LATEST INSTALLATION INSTRUCTIONS.

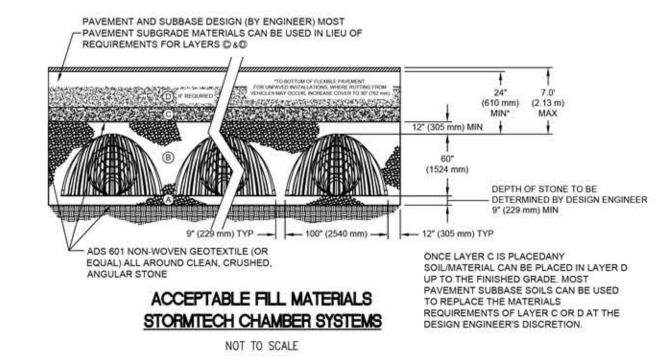

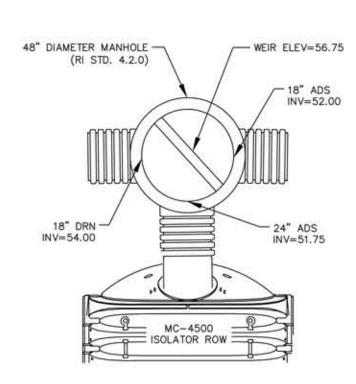

DMH #2
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© and have been bern to to purpose, but written or one of its

Garofalo & Associates (C)
These drawings are the property of the engineer/surveyor and have been prepared for the owner, for this project at this site and are not to be used for any other purpose,

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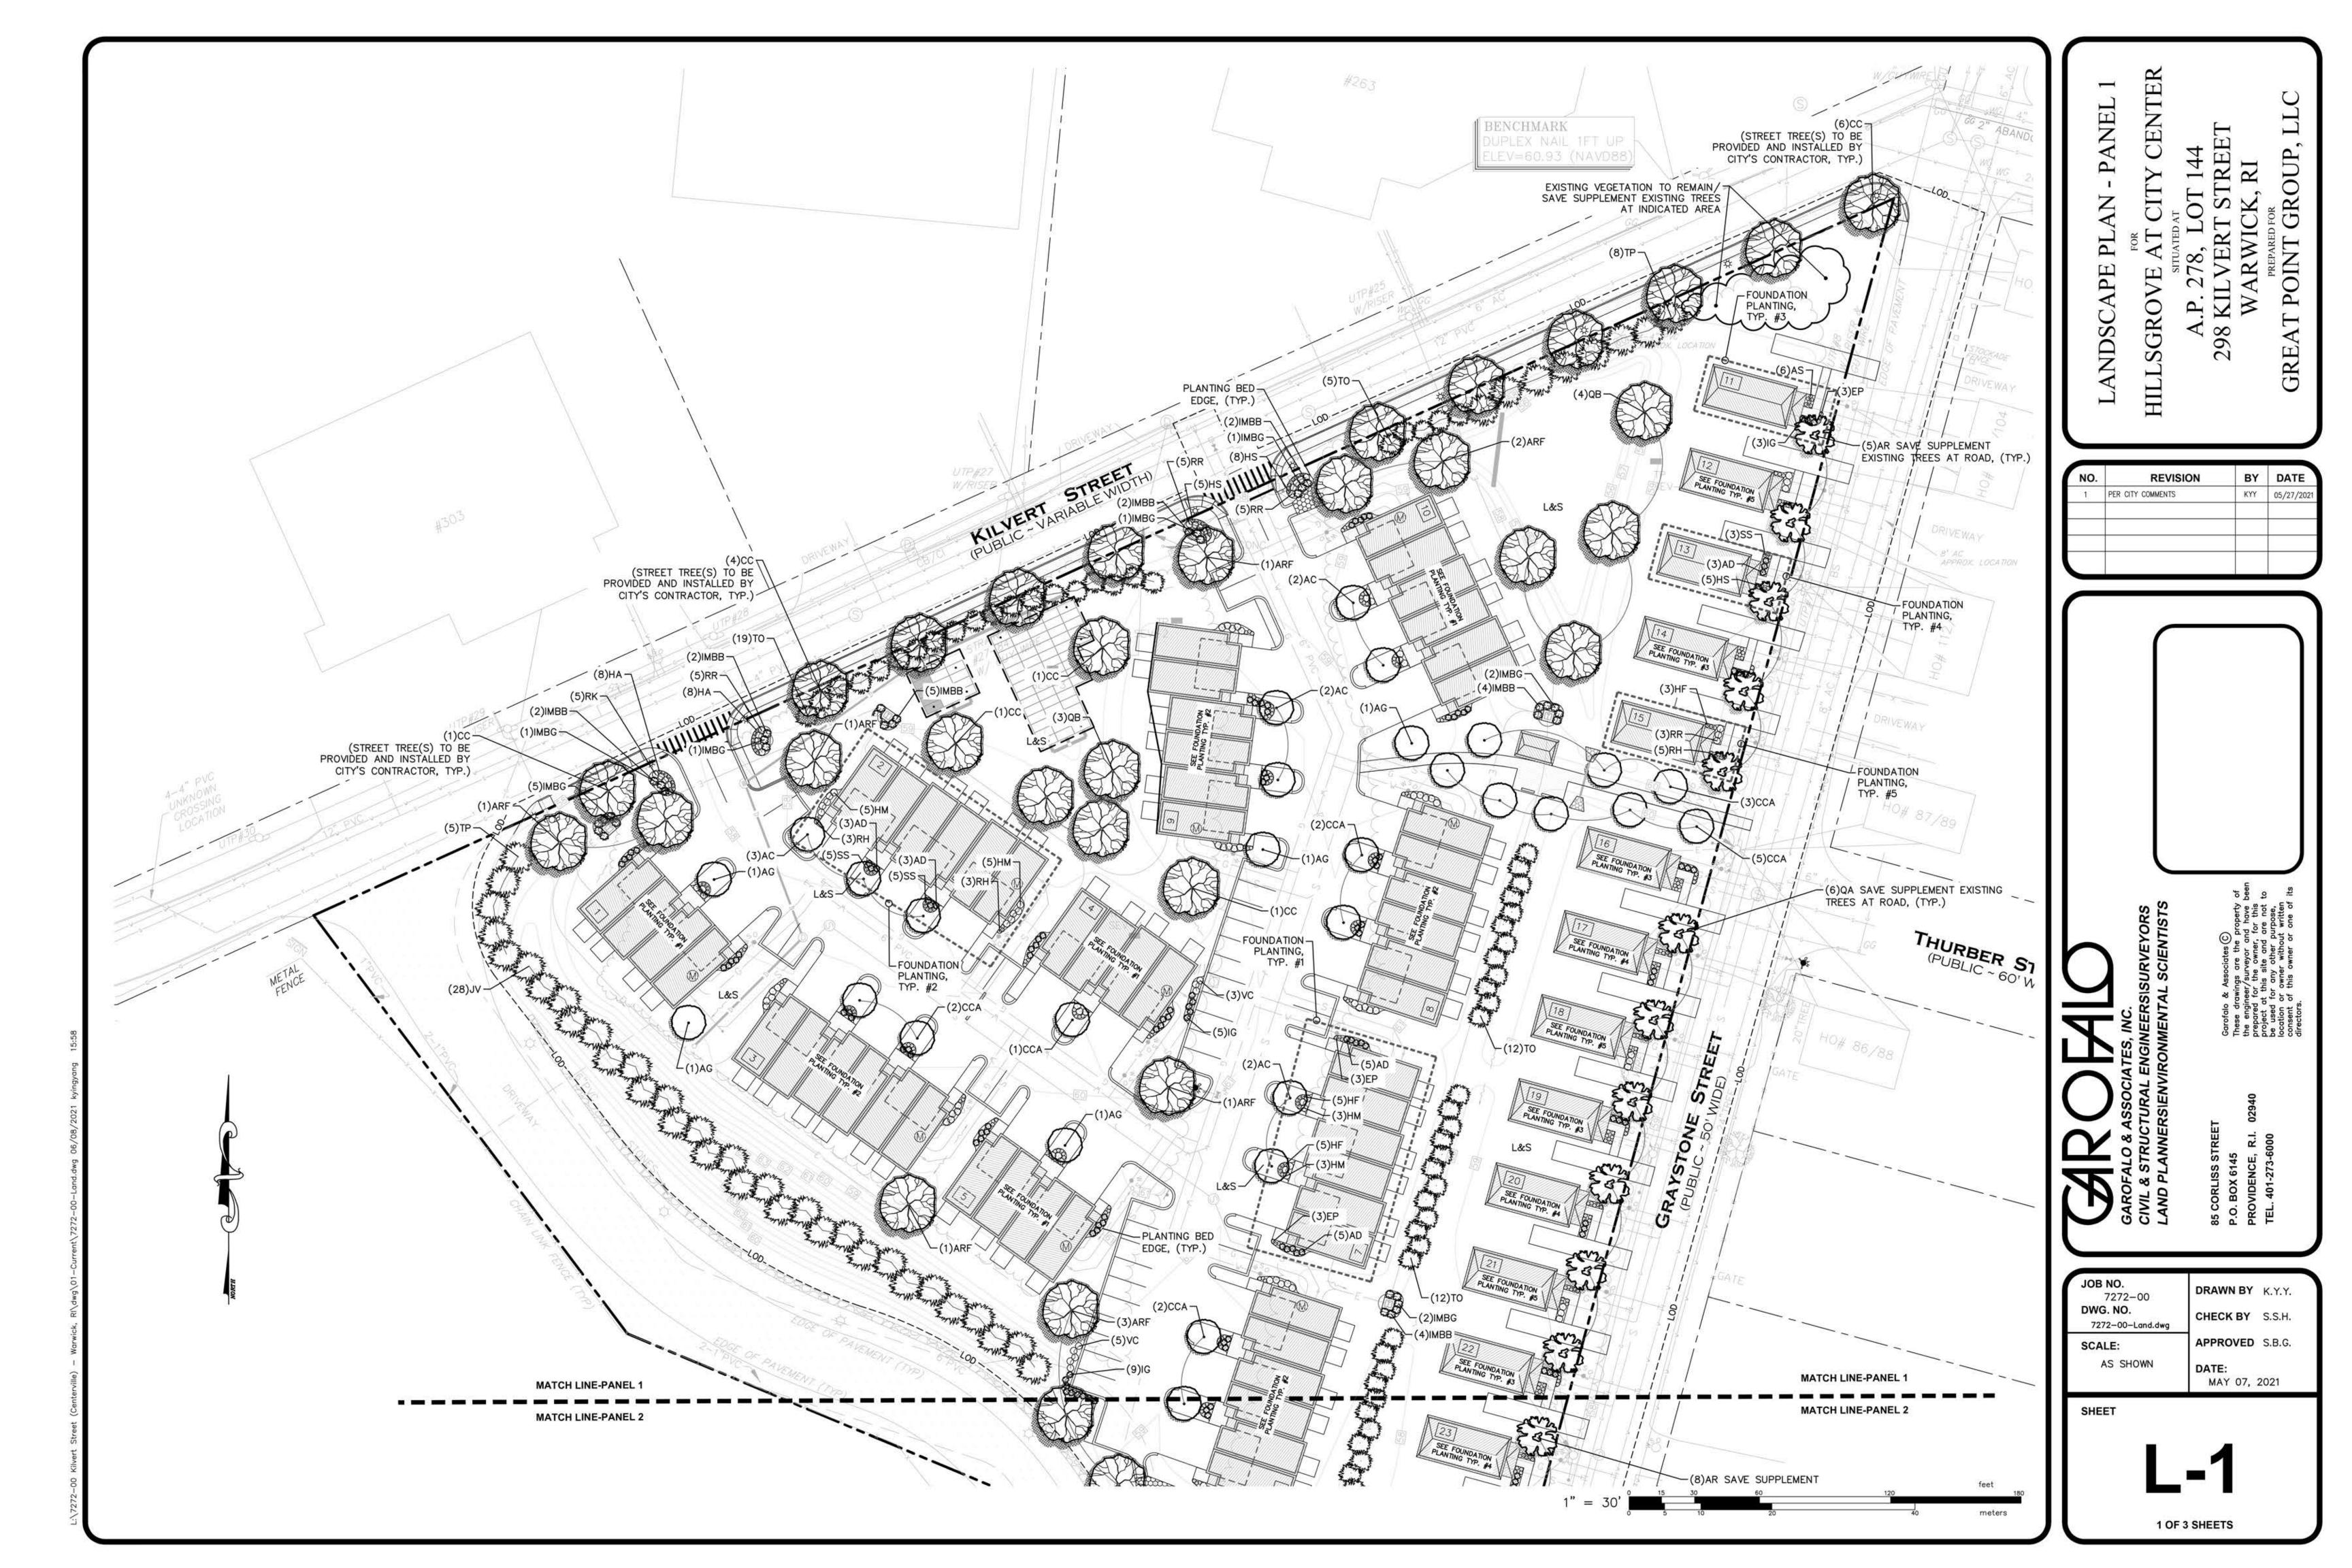
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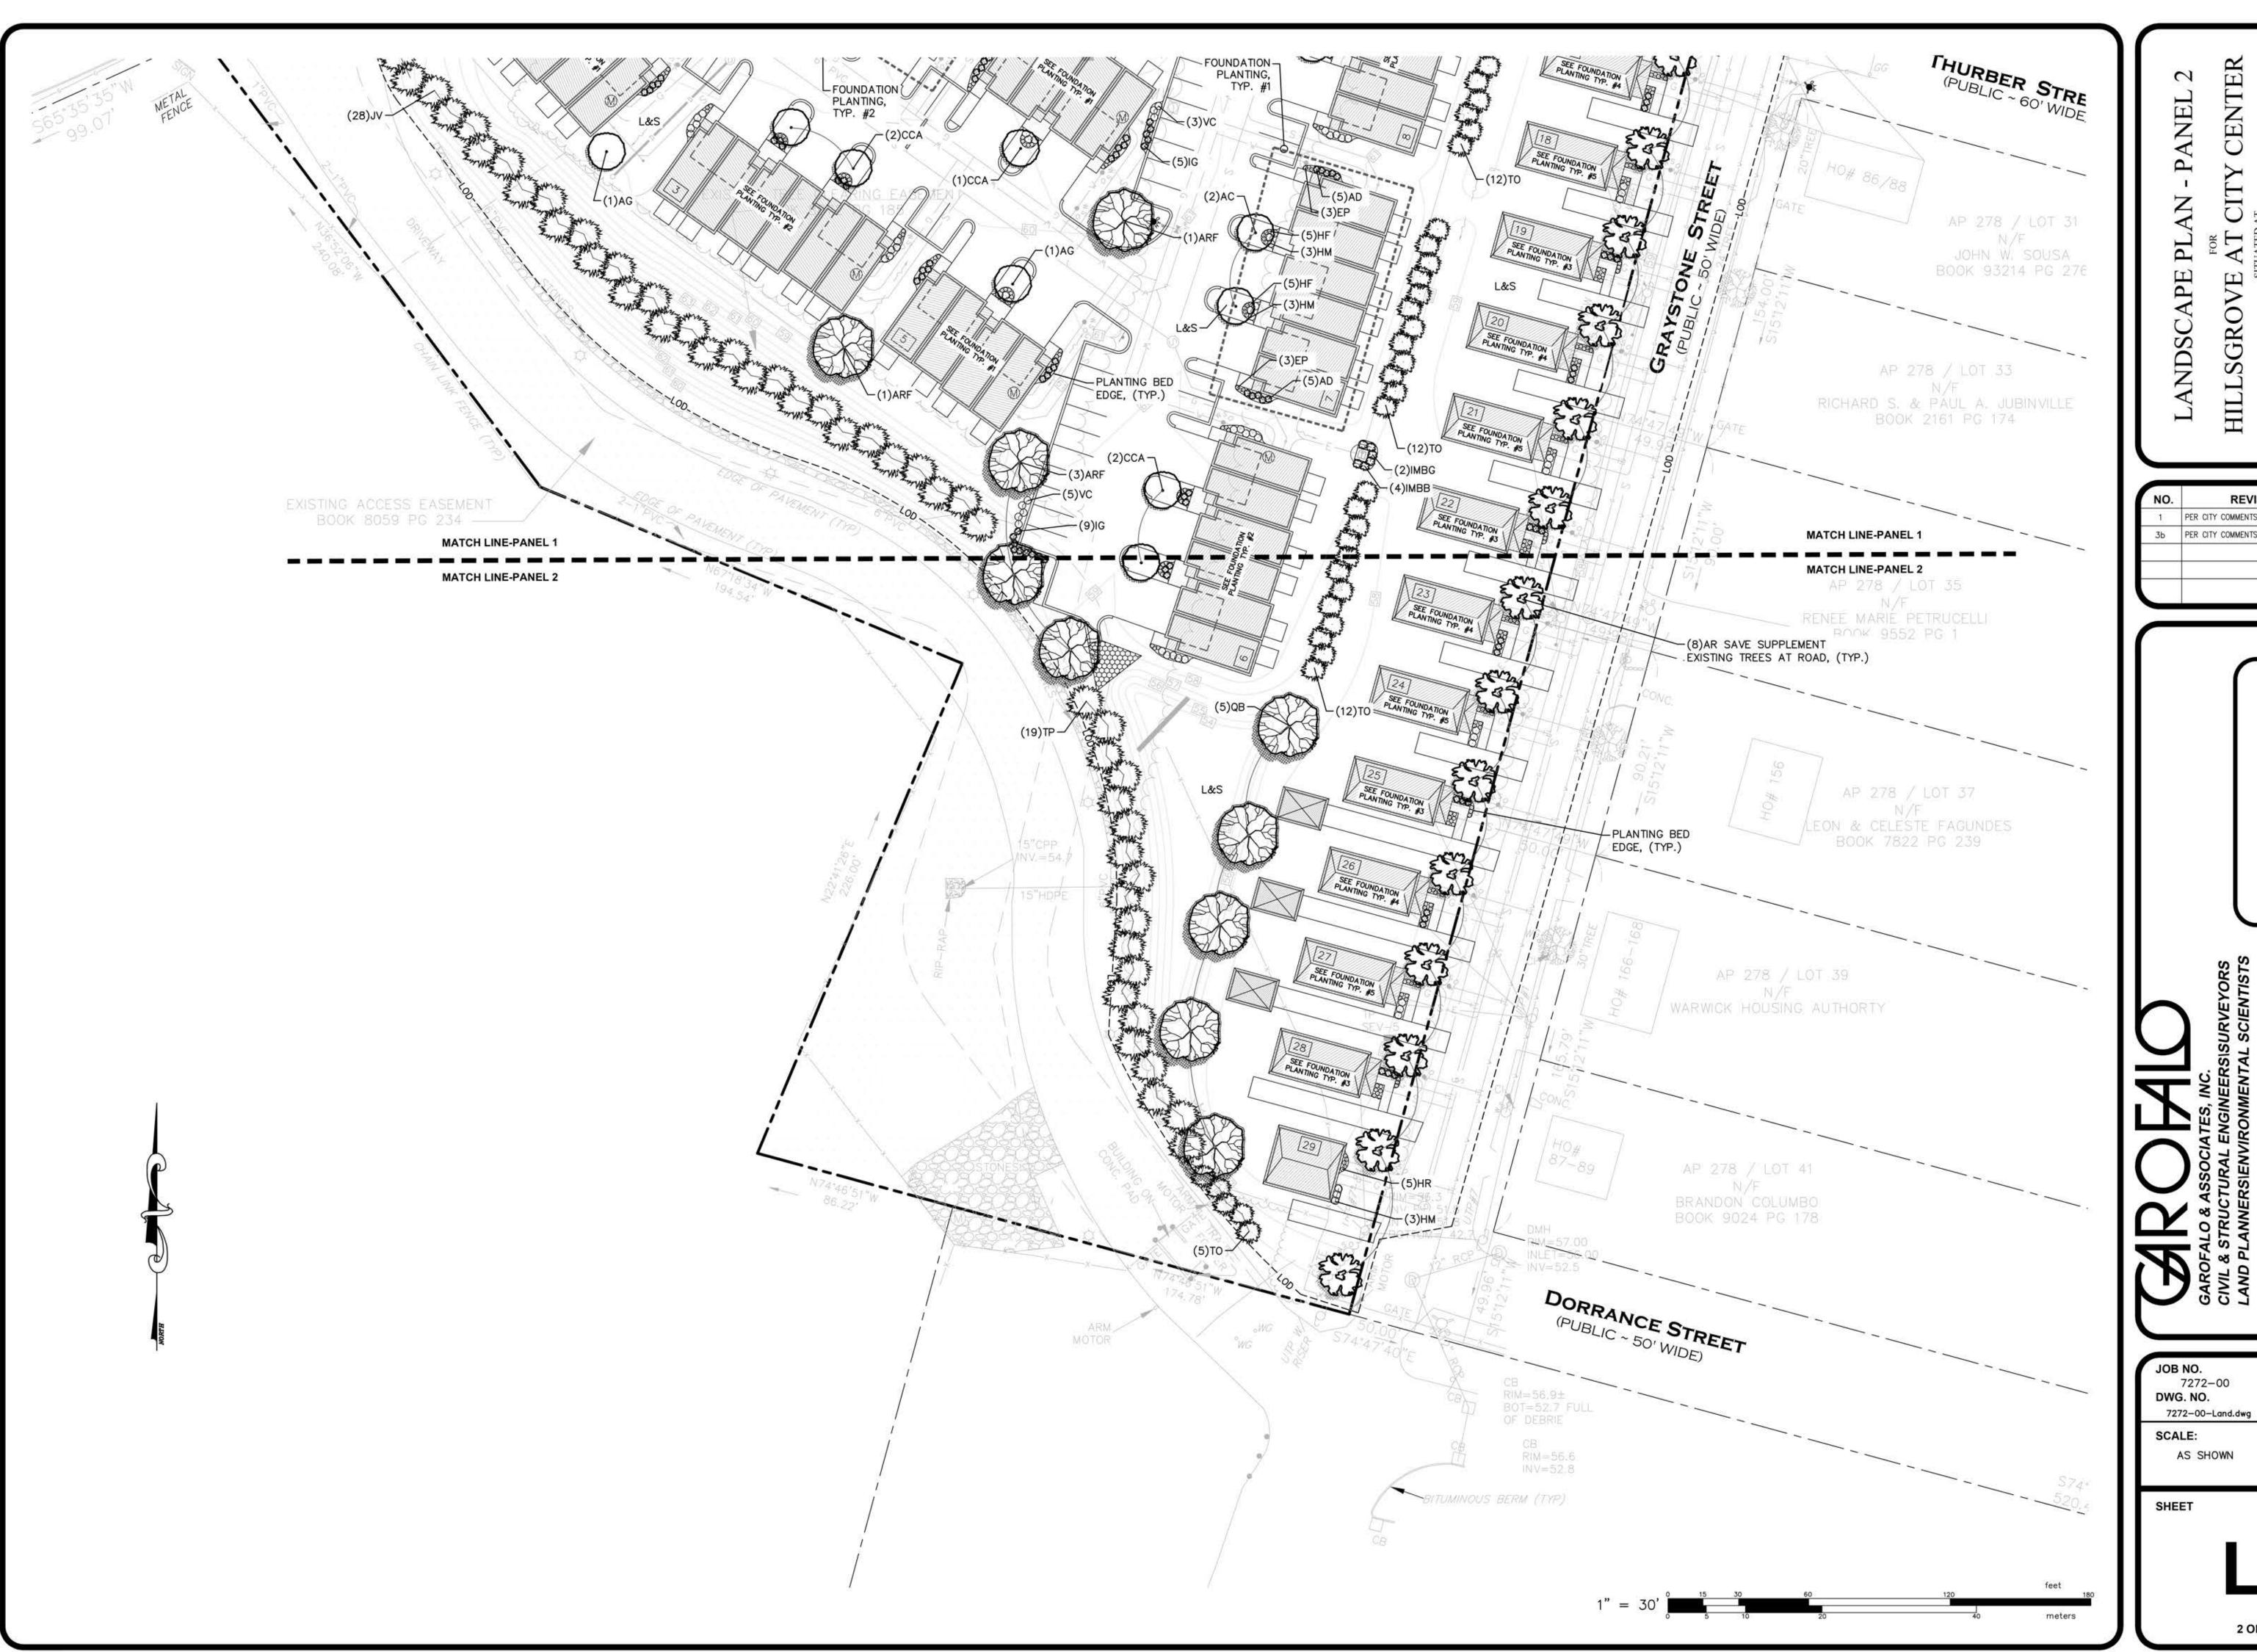
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AS SHOWN DATE:
JANUARY 26, 2021

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DRAWN BY K.Y.Y. CHECK BY S.S.H. APPROVED S.B.G.

DATE: MAY 07, 2021

SHEET

2 OF 3 SHEETS

GENERAL LANDSCAPE NOTES:

- 1. THE CONTRACTOR SHALL INSTALL ALL PLANT MATERIAL IN CONFORMANCE WITH THE RHODE ISLAND DEPARTMENT OF TRANSPORTATION STANDARD SPECIFICATIONS FOR ROAD AND BRIDGE CONSTRUCTION, LATEST EDITION.
- 2. ALL PLANT MATERIAL SHALL MEET THE AMERICAN OF NURSERYMEN STANDARDS FOR NURSERY STOCK LATEST EDITION, AND ITS AMENDMENTS. PLANT ONLY DURING SEASONS NORMAL TO THE PARTICULAR VARIETY. NO SUBSTITUTIONS SHALL BE ACCEPTED WITHOUT PRIOR APPROVAL BY THE LANDSCAPE ARCHITECT.
- 3. ALL PLANT MATERIAL FURNISHED BY THE CONTRACTOR SHALL BE GUARANTEED FOR A PERIOD OF ONE YEAR. IF THE FIRST YEAR ENDS DURING THE DORMANT PERIOD, THE GUARANTEE SHALL EXTEND TO THE START OF THE NEXT LEAFING. DURING THE ONE-YEAR GUARANTEE PERIOD THE CONTRACTOR SHALL EMPLOY ACCEPTED HORTICULTURAL PRACTICES TO KEEP THE PLANTS INSTALLED IN LIVING, HEALTHY CONDITION. FOLLOWING THE ONE-YEAR GUARANTEE PERIOD THE OWNER/OWNERS SHALL INSPECT ALL PLANT MATERIAL FOR HEALTHY ORNAMENTAL QUALITY. AT THAT TIME SHOULD ANY PLANT MATERIAL BE FOUND IN INADEQUATE HEALTH THE CONTRACTOR SHALL BE RESPONSIBLE TO REPLACE THE PLANT IN KIND AND PROVIDE A ONE-YEAR GUARANTEE FOR THE REPLACEMENT PLANT.
- 4. INSTALL ALL PLANT MATERIAL AS SHOWN IN DETAILS.
- 5. STAKE ALL TREES OVER 5' AS SHOWN ON DETAILS. REMOVE STAKES AT THE END OF THE GUARANTEE
- 6. THE CONTRACTOR IS RESPONSIBLE FOR KEEPING THE SITE CLEAN OF MISCELLANEOUS DEBRIS THROUGHOUT THE CONSTRUCTION PERIOD. ALL WASTE MATERIAL IS TO BE DISPOSED OF IMMEDIATELY TO AN OFFSET LOCATION, UNLESS OTHERWISE INDICATED ON THE PLANS.
- 7. THE CONTRACTOR SHALL PERFORM ALL WORK IN ACCORDANCE WITH ALL LOCAL, STATE, AND FEDERAL REGULATIONS, AND SHALL OBTAIN ALL NECESSARY PERMITS FOR THE PROJECT.
- 8. LAYOUT: ALL NOTES AND DIMENSIONS ARE TYPICAL UNLESS OTHERWISE NOTED. ALL DIMENSIONS ARE SQUARE (PARALLEL OR PERPENDICULAR) UNLESS OTHERWISE NOTED. THE CONTRACTOR SHALL NOTIFY THE OWNER'S REPRESENTATIVE IMMEDIATELY IN THE EVENT OF ANY DISCREPANCIES FOUND IN THE CONTRACT DOCUMENTS AND/OR IN THE FIELD, OR ON CONDITIONS UNCOVERED IN THE WORK WHICH ARE NOT REFLECTED IN THE PLANS.
- 9. PROTECTION OF EXISTING PLANTINGS: MAXIMUM EFFORT SHOULD BE MADE TO SAVE TREES OF OTHER PLANT SPECIMENS WHICH ARE LARGE FOR THEIR SPECIES, RARE TO THE AREA, OR OF SPECIAL HORTICULTURAL OR LANDSCAPE VALUE. CONTACT OWNER/LANDSCAPE ARCHITECT BEFORE REMOVING ANY SPECIMEN OF THIS TYPE UNLESS OTHERWISE NOTED ON THE PLANS. NO MATERIAL OR TEMPORARY SOIL DEPOSITS SHALL BE PLACED WITHIN THE DRIP LINE OF SHRUBS OR TREES DESIGNATED ON THE LANDSCAPE PLAN TO BE RETAINED. PROTECTIVE BARRIERS ARE TO BE INSTALLED AROUND EACH PLANT AND/OR GROUP OF PLANTS THAT ARE TO REMAIN ON THE SITE. BARRIERS SHALL NOT BE SUPPORTED BY THE PLANTS THEY ARE PROTECTING, BUT SHALL BE SELF SUPPORTING. THEY SHALL BE OF MINIMUM OF FOUR FEET (4') HIGH AND CONSTRUCTED OF A DURABLE MATERIAL, SUCH AS SNOW OR SILT FENCE, THAT WILL LAST UNTIL CONSTRUCTION IS COMPLETED.
- 10. PRUNING: THE CONTRACTOR SHALL CAREFULLY PRUNE BRANCHES IN THE WAY OF CONSTRUCTION BY USING ONLY APPROVED METHODS AND TOOLS. THE USE OF AXES FOR TRIMMING OR SPURS FOR CLIMBING WILL NOT BE PERMITTED.
- 11. UTILITIES: THE CONTRACTOR SHALL BE SOLELY RESPONSIBLE FOR ANY AND ALL UTILITY DAMAGE INCLUDING DAMAGE THAT MAY OCCUR TO NEW UTILITIES. THE CONTRACTOR IS REQUIRED TO CONTACT DIG-SAFE PRIOR TO COMMENCING ANY SITE CONSTRUCTION. THE CONTRACTOR IS SPECIFICALLY CAUTIONED THAT THE LOCATION AND/OR ELEVATION OF EXISTING UTILITIES AS SHOWN ON THESE PLANS IS BASED ON RECORDS OF THE VARIOUS UTILITY COMPANIES, AND WHERE POSSIBLE, MEASUREMENTS TAKEN IN THE FIELD. THE CONTRACTOR MUST CALL THE APPROPRIATE UTILITY COMPANIES AT LEAST 72 HOURS BEFORE ANY EXCAVATION TO REQUEST EXACT FIELD LOCATION OF UTILITIES. IT SHALL BE THE RESPONSIBILITY OF THE CONTRACTOR TO RELOCATE ALL EXISTING UTILITIES WHICH CONFLICT WITH THE PROPOSED IMPROVEMENTS SHOWN ON THE PLANS.
- 12. DISTURBED AREAS: ALL AREAS DISTURBED DURING THE COURSE OF CONSTRUCTION ARE TO BE RESTORED TO ORIGINAL (OR BETTER) CONDITION BY THE CONTRACTOR BEFORE COMPLETION OF THE PROJECT, AND ARE SUBJECT TO APPROVAL BY THE LANDSCAPE ARCHITECT AND OWNER. ALL GRASS AREAS DISTURBED DURING CONSTRUCTION SHALL BE FINE RAKED TO REMOVE STONES AND LOAMED AND SEEDED AS PER SPECIFICATIONS.
- 13. DRAINAGE SYSTEMS: CONTRACTOR IS RESPONSIBLE FOR GENERAL CLEAN-OUT OF ALL CATCH BASINS, MANHOLES, AND/OR OTHER DRAINAGE FEATURES ON THE SITE WHICH HAVE ACCUMULATED SEDIMENT AS A RESULT OF CONSTRUCTION ACTIVITIES.


LOAM AND SEEDING

APPLICATION OF LOAM AND SEED SHALL BE IN ACCORDANCE WITH APPLICABLE SECTIONS OF THE RHODE ISLAND DEPARTMENT OF TRANSPORTATION STANDARD SPECIFICATIONS FOR ROAD AND BRIDGE CONSTRUCTION, LATEST EDITION.


- 1. LOAM MATERIAL TO BE FURNISHED SHALL CONSIST OF SCREENED LOOSE, FRIABLE, FINE SANDY LOAM OR SANDY LOAM, AS DEFINED BY THE USDA'S SOIL CONSERVATION SERVICE IN THE SOIL SURVEY MANUAL ISSUED IN 1993, FREE OF SUBSOIL, REFUSE, STUMPS, ROOTS, ROCKS, COBBLES, STONES, BRUSH, NOXIOUS WEEDS, LITTER AND OTHER MATERIALS WHICH ARE LARGER THAN 1/2-INCH IN ANY DIMENSION AND WHICH WILL PREVENT THE FORMATION OF A SUITABLE SEED BED. ORGANIC MATTER SHALL CONSTITUTE NOT LESS THAN 5 PERCENT NOR MORE THAN 20 PERCENT OF THE LOAM AS DETERMINED BY LOSS-ON-IGNITION OF OVEN DRIED SAMPLES THAT HAVE BEEN DRAWN BY THE ENGINEER, UNLESS OTHERWISE SPECIFIED OR DIRECTED. THE LOAM SHALL HAVE AN ACIDITY RANGE OF 5.5 PH TO 7.6 PH.
- 2. LOAM MOVED DURING THE COURSE OF CONSTRUCTION SHALL BE RETAINED AND DISTRIBUTED WITHIN THE SITE IN ACCORDANCE WITH THE LANDSCAPE PLAN. STOCKPILED LOAM SHALL NOT BE MIXED WITH ANY SUBSOIL OR UNSUITABLE MATERIAL. ALL EXISTING LOAM REMAINS THE PROPERTY OF THE OWNER.
- 3. LOAM SHALL BE SPREAD TO A DEPTH OF 4" IN SEEDING AREAS AND PLACED TRUE TO LINES AND GRADES SHOWN ON THE PLANS.
- 4. THE LOAMED SURFACE SHALL BE GRADED, AND ALL ROOTS, SODS, WEEDS, COBBLES OR STONES WITH ANY DIMENSION GREATER THAN 1 INCH SHALL BE REMOVED AND LEGALLY DISPOSED OF. AFTER SHAPING AND GRADING, ALL TRUCKS AND OTHER EQUIPMENT NOT REQUIRED TO PERFORM SEEDING, MULCHING OR MOWING OPERATIONS SHALL BE EXCLUDED FROM THE LOAMED AREAS.
- 5. LIME (GROUND OR PELLETIZED) SHALL BE APPLIED DRY AND SPREAD EVENLY OVER THE ENTIRE SURFACE TO BE SEEDED. UNLESS OTHERWISE SPECIFIED, THE APPLICATION RATE SHALL BE 1 TON PER ACRE. RAKING SHALL BE COMPLETED AFTER THE FERTILIZER HAS BEEN APPLIED.
- 6. ALL SEED DELIVERED TO THE JOB SHALL BE IN CONTAINERS LABELED IN ACCORDANCE WITH PROVISIONS OF THE RHODE ISLAND SEED ACT OF 1956 (VOLUME 8, TITLE 2, CHAPTER 6) AND ITS AMENDMENTS AS PROVIDED FOR AGRICULTURAL SEED OFFERED FOR SALE. ONLY THE CURRENT YEARS SEED SHALL BE ACCEPTED.
- 7. SEED SHALL BE APPLIED ONLY DURING THE FOLLOWING DATES:

SPRING SEEDING: MARCH 15 TO MAY 31. FALL SEEDING: AUGUST 15 TO OCTOBER 15.

6. THE CONTRACTOR SHALL WATER ALL SEEDED AREAS AND RESEED AS NECESSARY FOR A PERIOD OF 2-MONTHS OR UNTIL A HEALTH STAND OF GRASS IS ESTABLISHED AND APPROVAL HAS BEEN MADE BY THE OWNER/LANDSCAPE ARCHITECT.

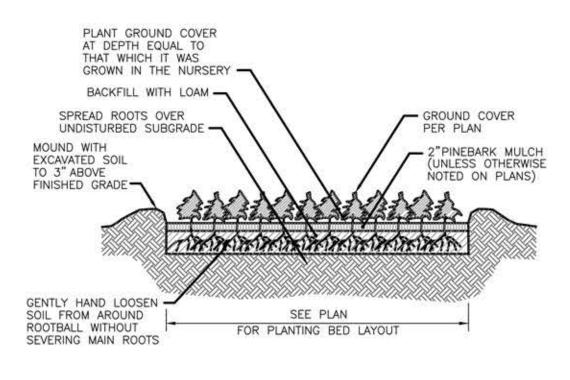

Ground Cover Planting Detail NOT TO SCALE

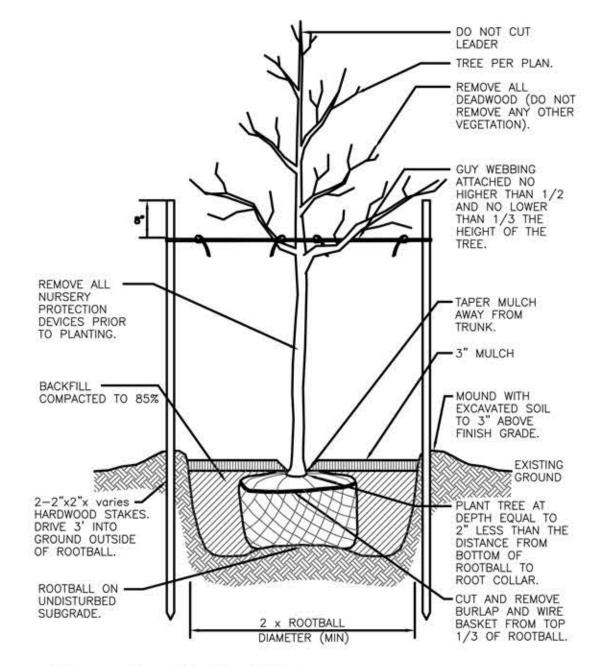

Canopy Tree Planting Detail

NOT TO SCALE

PLANT LIST:

KEY	BOTANICAL NAME COMMON NAME	QTY.	SIZE	NOTE
AR	ACER RUBRUM RED MAPLE	13	2.5"-3" CAL	
ARF	ACER RUBRUM 'FRANKSRED' RED SUNSET SWAMP MAPLE	I(I)	2.5"-3" CAL	
CC	CARPINUS CAROLINIANA AMERICAN HORNBEAM	14	2.5"-3" CAL	
QA	QUERCUS ALBA WHITE OAK	6	2.5*-3* CAL	
QB	QUERCUS BICOLOR SWAMP WHITE OAK	12	2.5°-3" CAL	


KEY	BOTANICAL NAME COMMON NAME	QTY.	SIZE	NOTE
AC	AMELANCHIER CANADENSIS SERVICEBERRY	9	7'-8' CLUMP	
AG	ACER GRISEUM PAPERBARK MAPLE	5	7'-8' CLUMP	
CCA	CERCIS CANADENSIS EASTERN REDBUD	15	7'-8' CLUMP	

-VLN	GREEN TREES			
KEY	BOTANICAL NAME COMMON NAME	QTY.	SIZE	NOTE
JV	JUNIPERUS VIRGINIANA RED CEDAR	28	5'-8' B¢B	
то	THUJA OCCIDENTALIS AMERICAN ARBORVITAE	65	5'-8' B¢B	
TP	THUJA PLICATA 'GREEN GIANT' GREEN GIANT ARBORVITAE	32	5'-8' B¢B	


GENERAL SEEDING MIX (L&S)

APPLICATION RATE: 200 LBS / ACRE

	PERCENT BY WEIGHT	PERCENT BY VOLUME
CHEWINGS FESCUE IMPROVED VARIETIES	30	85
KENTUCKY BLUEGRASS IMPROVED VARIETIES	30	90
PERENNIAL RYEGRASS IMPROVED VARIETIES	40	90

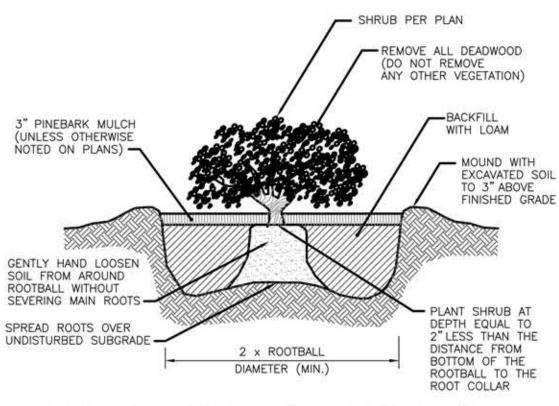


Container Grown Shrub and Perennial Planting Detaill NOT TO SCALE

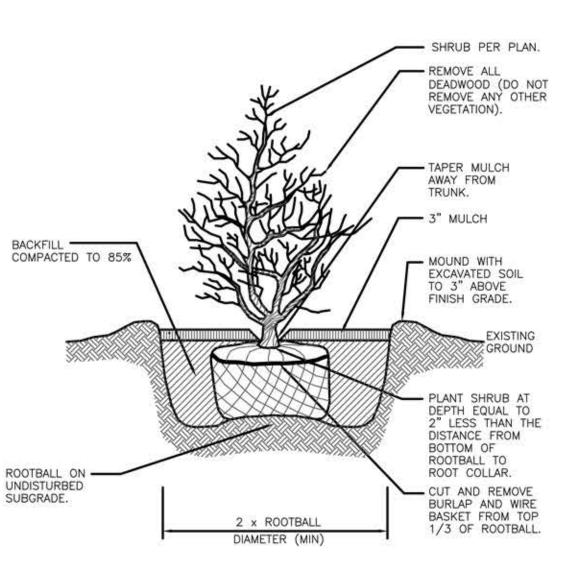


B & B Shrub Planting Detail


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KEY	BOTANICAL NAME COMMON NAME	QTY,	SIZE	NOTE
AS	ANEMONE SYLVESTRIS SNOWDROP ANEMONE	46	#2 CONTAINER	
EP	ECHINACEA PURPUREA 'MAGNUS' CONEFOWER	51	#2 CONTAINER	
HF	HOSTA 'FIRE AND ICE' FIRE NAD ICE HOSTA	57	#2 CONTAINER	
55	SCHIZACHYRIUM SCOPARIUM LITTLE BLUESTEM	72	#2 CONTAINER	
HS	HEMEROCALLIS 'STELLA DE ORO' STELLA DE ORO DAYLILY	38	#2 CONTAINER	
RH	RUDBECKIA HIRTA BLACK EYED SUSAN	60	#2 CONTAINER	

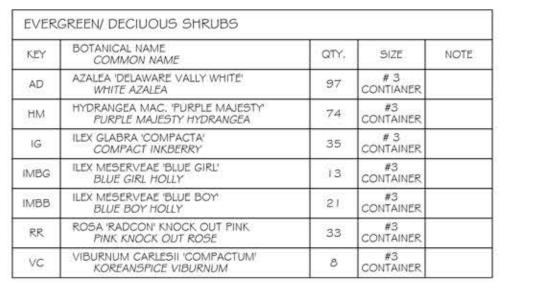

Perennial Planting Detai

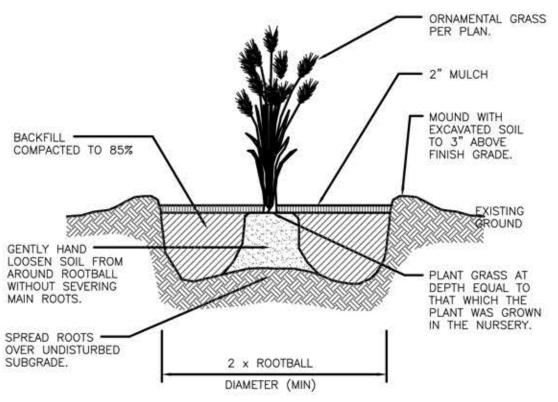


Evergreen Tree Planting Detail
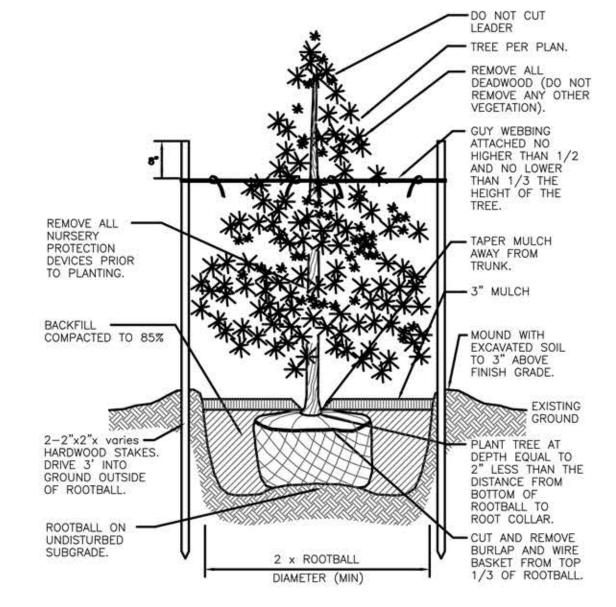
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JOB NO. DRAWN BY K.Y.Y. 7272-00 DWG. NO. CHECK BY S.S.H. 7272-00-Land.dwg APPROVED S.B.G. SCALE: AS SHOWN DATE:

SHEET

MAY 07, 2021

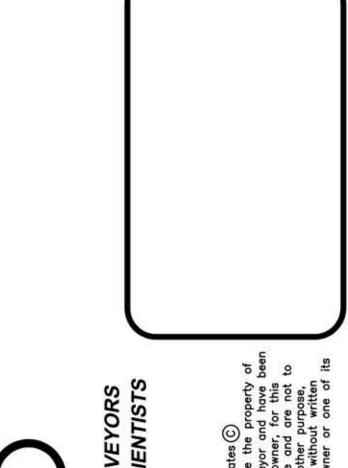3 OF 3 SHEETS

