

SURVEY CLASSIFICATION:

THIS SURVEY HAS BEEN CONDUCTED AND THE PLAN HAS BEEN PREPARED PURSUANT TO SECTION 9 OF THE RULES AND REGULATIONS ADOPTED BY THE RHODE ISLAND STATE BOARD OF REGISTRATION FOR PROFESSIONAL LAND SURVEYORS ON NOVEMBER 25, 2015, AS FOLLOWS

TYPE OF BOUNDARY SURVEY:

MEASUREMENT SPECIFICATION:

LIMITED CONTENT BOUNDARY SURVEY

CLASS I

THE PURPOSE FOR THE CONDUCT OF THE SURVEY AND FOR THE PREPARATION OF THE PLAN IS AS FOLLOWS

TO ESTABLISH AND STAKE BECORD BOUNDARY LINES.

BY: RICHARD T. BZDYRA, PLS; LICENSE #1786; COA # LS-A60

THE FOLLOWING TYPES OF EVIDENCE WERE USED TO CONSTRUCT THIS SURVEY. RECORDED FOUND MONUMENTS IF ANY, NON-RECORDED MONUMENTS, LINES OF POSSESSION, AND OTHER EVIDENCE RELATIVE TO THE DEED OR PLAT. THE BOUNDARY SOLUTION IS THE COMPILATION OF INFORMATION TO DETERMINE THE MOST PROBABLE LOCATION OF THE SURVEYED PARCEL

BOUNDARY STAKE-OUT SURVEY

A.P. 361 / LOT 746 **139 GORDON AVENUE** WARWICK, R.I. 02886

SCALE: 1"= 20' DATE: JULY 7, 2023 PREPARED FOR:

SHORELINE PROPERTIES 400 SOUTH COUNTY TRAIL SUITE A-207 EXETER, R.I. 02822

PREPARED BY:

OCEAN STATE PLANNERS, INC. 1255 OAKLAWN AVENUE, CRANSTON, RI 02920 PHONE: (401) 463-9696 info@osplanners.com JOB NO. 9401 / DWG. NO. 9401 - (JNP)

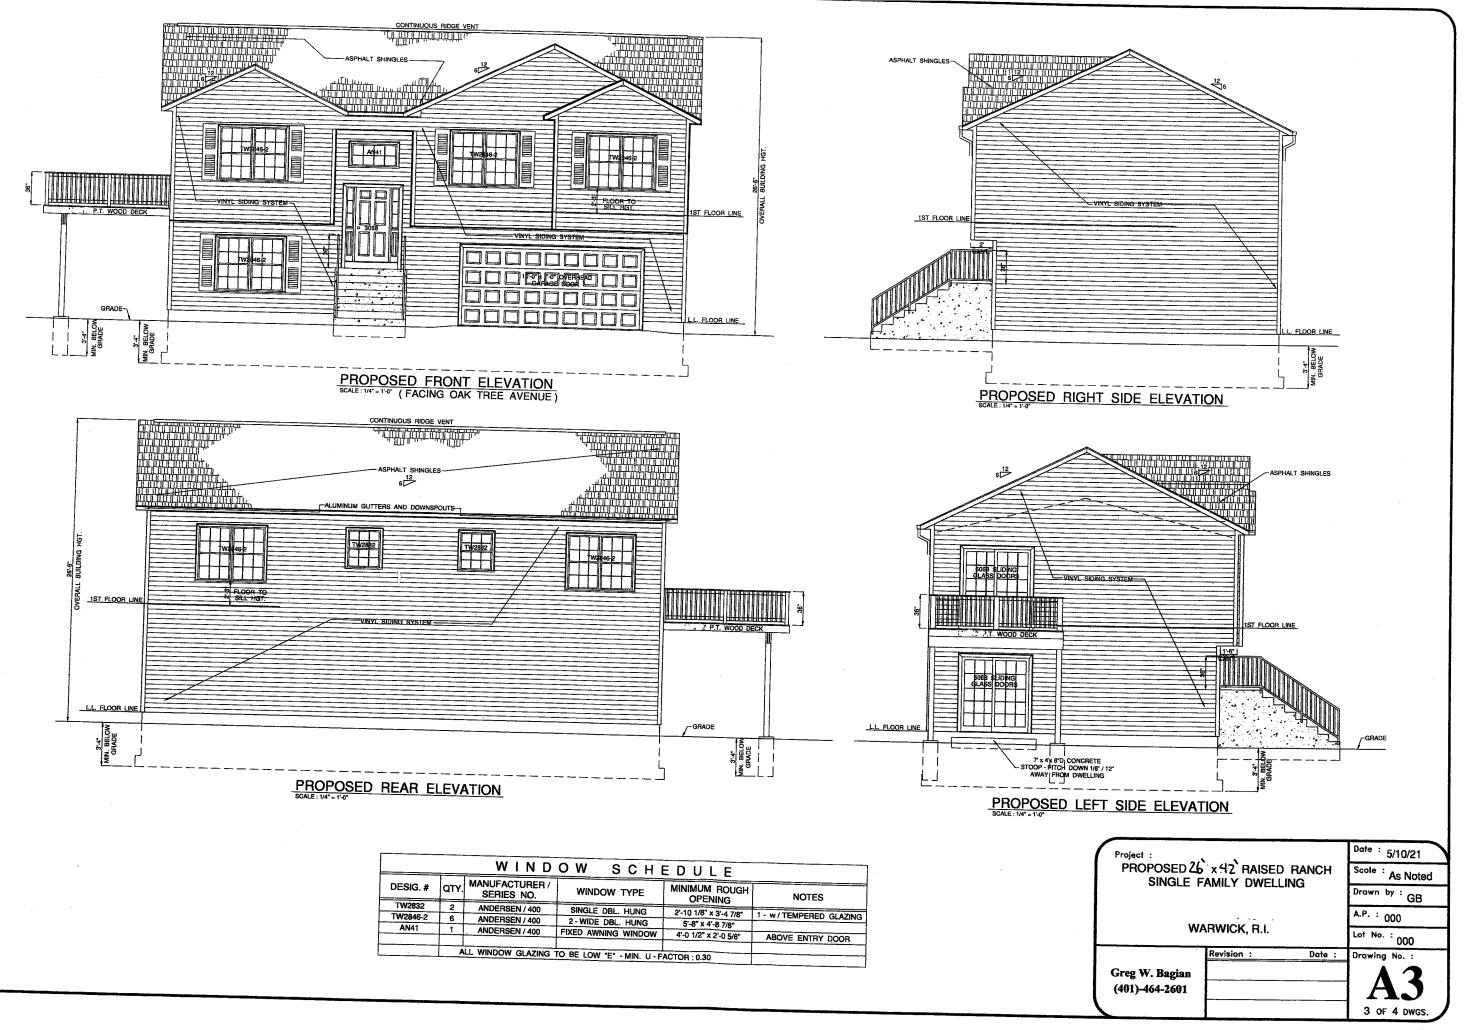
GRAPHIC SCALE / 1" = 20

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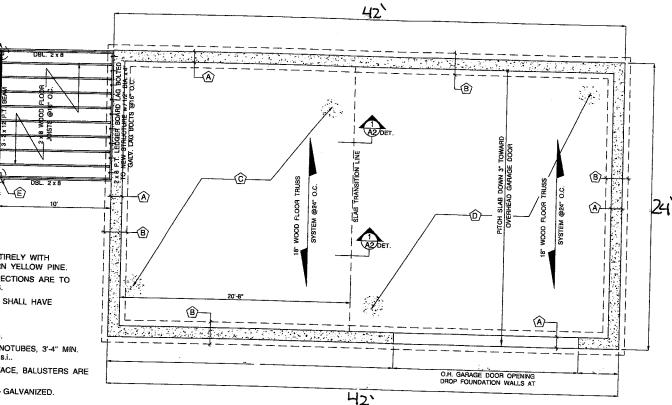
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	<u> </u>	OW SCH	EDULE	
Ω ΤΥ.	MANUFACTURER / SERIES NO.	WINDOW TYPE	MINIMUM ROUGH	NOTES
2	ANDERSEN / 400	SINCLE OR LUNC		
6				1 - w/TEMPERED GLAZING
+			5'-8" x 4'-8 7/8"	
	ANDERSEN / 400	FIXED AWNING WINDOW	4'-0 1/2" x 2'-0 5/8"	ABOVE ENTRY DOOR
	I WINDOW CLATING			
<u> </u>	LE WINDOW GLAZING	TO BE LOW "E" - MIN. U - F	ACTOR : 0.30	
	2 6 1	QTY. MANUFACTURER / SERIES NO. 2 ANDERSEN / 400 6 ANDERSEN / 400 1 ANDERSEN / 400	QTY. MANUFACTURER / SERIES NO. WINDOW TYPE 2 ANDERSEN / 400 SINGLE DBL. HUNG 6 ANDERSEN / 400 2 - WIDE DBL. HUNG 1 ANDERSEN / 400 FIXED AWNING WINDOW	QTY. MANUFACTURER / SERIES NO. WINDOW TYPE MINIMUM ROUGH OPENING 2 ANDERSEN / 400 SINGLE DBL. HUNG 2'-10 1/8" x 3'-4 7/8" 6 ANDERSEN / 400 2-WIDE DBL. HUNG 5'-8" x 4'-8 7/8"



NEW DECK NOTES :

- 1. NEW LEFT SIDE DECK SHALL BE CONSTRUCTED ENTIRELY WITH PRESSURE TREATED LUMBER NO. 1/NO. 2 SOUTHERN YELLOW PINE.
- 2. ALL WOOD FLOOR JOIST TO LEDGER BOARD CONNECTIONS ARE TO BE DONE WITH GALVANIZED METAL JOIST HANGERS.

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- ALL WOOD FLOOR JOIST TO 3-2x12 OUTER BEAM SHALL HAVE GALVANIZED HURRICANE TIE CONNECTIONS.
- 4. DECKING : 1 x 6 COMPOSITE
- 5. DECK SUPPORT POSTS : 6" x 6" PRESSURE TREATED.
- DECK SUPPORT FOOTINGS : 16" DIA. CONCRETE SONOTUBES, 3'4" MIN. DEPTH BELOW GRADE, CONCRETE STRENGTH 3,000 p.s.i.. GUARDRAILS : ARE TO BE 36" HGT. FROM DECK SURFACE, BALUSTERS ARE TO BE 2" x 2" SPACED AT 5" O.C..
- 8. ALL DECK CONNECTION BOLTS ARE TO BE 1/2" DIA. GALVANIZED.

PROPOSED FOUNDATION / FIRST FLOOR / LEFT SIDE DECK FRAMING PLAN

GENERAL FOUNDATION NOTES :

- 1. ALL NEW CONCRETE STRENGTH SHALL BE 3,000 p.s.i..
- 2. 1/2" ANCHOR BOLTS @48" O.C. ANCHOR BOLTS ARE TO BE SET AT A MAXIMUM OF 12" FROM ALL CORNERS
- 3. INSTALL 1/2" EXPANSION JOINT WELASTOMERIC SEALANT AT ALL CONCRETE SLAB / FOUNDATION ABUTTMENTS.
- 4. INSTALL 6 MIL. POLYETHYLENE VAPOR / MOISTURE BARRIER BELOW ALL CONCRETE FLOOR SLABS.
- 5. INSTALL 2" R 10 POLYSTYRENE INSULATION BOARD ON INTERIOR OF ALL FOUNDATION WALLS FROM UNDERSIDE OF FLOOR SLAB DOWN TO TOP OF CONCRETE FOOTING.
- 6. APPLY BITUMINOUS DAMP PROOFING ON EXTERIOR OF ALL FOUNDATION WALLS FROM GRADE DOWN TO TOP OF CONCRETE FOOTING.



- (A) 10" CONCRETE FOUNDATION WALL 4' FORM.
- (B) 2'-0" WIDE X 1'-0" DEEP CONTINUOUS CONCRETE FOOTING SET AT 3'-4" MINIMUM BELOW GRADE.
- C 4" CONCRETE FLOOR SLAB W/FIBER MESH.
- D 4" CONCRETE FLOOR SLAB WFIBER MESH PITCH DOWN 3" TOWARD O.H. GARAGE DOORS.
- (E) 16" DIA. CONCRETE SONOTUBE FOOTINGS FOR RIGHT SIDE DECK SUPPORT SET AT A MINIMUM OF 3'-4" BELOW GRADE.

