



#### EROSION CONTROL, SOIL STABILIZATION AND SEDIMENT CONTROL PLAN

- PRIOR TO THE COMMENCEMENT OF ANY CLEARING, GRUBBING, DEMOLITION OR EARTHWORK ACTIVITY, TEMPORARY EROSION AND SEDIMENT CONTROL MEASURES AS INDICATED ON THE PLANS ARE TO BE INSTALLED BY THE CONTRACTOR
- CONSTRUCTION ACCESS STABILIZATION ENTRANCE PADS ARE TO BE INSTALLED PRIOR TO THE COMMENCEMENT OF SITE GRUBBING OR EARTHWORK ACTIVITY.
- 3. THE PROJECT CONSTRUCTION SEQUENCE, TO THE EXTENT PRACTICAL, SHOULD REQUIRE THE INSTALLATION OF DOWN GRADE AND OFF SITE STORM DRAINAGE SYSTEM IMPROVEMENTS BEFORE THE START OF SITE GRUBBING AND EARTHWORK ACTIVITY.
- TEMPORARY SITE SLOPE TREATMENTS FOR SOIL STABILIZATION SHALL CONSIST OF STRAW, FIBER MULCH, RIP RAP OR PROTECTIVE COVERS SUCH AS MAT OR FIBER LINING (BURLAP, JUTE, FIBERGLASS NETTING, AND EXCELSIOR OR EQUAL PRODUCTS). THESE AND OTHER ACCEPTABLE MEASURES SHALL BE INCORPORATED INTO THE SITE WORK AS WARRANTED OR AS ORDERED BY THE ENGINEER.
- 5. CONSTRUCTION SITES ARE DYNAMIC, THE CONTRACTOR IS RESPONSIBLE FOR THE INSTALLATION AND OR MOVEMENT AND MAINTENANCE OF EROSION CONTROLS, SOIL STABILIZATION AND SEDIMENT CONTROL MEASURES AS NEEDED TO MAXIMIZE THE INTENT OF THE PLAN FOR ALL SITE CONDITIONS THROUGHOUT THE CONSTRUCTION.
- 6. THE CONTRACTOR SHALL BE RESPONSIBLE FOR PERIODIC INSPECTION, MAINTENANCE, REPAIR, AND REPLACEMENT OF EROSION CONTROLS, SOIL STABILIZATION AND SEDIMENT CONTROL DEVICES UNTIL AN ACCEPTABLE PERMANENT VEGETATIVE GROWTH IS ESTABLISHED. THE CONTRACTOR SHALL MAINTAIN A DETAIL LOG OF ALL EROSION CONTROL INSPECTIONS, COMPLAINTS RELATED TO EROSION OR SEDIMENT AND CORRECTIVE REMEDIAL MEASURES TAKEN THROUGHOUT THE COURSE OF THE PROJECT CONSTRUCTION.
- 7. SOIL EROSION AND SEDIMENT CONTROL IS NOT LIMITED TO DAMAGES CAUSED BY WATER BUT ALSO INCLUDES EROSION AND SEDIMENT RESULTING FROM WINDS. MEASURES, SUCH AS TEMPORARY GROUND COVERS, WATER AND CALCIUM APPLICATIONS ARE TO BE UNDERTAKEN AS NEEDED TO MINIMIZE WIND
- 8. STOCK PILES OF EARTH MATERIALS SHALL NOT BE LOCATED NEAR WATERWAYS OR WETLANDS. STOCK PILES SHALL HAVE SIDE SLOPES NO GREATER THAN THIRTY PERCENT (30%). STOCK PILES SHALL BE SURROUNDED ON THE DOWN GRADIENT OF THE EXISTING GROUND SURFACE BY STRAW BALES OR COMPOST FILTER SOCK. THE STOCK PILES SHALL ALSO BE SEEDED OR STABILIZED IN SOME MANOR TO
- 9. THE SMALLEST POSSIBLE SITE AREAS SHALL BE DISTURBED OR EXPOSED AT ONE TIME AND DENUDED SLOPES OR WORK AREAS SHALL NOT BE LEFT EXPOSED FOR EXCESSIVE PERIODS OF TIME, SUCH AS INACTIVE PERIODS OR SITE WORK SHUT DOWNS.
- 10. TO THE EXTENT POSSIBLE, ALL DISTURBED AREAS MUST BE SEEDED OR STABILIZED WITHIN THE CONSTRUCTION SEASON. STABILIZATION OF ONE FORM OR ANOTHER SHALL BE ACHIEVED WITHIN FIFTEEN (15) DAYS OF FINAL GRADING.
- 12. EXPOSED STEEP OR LONG SLOPES SHOULD BE TREATED WITH "CRIMPING" OR "TRACKING" TO REDUCE EROSION AND SEDIMENT AND TO TACK DOWN SEEDING OR MULCH APPLICATIONS.
- 13. IF CONCRETE IS TO BE USED ON SITE, THE CONTRACTOR MUST ESTABLISH AND MAINTAIN SPECIFIC
- THE CONTRACTOR IS RESPONSIBLE FOR PROVIDING AND MAINTAINING COLLECTION AND STORAGE LOCATIONS ON—SITE FOR ALL CONSTRUCTION DEBRIS AND TRASH SO THAT THIS MATERIAL DOES NOT BECOME A NEIGHBORHOOD NUISANCE.
- 15. EXISTING TREES AND VEGETATION WILL BE RETAINED WHENEVER FEASIBLE.
- 16. SITE SOIL EROSION AND SOIL STABILIZATION AND SEDIMENT CONTROLS MUST CONFORM TO ALL REQUIREMENTS OF THE APPLICABLE LOCAL COMMUNITY ORDINANCES AND STATE REGULATIONS.

RAIN GARDEN SIZING=4" DEEP "A" SOILS 717 SF  $\times$  0.19 = 137 SF REQ.; 152 SF PROV. OK

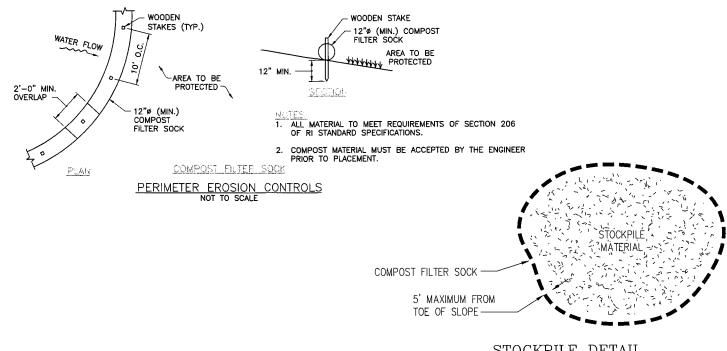

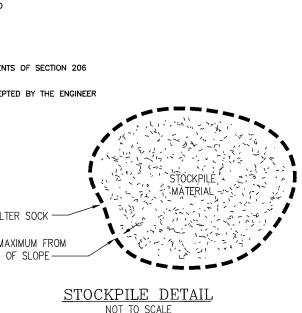

CONSTRUCTION ENTRANCE FILTER FABRIC

	MATERIALS SIZE		
SQUARE MESH SIEVES	2" CRUSHED STONE OR GRAVEL	ASTM C-33 NO. 2	ASTM C-33 NO. 3
	% FINER	% FINER	% FINER
2-1/2 INCHES	100	90-100	100
2 INCHES	95-100	35-70	90-100
1-1/2 INCHES	30-55	0-15	35-70
1-1/4 INCHES	0-25	_	-
1 INCH	0-5	-	0-15
3/4 INCH	_	0-5	_
1/2 INCH	-	-	0-5
3/8 INCH	-	-	_
	NOTE:	-	

STABILIZATION PAD TO BE IN CONFORMANCE WITH STANDARDS SET FORTH IN THE "CONNECTICUT GUIDELINES FOR SOIL & SEDIMENT CONTROL".

STONE STABILIZATION PAD @ CONSTRUCTION ENTRANCES NOT TO SCALE

### BMP REQUIRED MAINTENANCE:

#### MONTHLY:

INSPECT AND REMOVE ANY TRASH REMOVE ANY INVASIVE SPECIES PLANTS


#### ANNUALLY:

MULCH- SPRING, AS NEEDED REPLACE ANY DEAD VEGETATION-SPRING REMOVE DEAD VEGETATION-FALL OR SPRING PRUNE-SPRING

#### AS NEEDED:


REPLACE SOIL MEDIA AND PLANTS WHEN PONDING DOES NOT SUBSIDE WITHIN 72 HRS (CAREFUL MAINTENANCE SHOULD PROLONG THIS

\*ALL PLANT MATERIAL SHALL BE WATERED AND MAINTAINED BY THE OWNER TO ASSURE THAT SUITABLE GROWTH HAS BEEN ESTABLISHED.

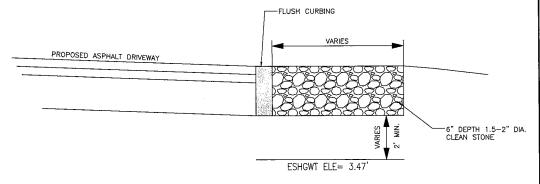

#### INFILTRATION TRENCH CROSS SECTION NOT TO SCALE

INFILTRATION TRENCH SIZING=6" DEEP "A" SOILS  $834 \text{ SF } \times 0.24 = 200 \text{ SF REQ.}; 227 \text{ SF PROV. OK}$ 

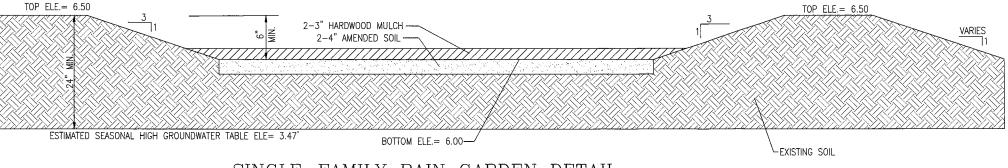

## SINGLE-FAMILY RAIN GARDEN DETAIL

NOT TO SCALE

- (1) MULCH SHALL CONSIST OF NON-DYED, AGED AND SHREDDED HARDWOOD MULCH
- (2) AMENDED SOIL SHALL CONSIST OF A 器 MIX OF EXCAVATED NATIVE SOIL AND MATURE ORGANIC COMPOST.
- (3) RAIN GARDEN AREA TO BE PROTECTED FROM CONSTRUCTION TO PREVENT COMPACTION AND SURROUNDED BY COMPOST FILTER SOCK UNTIL UPSLOPE AREAS ARE STABILIZED.
- (4) DESIGN AND INSTALLATION GUIDELINES SHALL CONFORM TO THE STATE OF RHODE ISLAND STORMWATER MANAGEMENT GUIDANCE FOR INDIVIDUAL SINGLE-FAMILY RESIDENTIAL LOT DEVELOPMENT.

#### PLANT SPECIES TO BE USED

## BOTANICAL NAME

ASTER DIVARICATUS WHITE WOOD ASTER IRIS VERSICOLOR BLUE FLAG IRIS LOBELIA CARDINALIS CARDINAL FLOWER OSMUNDA CINNAMOMEA CINNAMON FERN

\*PLANT SPECIES IN ONE GALLON CONTAINERS TO BE INSTALLED AT 2' O.C. IN GROUPS OF THREE WITHIN THE BIORETENTION AREAS, THE SWALE AND THE FLOODPLAIN COMPENSATION AREA.

## DRAWING ISSUE:

☐ CONCEPT CUSTOMER APPROVAL X PERMITTING CONSTRUCTION AS-BUILT

OTHER: ONLY PLANS ISSUED FOR CONTRUCTION SHALL BE USED FOR CONSTRUCTION

## REGISTERED PROFESSIONAL ENGINE **REVISIONS** DATE DRWN CHKE

PRINCIPE COMPANY, INC. ENGINEERING DIVISION 27 SAKONNET RIDGE DRIVE TIVERTON, RI 02878 401.816.5385 ESTABLISHED IN 1981

DETAILS-1

CRMC SUBMISSION PLAN 240 SHAWOMET AVENUE AP 334 LOT 14

WARWICK, RHODE ISLAND

SCALE: AS NOTED SHFFT NO: 3 of 3 DRAWN BY: KAB DESIGN BY: KAB CHECKED BY: TJP DATE: 03/14/2023 PROJECT NO.: CRMC-2022-3

**RENNOVATION AND ADDITION OF:** 

# **240 SHAWOMET AVE SCHEMATIC DESIGN NOT FOR CONSTRUCTION 20 FEBRUARY 2023**

	DRAWING LIST
Sheet Number	Sheet Name
01 - GENERAL	
G0.00	COVER
G0.01	PROJECT INFORMATION
G1.00	ZONING PLANS & SUMMARY
02 - EXISTING CON	DITIONS
EX1.01	EXISTING FIRST FLOOR PLAN
EX1.02	EXISTING SECOND FLOOR PLAN
EX1.03	EXISTING ROOF PLAN
EX3.01	EXISTING EXTERIOR ELEVATIONS
EX3.02	EXISTING EXTERIOR ELEVATIONS
EX4.01	EXISTING BUILDING SECTION
EX12.01	EXISTING 3D VIEWS
04 - PROPOSED	
A1.01	FIRST FLOOR PLAN
A1.02	SECOND FLOOR PLAN
A1.03	THIRD FLOOR PLAN
A1.04	ROOF PLAN
A3.01	EXTERIOR ELEVATIONS
A3.02	EXTERIOR ELEVATIONS
A4.01	BUILDING SECTIONS
A12.01	EXTERIOR 3D VIEWS



MECHANICAL, ELECTRICAL, AND PLUMBING

TO BE **PERMITTED DESIGN BUILD** 





Pacific-Visions Studio LLC
Residential Design 5 Consulting

Pacific-Visions.com

©2022 Pacific-Visions Studio LLC

240 SHAWOMET AVE

SCHEMATIC DESIGN


ISSUED FOR

#### REVISIONS

	30	

DRAWN BY: VF CHECKED BY: CF SHEET SIZE: ARCH D 24" X 36"


G0.00

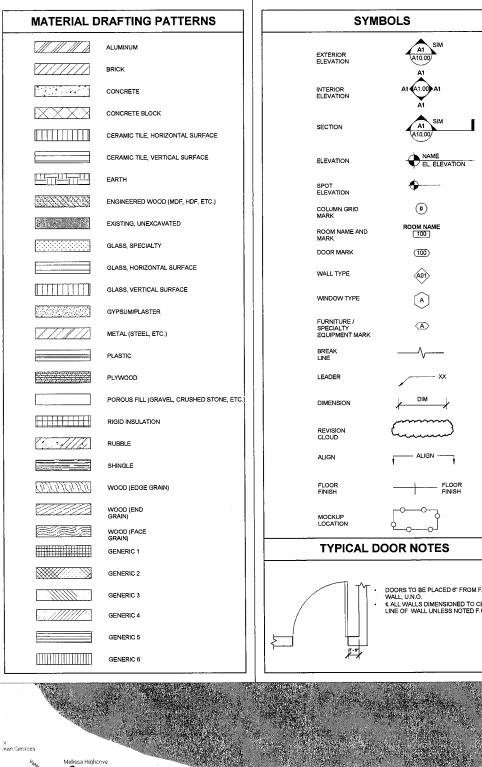

New England Heating and Cooling

0

sint Ave

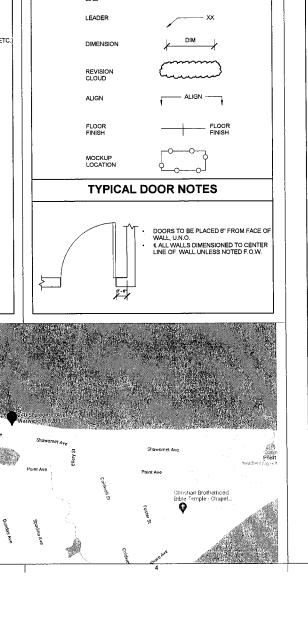

	OVE	L.E.D.	LIGHT EMITTING DIODE
ACC. AC	R CONDITION CCESS(IBLE)	L.H. LIB.	LEFT HAND UBRARY
ACT AC ADDL AD	COUSTICAL CEILING TILE ODITIONAL	LKR	LOCKER
ADJ. AD	JUSTABLE (OR) ADJACENT	LVL LOC.	LAMINATED VENEER LUMBER LOCATION
A/E AR A.F.F. AB	ICHITECT/ENGINEER IOVE FINISH FLOOR	L.O.W.	LIMIT OF WORK
AHJ AU	THORITY HAVING JURISDICTION	LVR	LOUVER
	UMINUM TERNATE	MAS.	MASONRY MATERIAL
ANOD. AN	IODIZED	MAT. MAX.	MAXIMUM
ARCH. AR A.P. AC	CCESS PANEL	MECH. MED.	MECHANICAL MEDIUM
APT AP	PROXIMATE	MED. MEMB	MEMBRANE
ASI AR	CHITECT'S SUPPLEMENTAL INSTRUCTION	MDF MIN.	MEDIUM DENSITY FIBERBOARD MINIMUM
AUTO, AU	ITOMATIC IXILIARY	MISC.	MISCELLANEOUS
		M.O. M.R.	MASONRY OPENING MOISTURE RESISTANT
BAS BU	JILDING AUTOMATION SYSTEM DARD	MTD	MOUNTED
BDRM BE	DROOM	MTL	METAL
BITUM. BIT BLOG BU	TUMINOUS JILDING	N.A. NAT.	NOT APPLICABLE NATURAL
BLKG BL	OCKING ELOW	N.C.	NOISE CRITERIA
BSMT BA	SEMENT	N.I.C. NKL	NOT IN CONTRACT NICKEL
BOT. BC BRK BR	DTTOM RICK	NOM.	NOMINAL
BRZ BR	RONZE	N.R.C. N.T.S.	NOISE REDUCTION COEFFICIENT NOT TO SCALE
BTWN BE	TWEEN		
	ABINET	O.C. OFCI	ON CENTER OWNER FURNISHED CONTRACTOR INSTALLED
C.L CE	DLD-FORMED METAL FRAMING ENTER LINE	OFOL	OWNER FURNISHED OWNER INSTALLED OPPOSITE HAND
CLG CE	ILING	O.H. OPNG	OPENING
C.J. CC	EAR(ANCE) DNTROL JOINT	OPP ORIG.	OPPOSITE ORIGINAL
CMU CC	DICRETE MASONRY UNIT	OVHD	OVERHEAD
COMP. CC	DMPRESS(ED), (ION). (IBLE)	OZ.	OUNCE
	DNCRETE DNSTRUCTION	PERP	PERPENDICULAR
CONT. CC	ONTINU(E), (OUS)	PLAM PNT	PLASTIC LAMINATE PAINT
CPT CA	DORDINATE ARPET	PTD	PAINTED
CPR CC	OPPER ERAMIC TILE	PR P.T.	PAIR PRESSURE TREATED
C.T.E. CC	DNNECT TO EXISTING	PTN PLYWD	PARTITION PLYWOOD
C.U.H. CA	ABINET UNIT HEATER	PLYWD	
	DUBLE	Q.T.	QUARRY TILE
DEMO DE DET. DE	EMO(LISH), (LITION) ETAIL	R.B.	RESILENT BASE
D.F. DF	RINKING FOUNTAIN	R.D. REF.	ROOF DRAIN REFER
DH DO	DUBLE HUNG AMETER	REFR	REFRIGERATOR
DIAG. DIA	AGONAL	REQ. RES.	REQUIRE(D) RESILIENT
DIM. DII	MENSION DWN	REV.	REVISION RIGHT HAND
DR DC	DOR DWNSPOUT	R.H. RM	ROOM
DTL DE	TAIL	R.O.	ROUGH OPENING
	RAWING UPLEX	SCHED.	SCHEDULE
		SECT.	SECTION SQUARE FEET
	ACH LEVATION	SHT	SHEET
ELEC. EL	_ECTRIC(AL)	SHTH SIM.	SHEATHING SIMILAR
	LEVATOR MERGENCY	SPEC.	SPEC (-IFIED) (-IFICATION) SUBMITTAL REVIEW LETTER
EMS ÉN	MERGENCY MANAGEMENT SYSTEM  KPANSION JOINT	SRL SQ.	SQUARE
EQ EC	QUAL	S.S. S.S.M.	STAINLESS STEEL SOLID SURFACE MATERIAL
EQUIP EX	QUIPMENT KISTING TO REMAIN	STC	SOUND TRANSMISSION COEFFICIENT
EXG EX	KISTING	STD STOR.	STANDARD STORAGE
EXT. EX	KTERIOR	STL	STEEL
	RE ALARM LOOR AREA RATIO	STRUCT. SUSP.	SUSPEND(ED)
F.C.U. FA	AN COIL UNIT	SYS.	SYSTEM
F.D. FL	LOOR DRAIN DUNDATION	T&G	TONGUE AND GROOVE
F.E. FII	RE EXTINGUISHER	TBD TEL.	TO BE DETERMINED TELEPHONE
FEC FI	RE EXTINGUISHER CABINET URNITURE, FIXTURE, AND EQUIPMENT	TEMP	TEMPORARY
FGL FI	BERGLASS	THK THR	THICK(NESS) THRESHOLD
FIXT. FI.	NISH XTURE	THRU T.O.	THROUGH TOP OF
FL. FL	LUORESCENT	TSTAT	THERMOSTAT
F.O. FA	ACE OF	TYP. TZ	TYPICAL TERRAZZO
	RE PROTECTION EET		
FTG FC	OOTING	U.H. U.N.O.	UNIT HEATER UNLESS NOTED OTHERWISE
FURN. FU	URNITURE	U.O.N.	UNLESS NOTED OTHERWISE
	AGE	VERT.	VERTICAL
GB G	ALVANIZED	V.I.F.	VERIFY IN FIELD
GL G	LASS	V.R.	VAPOR RETARDER
GLZ G	ELUE LAMINATED BEAM ELAZING	w/	WITH
GWB G	YPSUM BOARD	W.C. WD	WATER CLOSET WOOD
	ANDICAP	WIN.	WINDOW
HDF H	IGH DENSITY FIBERBOARD	Z.C.C.	ZINC COATED COPPER
HDWR H	OLLOW METAL ARDWARE	&	AND
HOR. H	IORIZONTAL IOUR	u.	7410
HT H	IBIGHT		
IN. II	NCHES		
INCL. IN	NCLUDE(D),(ING)		
INSUL. IN	NFORMATION NSULATION		
INT. IN	NTERIOR		
	ANITOR'S CLOSET		
J-BOX J	UNCTON BOX		
KIT. K	KITCHEN		
LAB. L	ABORATORY		
	AVATORY		



PO BOX 774 Newport, RI 02840

Fagan-Design.com

PV Pacific-Visions Studio LLC
Residential Design & Consulting

495 Hope Street STE 2B Bristol, RI

Pacific-Visions.com

©2022 Pacific-Visions Studio LLC

AVE 田

RENNOVATION AND ADDITION OF: 240 SHAWOME

SCHEMATIC DESIGN ISSUED FOR

NOT FOR CONSTRUCTION

240 WAF

20 FEBRUARY 2023

SCHEMATIC SET


This drawing set is for review, pricing, and coordination and should not be used for construction or permitting. All structural members to be reviewed and sized by a structural engineer.


REVISIONS

PROJECT INFORMATION

DRAWN BY: VF CHECKED BY: CF SHEET SIZE: ARCH D 24" X 36"

G<sub>0.01</sub>

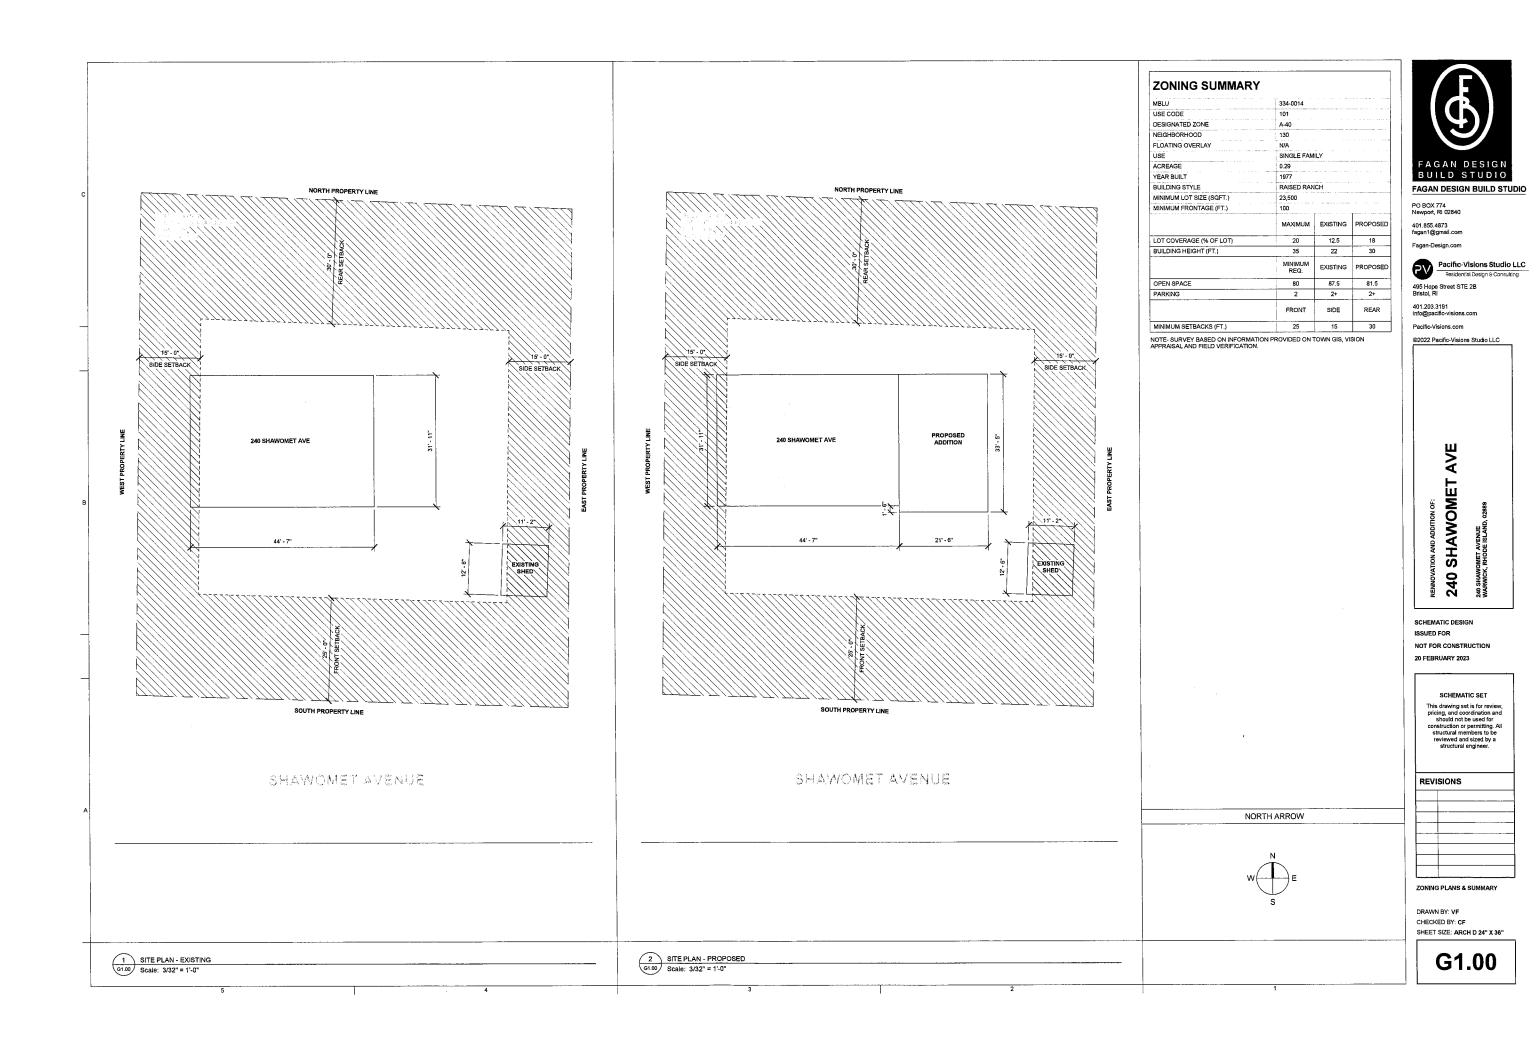

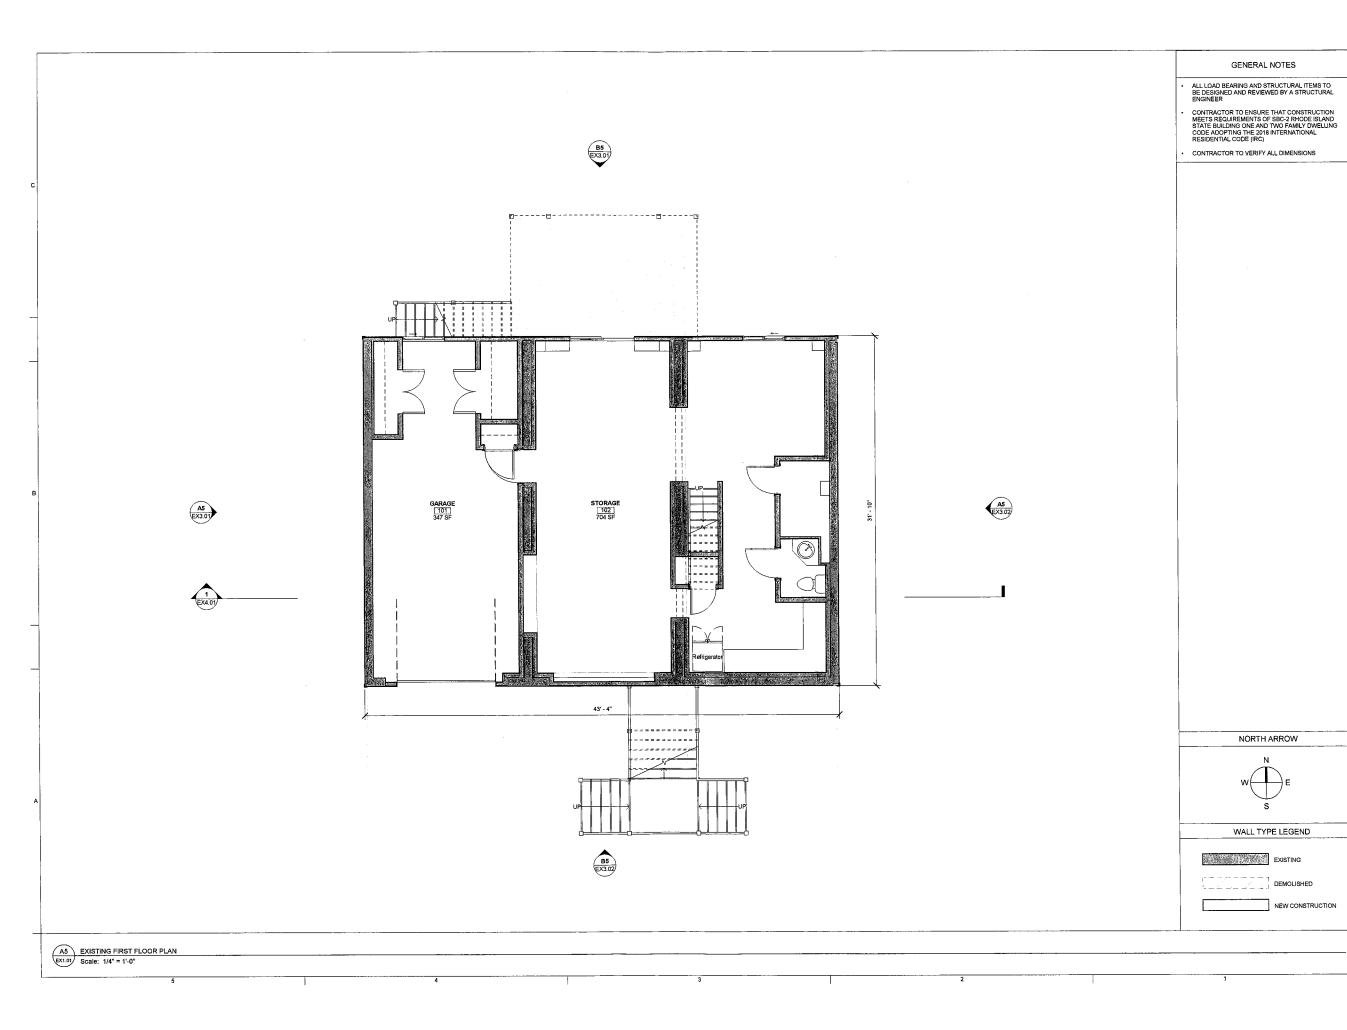

FAGAN DESIGN

BUILD STUDIO FAGAN DESIGN BUILD STUDIO

PO BOX 774 Newport, RI 02840

401.855.4873 fagan1@gmail.com

Fagan-Design.com

Pacific-Visions Studio LLC
Residential Design & Consulting 495 Hope Street STE 2B Bristol, RI

401.203.3191 info@pacific-visions.com

Pacific-Visions.com

©2022 Pacific-Visions Studio LLC

RENNOVATION AND ADDITION OF:
240 SHAWOMET AVE

SCHEMATIC DESIGN ISSUED FOR

NOT FOR CONSTRUCTION 20 FEBRUARY 2023

SCHEMATIC SET


This drawing set is for review, pricing, and coordination and should not be used for construction or permitting. All structural members to be reviewed and sized by a structural engineer.

REVISIONS

EXISTING FIRST FLOOR PLAN

DRAWN BY: VF CHECKED BY: CF SHEET SIZE: ARCH D 24" X 36"

**EX1.01** 

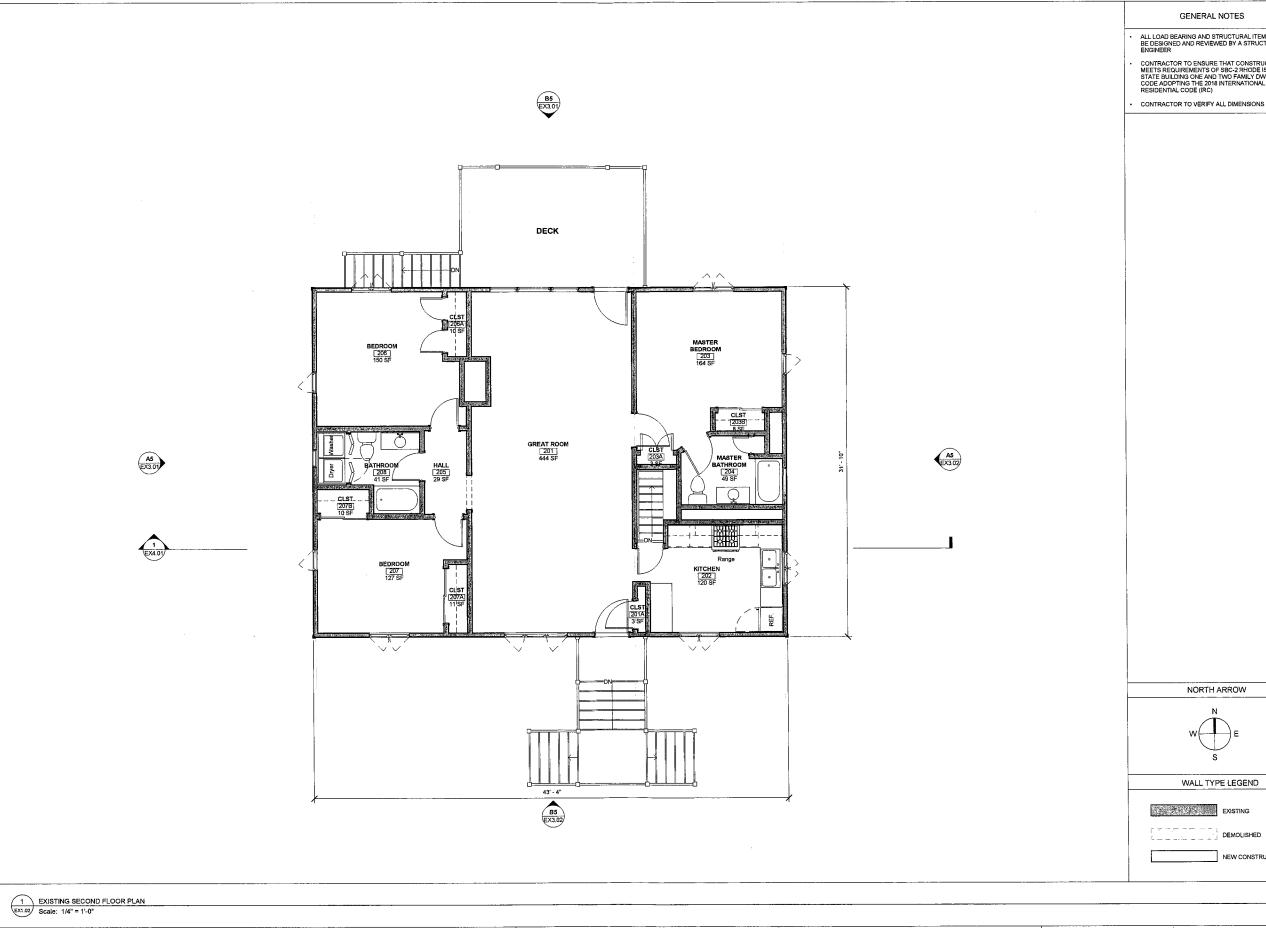

GENERAL NOTES

ALL LOAD BEARING AND STRUCTURAL ITEMS TO BE DESIGNED AND REVIEWED BY A STRUCTURAL ENGINEER

CONTRACTOR TO ENSURE THAT CONSTRUCTION MEETS REQUIREMENTS OF SBC-2 RHODE ISLAND STATE BUILDING ONE AND TWO FAMILY DWELLING CODE ADDETING THE 2018 INTERNATIONAL RESIDENTIAL CODE (IRC)

CONTRACTOR TO VERIFY ALL DIMENSIONS



FAGAN DESIGN BUILD STUDIO

PO BOX 774 Newport, RI 02840

401.855.4873 fagan1@gmail.com

Fagan-Design.com

Pacific-Visions Studio LLC

Residential Design & Consulting

495 Hope Street STE 2B Bristol, RI

401.203.3191 info@pacific-visions.com

Pacific-Visions.com

©2022 Pacific-Visions Studio LLC

AVE

RENNOVATION AND ADDITION OF:

240 SHAWOMET A

SCHEMATIC DESIGN ISSUED FOR

NOT FOR CONSTRUCTION 20 FEBRUARY 2023

SCHEMATIC SET

This drawing set is for review, pricing, and coordination and should not be used for construction or permitting. All structural members to be reviewed and sized by a structural engineer.

REVISIONS

EXISTING SECOND FLOOR PLAN

DRAWN BY: VF CHECKED BY: CF SHEET SIZE: ARCH D 24" X 36"

NEW CONSTRUCTION

**EX1.02** 

				GENERAL NOTES
				ALL LOAD BEARING AND STRUCTURAL ITEMS TO BE DESIGNED AND REVIEWED BY A STRUCTURAL ENGINEER
				CONTRACTOR TO ENSURE THAT CONSTRUCTION MEETS REQUIREMENTS OF SBC-2 RHODE ISLAND STATE BUILDING ONE AND TWO FAMILY DWELLING
		BS (EX3.01)		CODE ADOPTING THE 2018 INTERNATIONAL RESIDENTIAL CODE (IRC)
		(EX3.01)		CONTRACTOR TO VERIFY ALL DIMENSIONS
	A5		A5 EX3.02	
	A5 EX3.01		EX309	
	1 (EX4.01)			
				NORTH ARROW
			•	N
				W E
				S
			•	WALL TYPE LEGEND
		B5 (EX3.02)		EXISTING
				DEMOLISHED
				NEW CONSTRUCTION
EX1.03 Scale: 1/4" = 1'-0"				
·	5	4 3	2	1



- AND STRUCTURAL ITEMS TO REVIEWED BY A STRUCTURAL
- ENSURE THAT CONSTRUCTION ENTS OF SBC-2 RHODE ISLAND WE AND TWO FAMILY DWELLING HE 2018 INTERNATIONAL ((IRC)
- ERIFY ALL DIMENSIONS



FAGAN DESIGN BUILD STUDIO

PO BOX 774 Newport, RI 02840

Fagan-Design.com

Pacific-Visions Studio LLC
Residential Design 6 Consulting

495 Hope Street STE 2B Bristol, RI

401.203.3191 info@pacific-visions.com

Pacific-Visions.com

©2022 Pacific-Visions Studio LLC

RENNOVATION AND ADDITION OF:
240 SHAWOMET AVE

SCHEMATIC DESIGN ISSUED FOR

20 FEBRUARY 2023

NOT FOR CONSTRUCTION

SCHEMATIC SET


SCHEMATIC SET
This drawing set is for review, pricing, and coordination and should not be used for construction or permitting. All structural members to be reviewed and sized by a structural engineer.


REVISIONS

EXISTING ROOF PLAN

DRAWN BY: VF CHECKED BY: CF SHEET SIZE: ARCH D 24" X 36"

**EX1.03** 

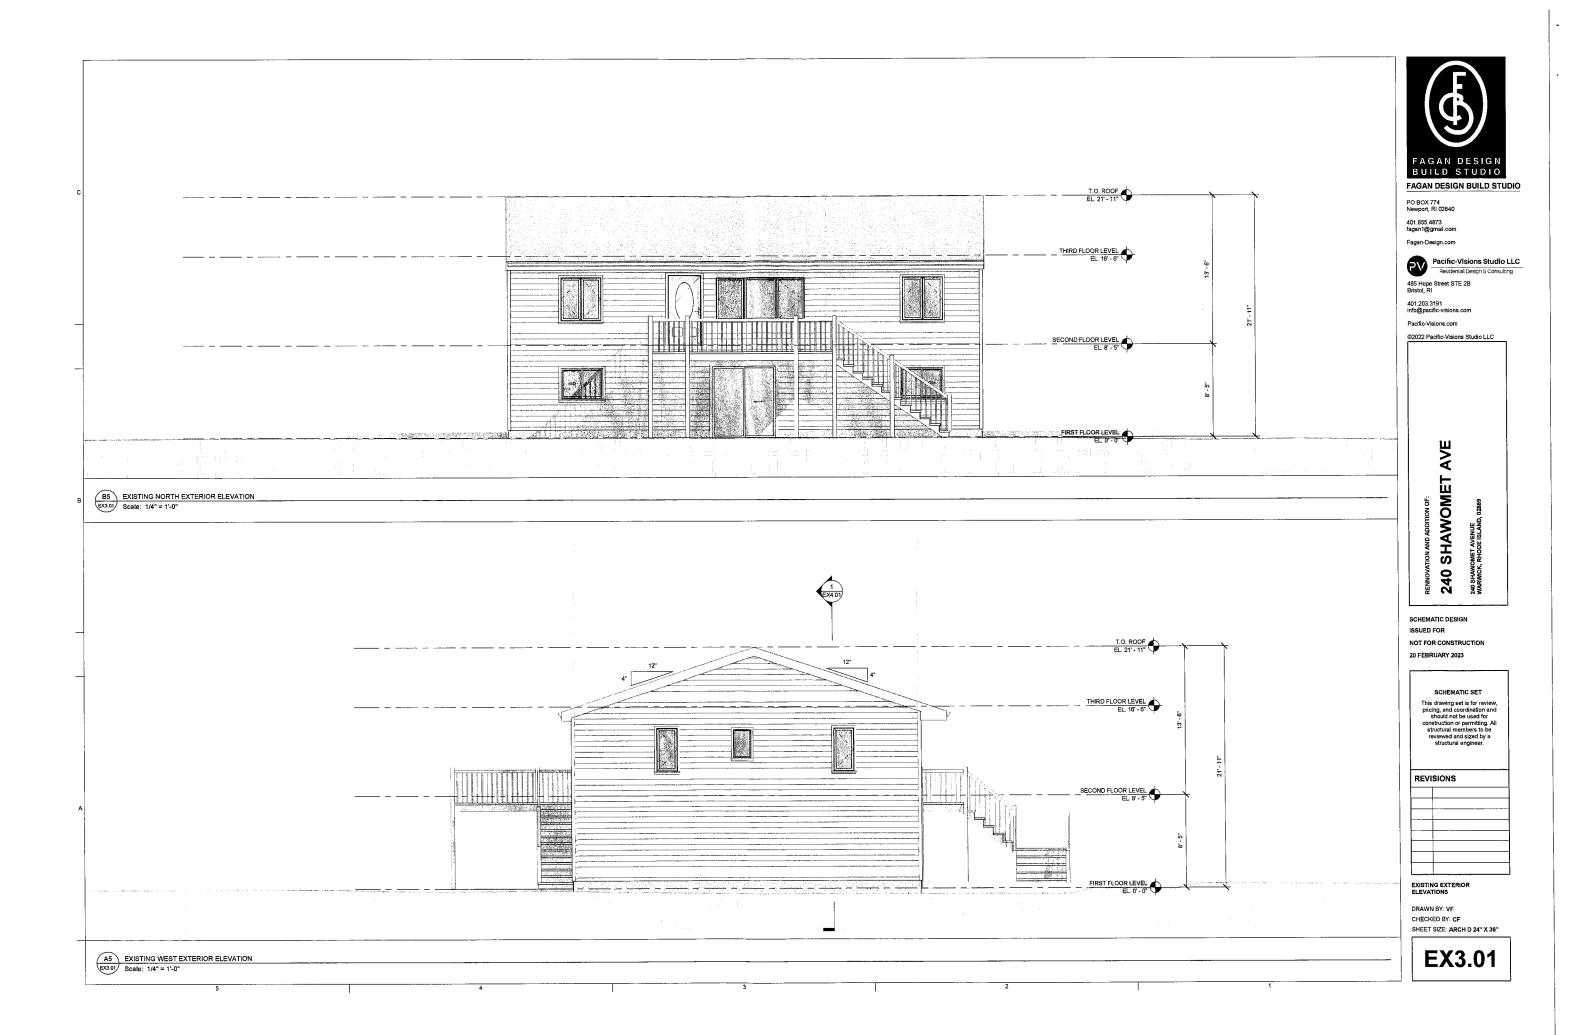

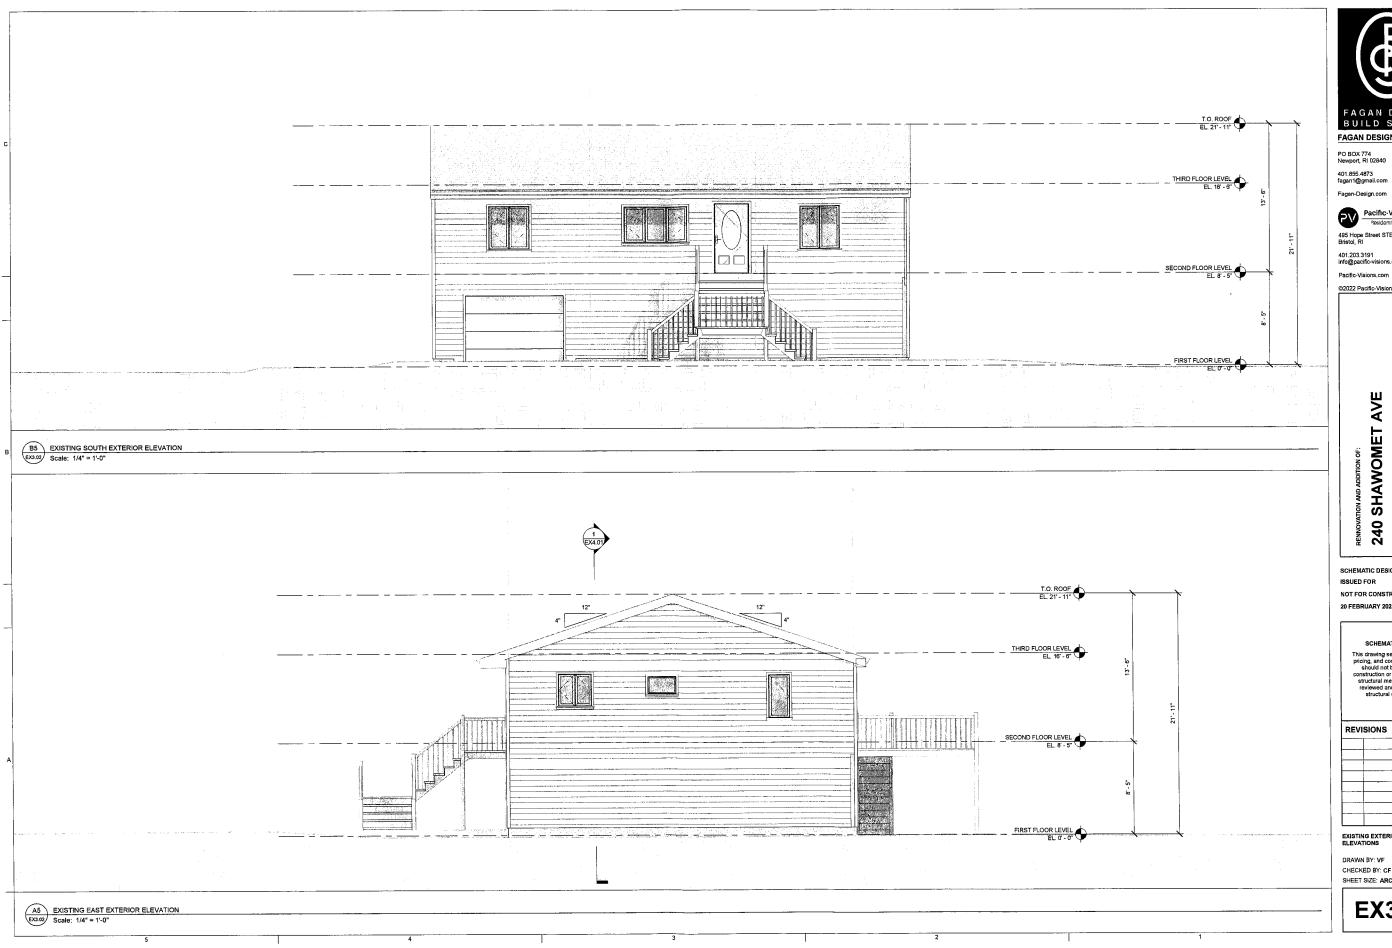

FAGAN DESIGN BUILD STUDIO

FAGAN DESIGN BUILD STUDIO

Fagan-Design.com

Pecific-Visions Studio LLC
Residential Design 5 Consulting

495 Hope Street STE 2B Bristol, RI

401.203.3191 info@pacific-visions.com

Pacific-Visions.com

©2022 Pacific-Visions Studio LLC

RENNOVATION AND ADDITION OF:

240 SHAWOMET AVE

SCHEMATIC DESIGN ISSUED FOR

NOT FOR CONSTRUCTION 20 FEBRUARY 2023


SCHEMATIC SET


This drawing set is for review, pricing, and coordination and should not be used for construction or permitting. All structural members to be reviewed and sized by a structural engineer.


EXISTING EXTERIOR ELEVATIONS

DRAWN BY: VF CHECKED BY: CF SHEET SIZE: ARCH D 24" X 36"

**EX3.02** 

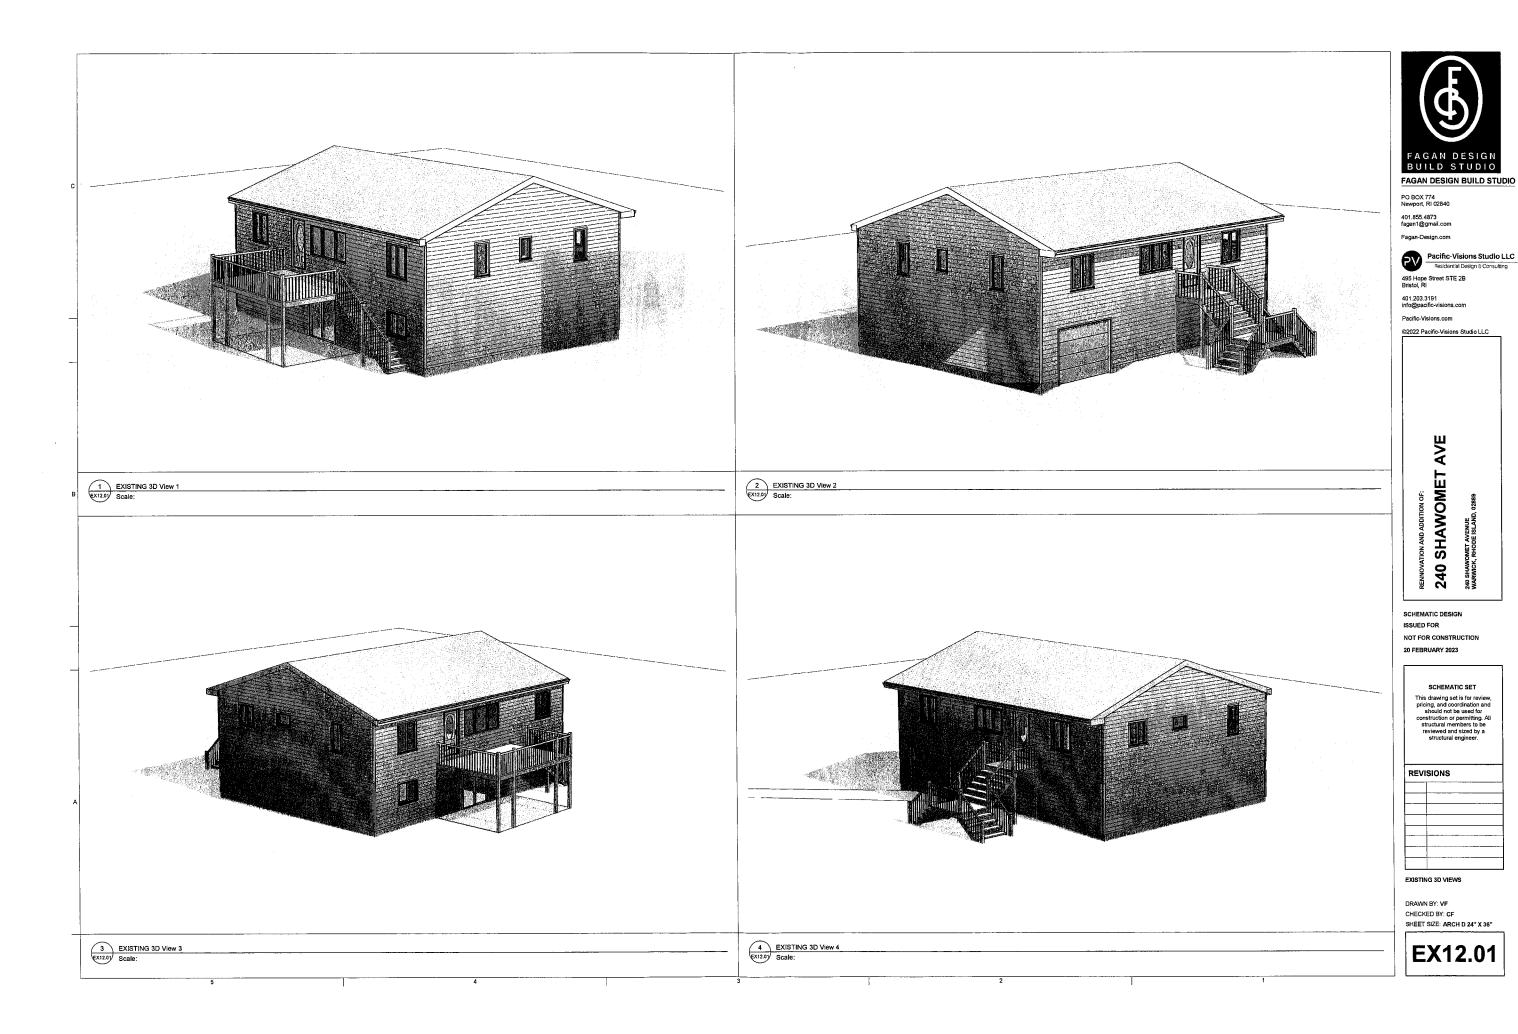

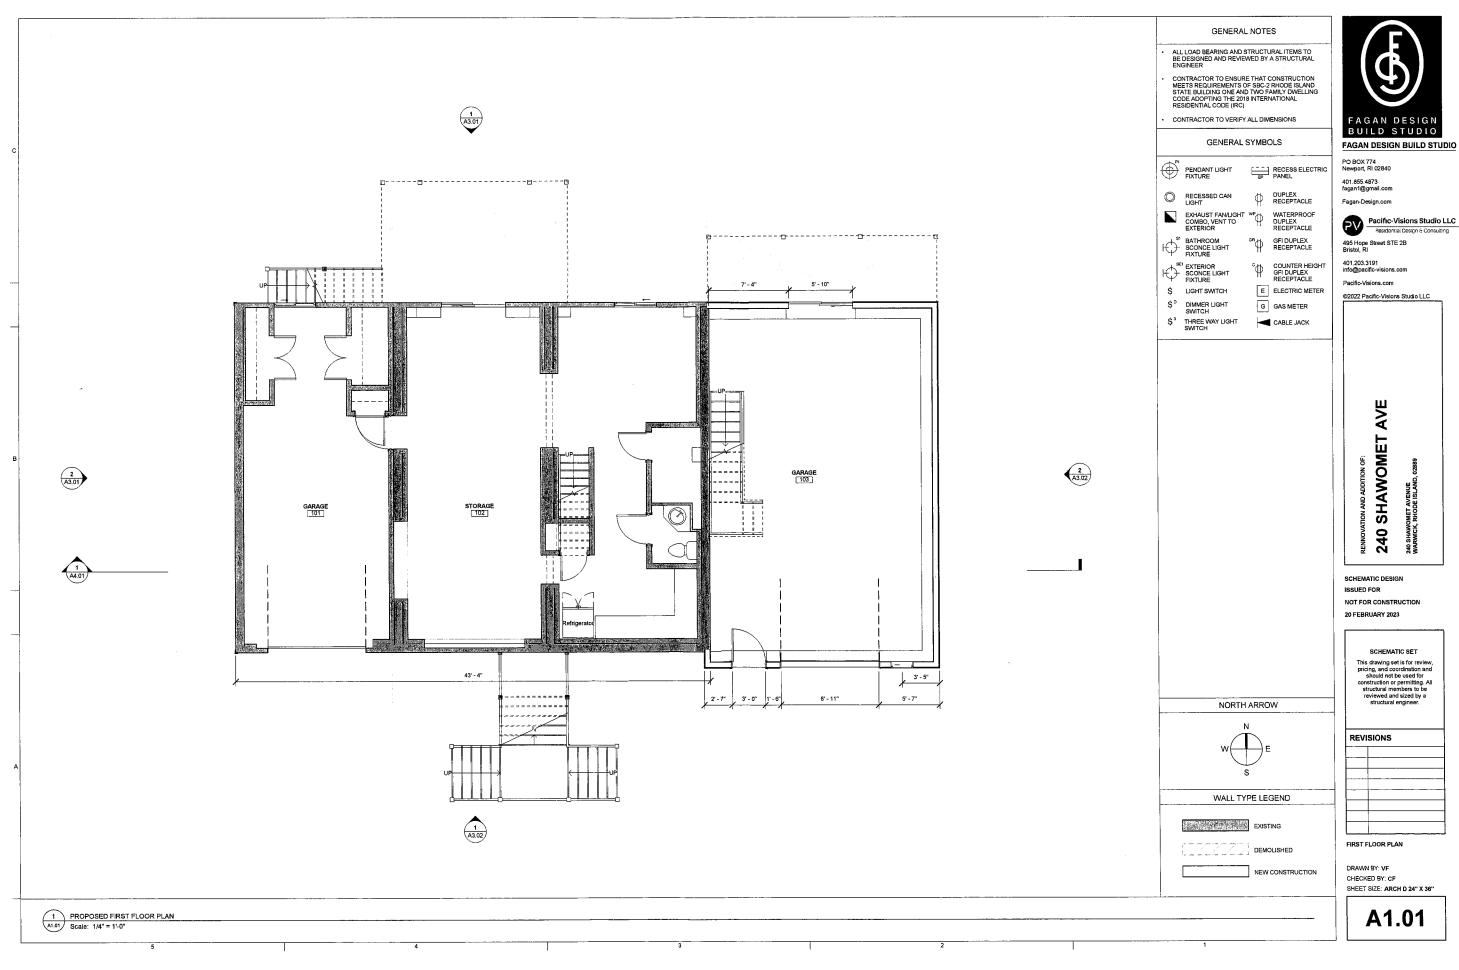

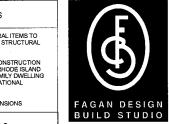

FAGAN DESIGN BUILD STUDIO

PO BOX 774 Newport, RI 02840

Fagan-Design.com

Pacific-Visions.com ©2022 Pacific-Visions Studio LLC

AVE

RENNOVATION AND ADDITION OF:

240 SHAWOMET A

SCHEMATIC DESIGN

NOT FOR CONSTRUCTION

SCHEMATIC SET


This drawing set is for review, pricing, and coordination and should not be used for construction or permitting. All structural members to be reviewed and sized by a structural engineer.


REVISIONS

FIRST FLOOR PLAN

DRAWN BY: VF CHECKED BY: CF SHEET SIZE: ARCH D 24" X 36"

A1.01

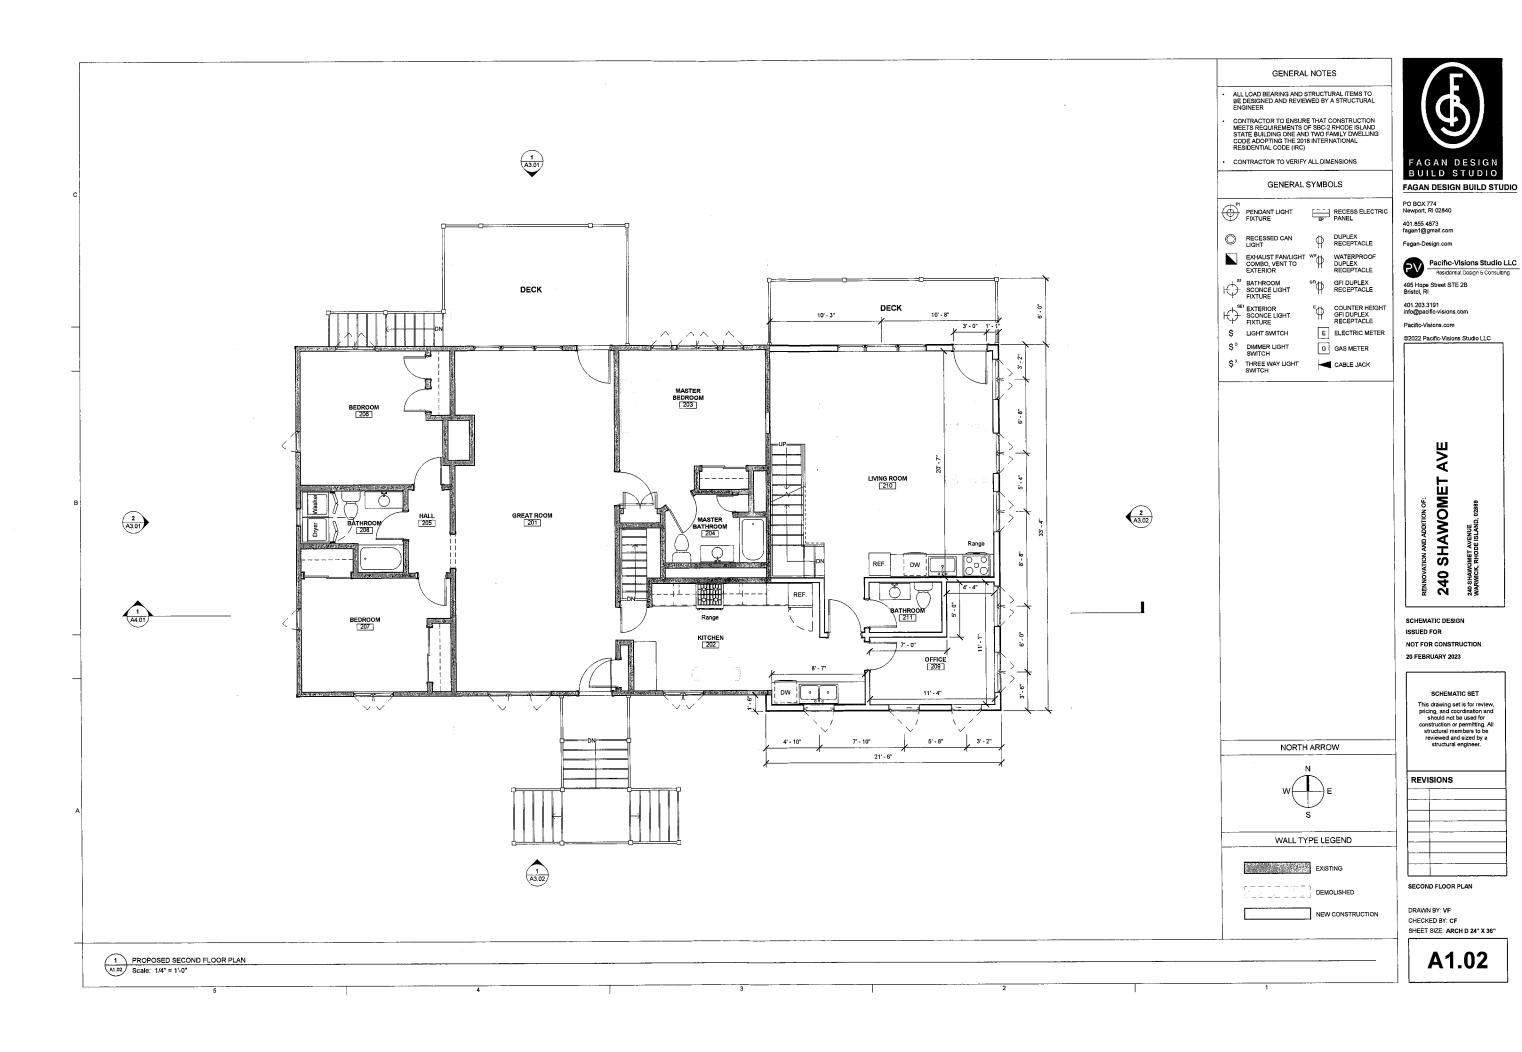

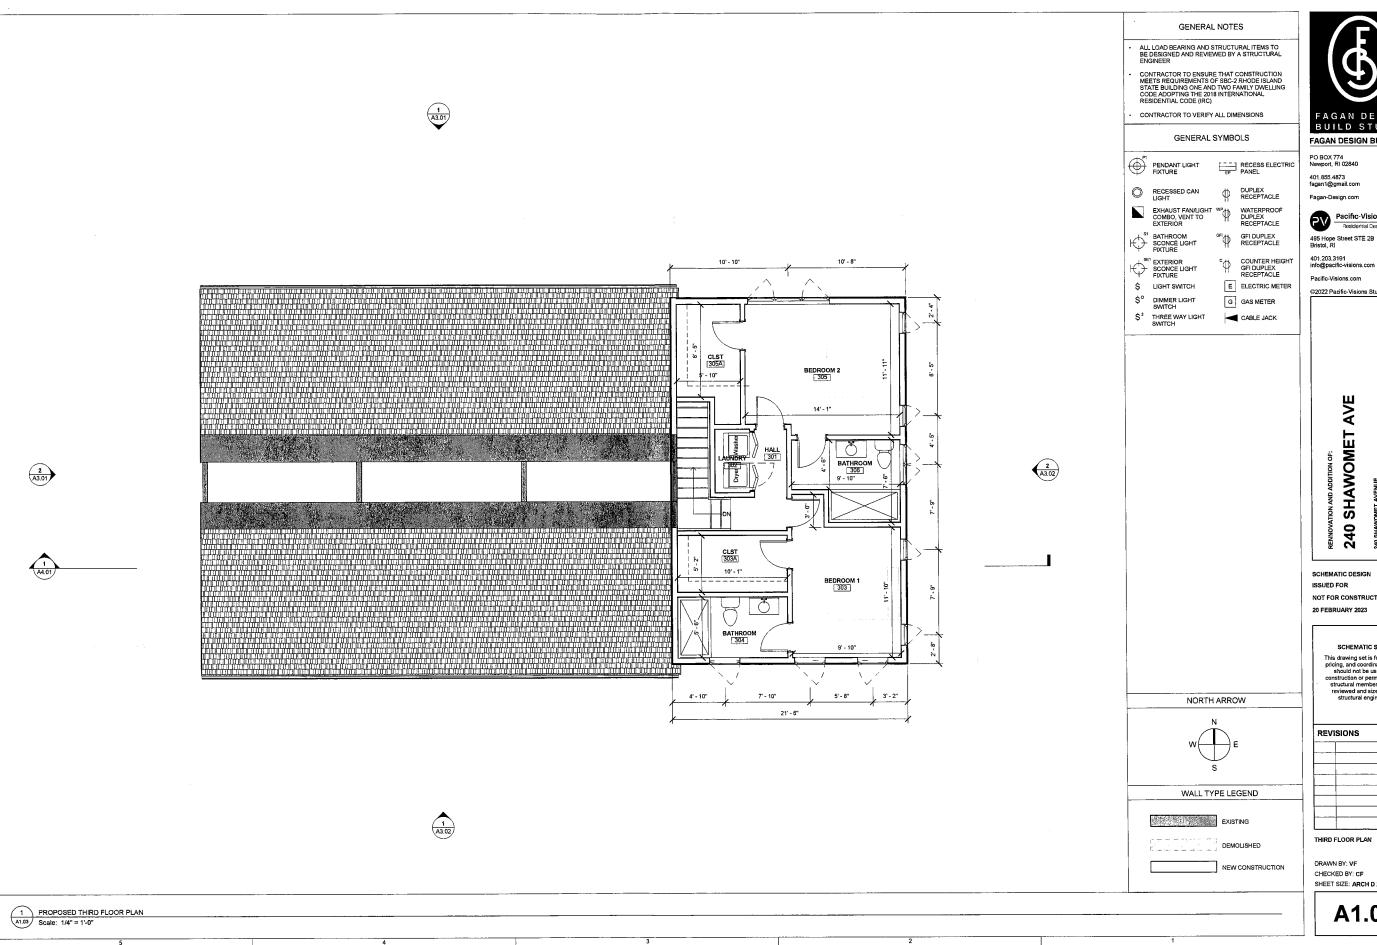

FAGAN DESIGN BUILD STUDIO

FAGAN DESIGN BUILD STUDIO

Pacific-Visions Studio LLC
Residential Design & Consulting

©2022 Pacific-Visions Studio LLC

NOT FOR CONSTRUCTION

SCHEMATIC SET

This drawing set is for review nis crawing set is for review, pricing, and coordination and should not be used for construction or permitting. All structural members to be reviewed and sized by a structural engineer.

SHEET SIZE: ARCH D 24" X 36"

A1.03

	GENERAL NOTES	Œ
	ALL LOAD BEARING AND STRUCTURAL ITEMS TO BE DESIGNED AND REVIEWED BY A STRUCTURAL ENGINEER	人成
	CONTRACTOR TO ENSURE THAT CONSTRUCTION     MEETS REQUIREMENTS OF SBC-2 RHODE ISLAND     STATE BUILDING ONE AND TWO FAMILY DWELLING     CODE ADDITING THE 2018 INTERNATIONAL	
1 (A3.01)	RESIDENTIAL CODE (IRC)  CONTRACTOR TO VERIFY ALL DIMENSIONS	FAGAN DES
· · · · · · · · · · · · · · · · · · ·	GENERAL SYMBOLS F	AGAN DESIGN BU
	PENDANT LIGHT RECESS ELECTRIC N PANEL 44	PO BOX 774 Newport, RI 02840 101.855.4873 agan1@gmail.com
	RECESSED CAN DUPLEX RECEPTACLE F:	Fagan-Design.com
	EXTERIOR "RECEPTACLE  STATHROOM GFI DUPLEX  SCONGE LIGHT RECEPTACLE	Residential Designation of the Property of the
	SE EXTERIOR COUNTER HEIGHT AF SCONCE LIGHT GFI DUPLEX IN	401.203.3191 nfo@pacific-visions.com
	S LIGHT SWITCH E ELECTRIC METER	Pacific-Visions.com ©2022 Pacific-Visions Stu
	\$ THREE WAY LIGHT CABLE JACK	
		111
		AVE
		MET
2 A3.01		ND ADDITION OF:    AWOM!
		SHA
		240 SHAW
		SCHEMATIC DESIGN
		ISSUED FOR NOT FOR CONSTRUCTI 20 FEBRUARY 2023
		SCHEMATIC SI This drawing set is fo pricing, and coordina should not be use
	NORTH ARROW	construction or permi structural members reviewed and sized structural engine
	N	REVISIONS
	W E	KEVISIONS
	S WALL TYPE LEGEND	
	WALL THE LEGENS	
$\frac{1}{A302}$		ROOF PLAN
	NEW CONSTRUCTION	DRAWN BY: VF CHECKED BY: CF SHEET SIZE: ARCH D 2
1 PROPOSED ROOF PLAN		A1.0
A1.04) Scale: 1/4" = 1'-0"		7,110

FAGAN DESIGN BUILD STUDIO

FAGAN DESIGN BUILD STUDIO

Fagan-Design.com PV Pacific-Visions Studio LLC
Residential Design & Consulting

Pacific-Visions.com ©2022 Pacific-Visions Studio LLC

NOT FOR CONSTRUCTION 20 FEBRUARY 2023


240 SHAWOMET AVENUE WARWICK, RHODE ISLAND, (


SCHEMATIC SET


This drawing set is for review, pricing, and coordination and should not be used for construction or permitting. All structural members to be reviewed and sized by a structural engineer.

DRAWN BY: VF CHECKED BY: CF SHEET SIZE: ARCH D 24" X 36"

A1.04

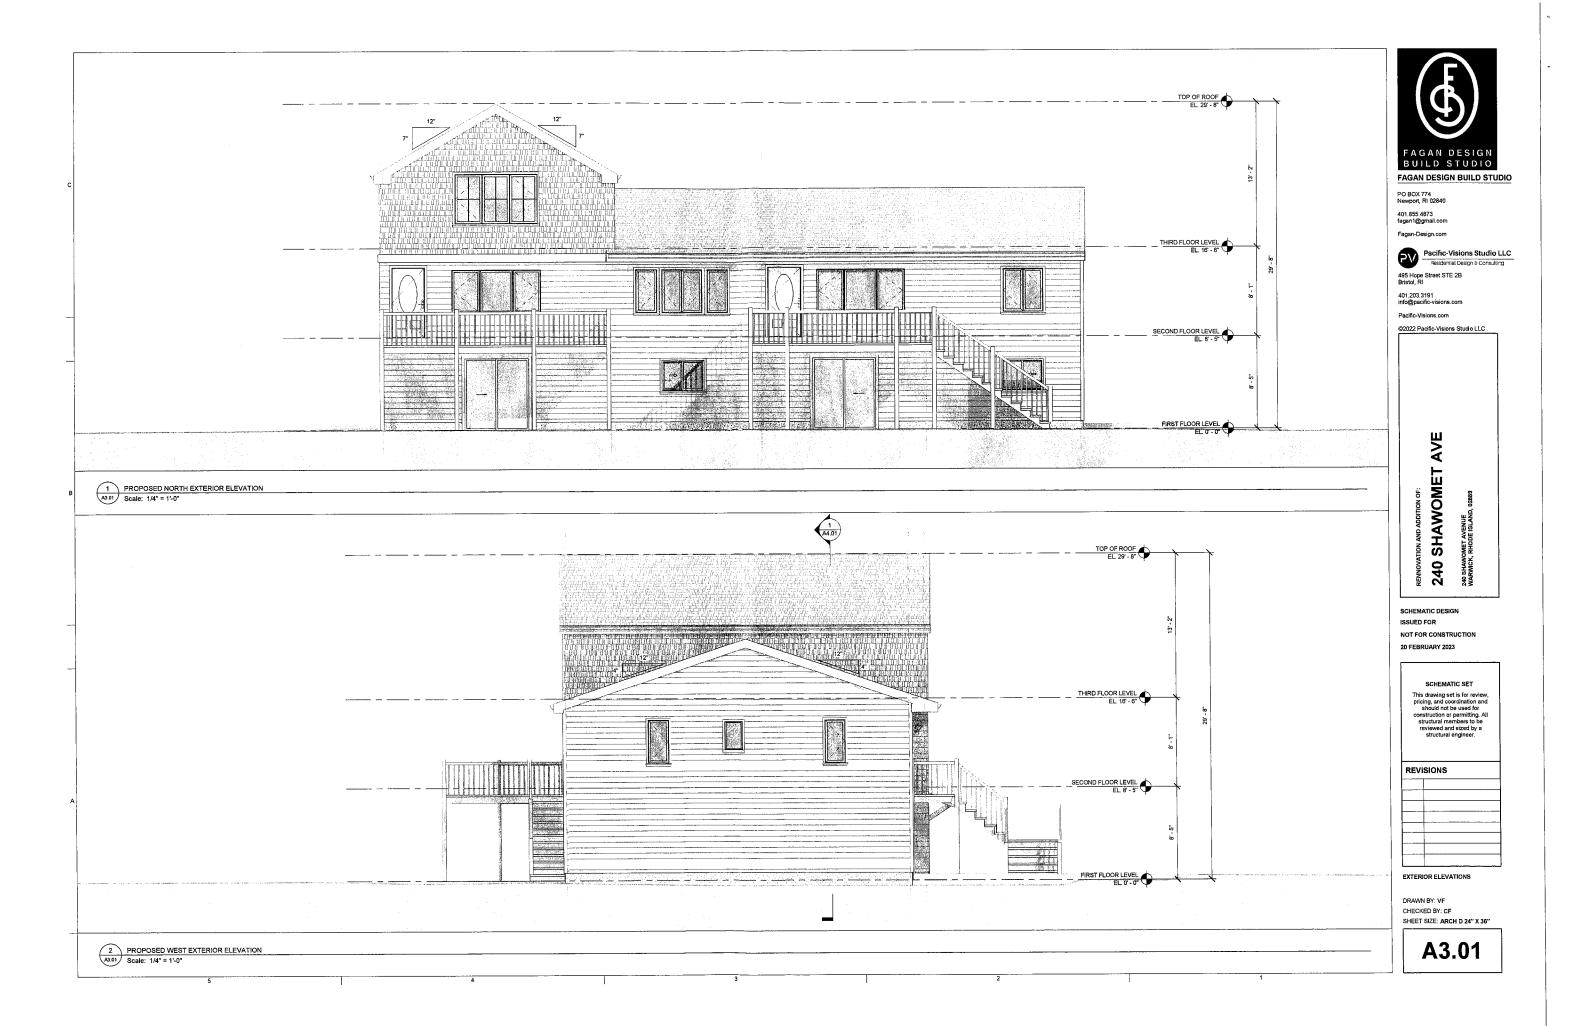

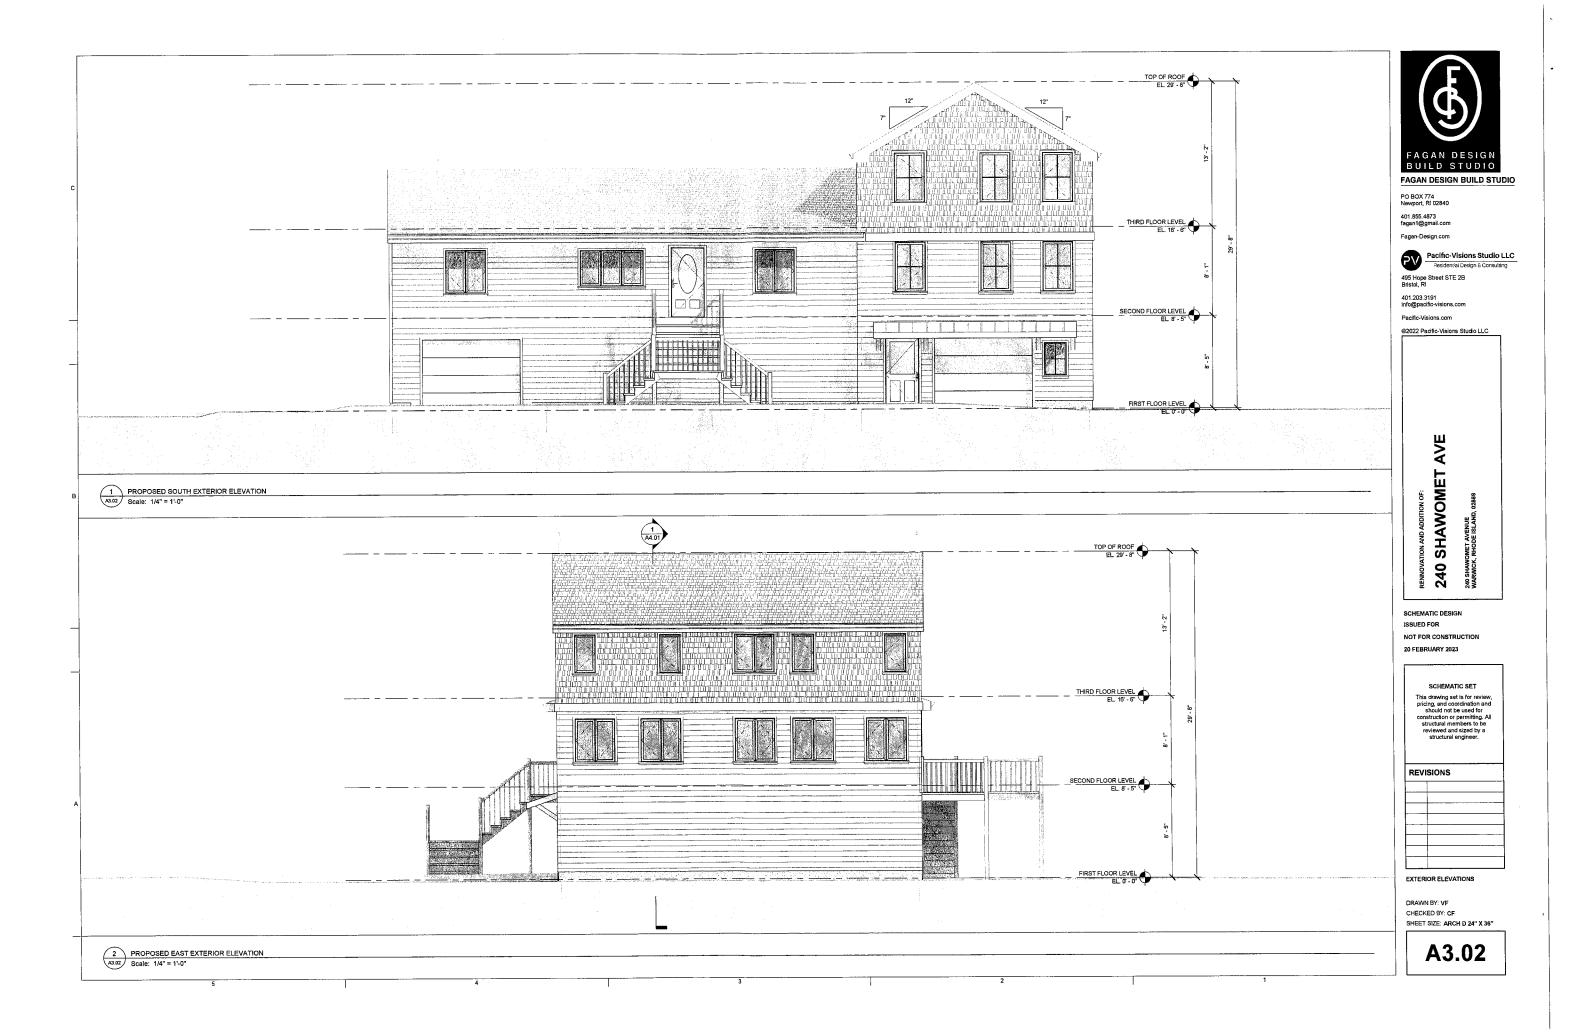

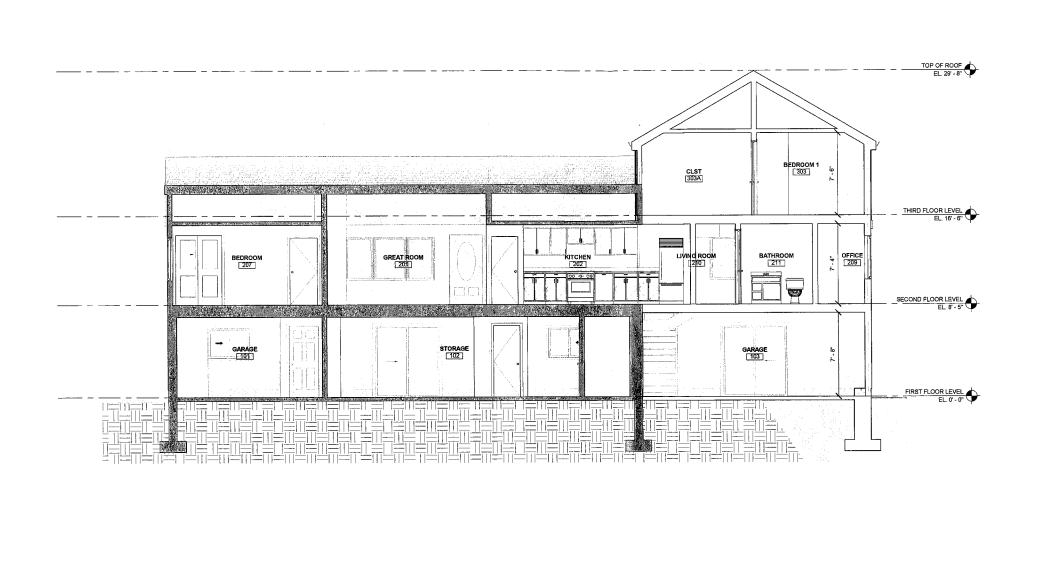

1 PROPOSED BUILDING SECTION

A4.01 Scale: 1/4" = 1'-0"

#### GENERAL NOTES

- ALL LOAD BEARING AND STRUCTURAL ITEMS TO BE DESIGNED AND REVIEWED BY A STRUCTURAL ENGINEER
- CONTRACTOR TO ENSURE THAT CONSTRUCTION MEETS REQUIREMENTS OF SBC-2 RHODE ISLAND STATE BUILDING ONE AND TWO FAMILY DWELLING CODE ADOPTING THE 2018 INTERNATIONAL RESIDENTIAL CODE (IRC)
- CONTRACTOR TO VERIFY ALL DIMENSIONS



FAGAN DESIGN BUILD STUDIO

PO BOX 774 Newport, RI 02840

401.855.4873 fagan1@gmail.com

Fagan-Design.com

Pacific-Visions Studio LLC

Residential Design 6 Consulting 495 Hope Street STE 2B Bristol, RI

401,203.3191 info@pacific-visions.com

Pacific-Visions.com

©2022 Pacific-Visions Studio LLC

AVE

RENNOVATION AND ADDITION OF:

240 SHAWOMET A

SCHEMATIC DESIGN ISSUED FOR

20 FEBRUARY 2023

NOT FOR CONSTRUCTION

SCHEMATIC SET

This drawing set is for review, pricing, and coordination and should not be used for construction or permitting. All structural members to be reviewed and sized by a structural engineer.

REVISIONS

EXISTING

[TTALLIAT] DEMOLISHED


WALL TYPE LEGEND


NEW CONSTRUCTION

DRAWN BY: VF CHECKED BY: CF SHEET SIZE: ARCH D 24" X 36"

BUILDING SECTIONS

A4.01

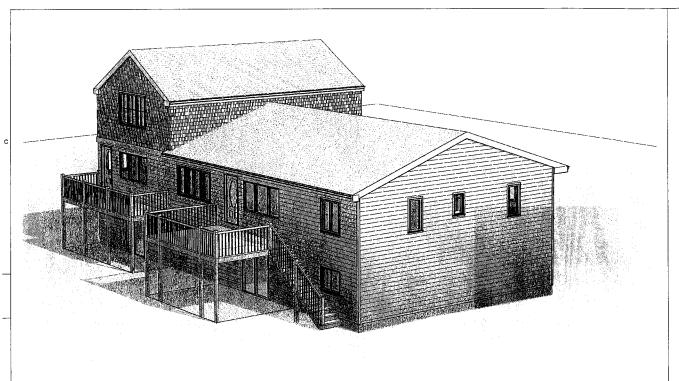

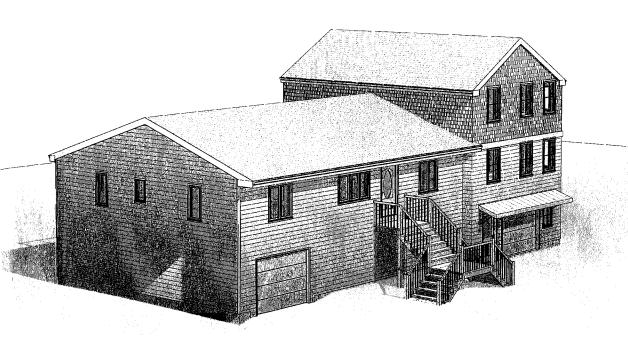



FAGAN DESIGN BUILD STUDIO

401.855.4873 fagan1@gmail.com

Pacific-Visions Studio LLC
Residential Design 5 Consulting

495 Hope Street STE 2B Bristol, RI

401.203.3191 info@pacific-visions.com

Pacific-Visions.com

©2022 Pacific-Visions Studio LLC

RENNOVATION AND ADDITION OF:
240 SHAWOMET AVE

SCHEMATIC DESIGN ISSUED FOR

NOT FOR CONSTRUCTION 20 FEBRUARY 2023

This drawing set is for review, pricing, and coordination and should not be used for construction or permitting. All structural members to be reviewed and sized by a structural engineer.

REVISIONS

EXTERIOR 3D VIEWS

DRAWN BY: VF CHECKED BY: CF SHEET SIZE: ARCH D 24" X 36"

A12.01

1 PROPOSED 3D View 1
A12.01 Scale:

PROPOSED 3D View 3
A12.01 Scale:

PROPOSED 3D View 4
A12.01 Scale:

PROPOSED 3D View 2
A12.01 Scale: