

SHEET TITLE
PARTIAL FLOOPS
PLAN, INTERIORS
BLEVIS & DETAIL

COCIATES

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ARCHITECTI PLANNERI CRANSTOI RHODE ISLANI

PROJECT


PROJECT
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TO


WARWICK SCHOOL SCIENCE LABS

GORTON UB: HIGH

Brann DATE SHEET NO.

PREVISIONS

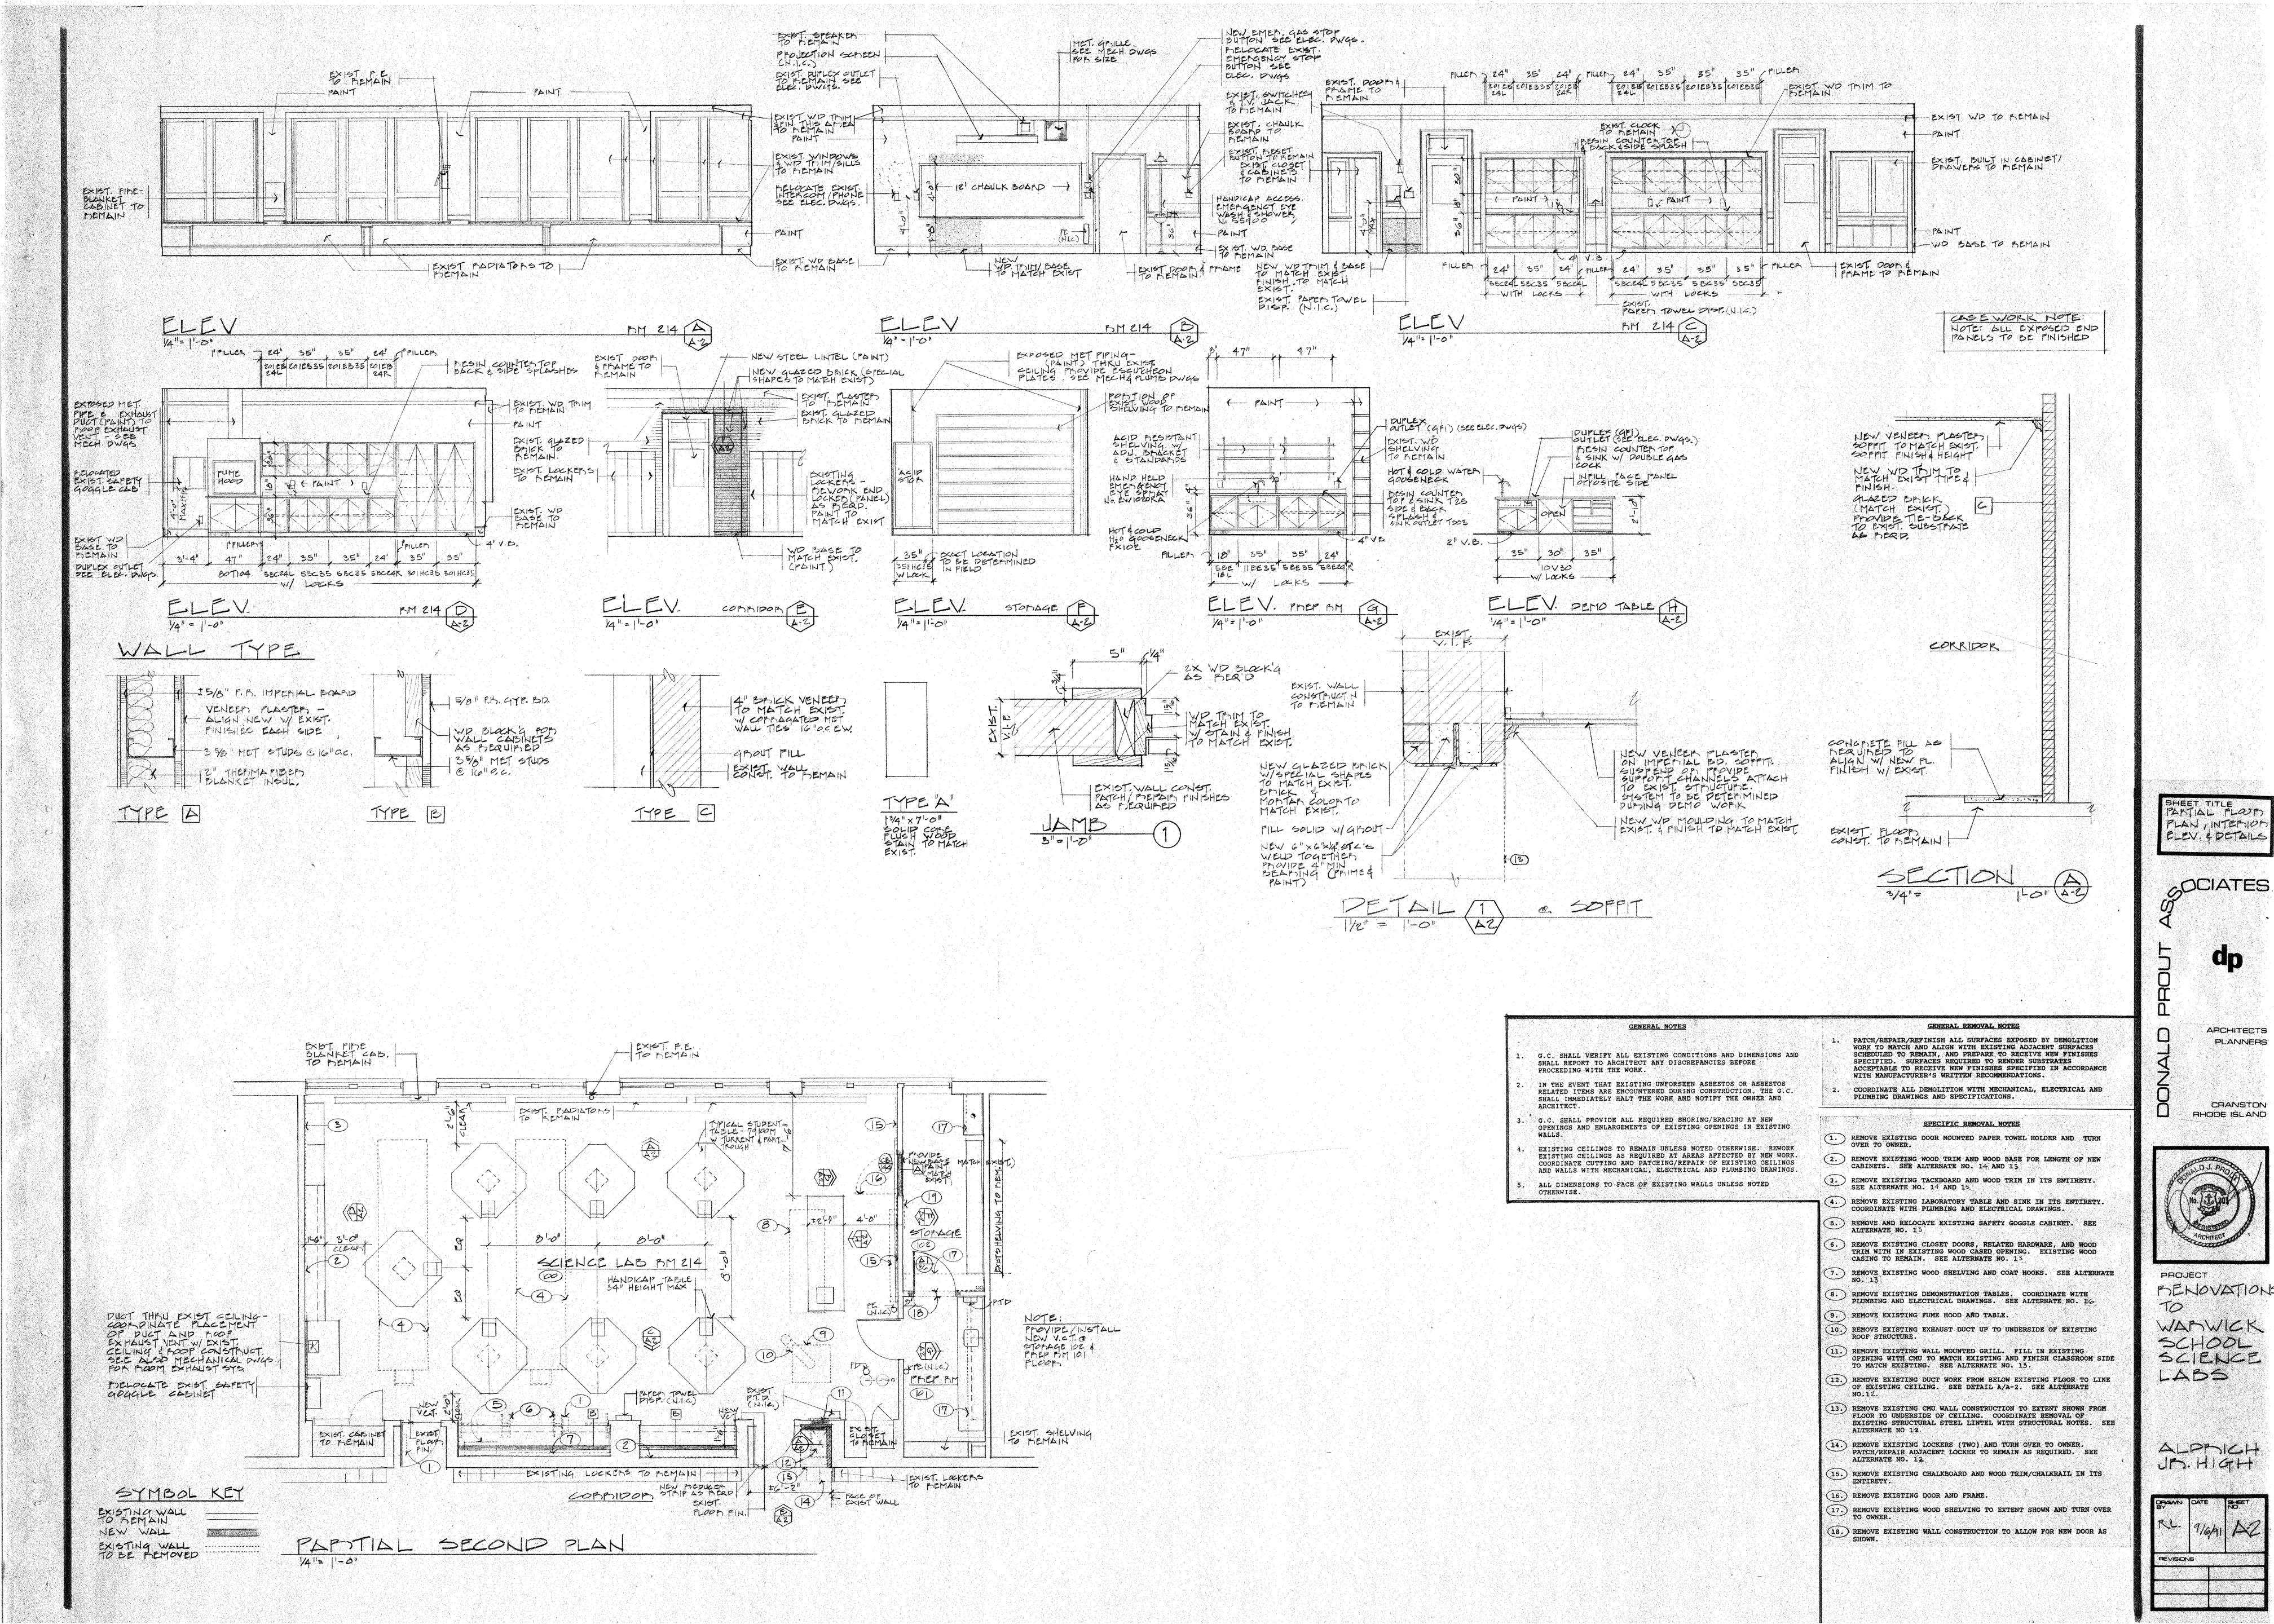

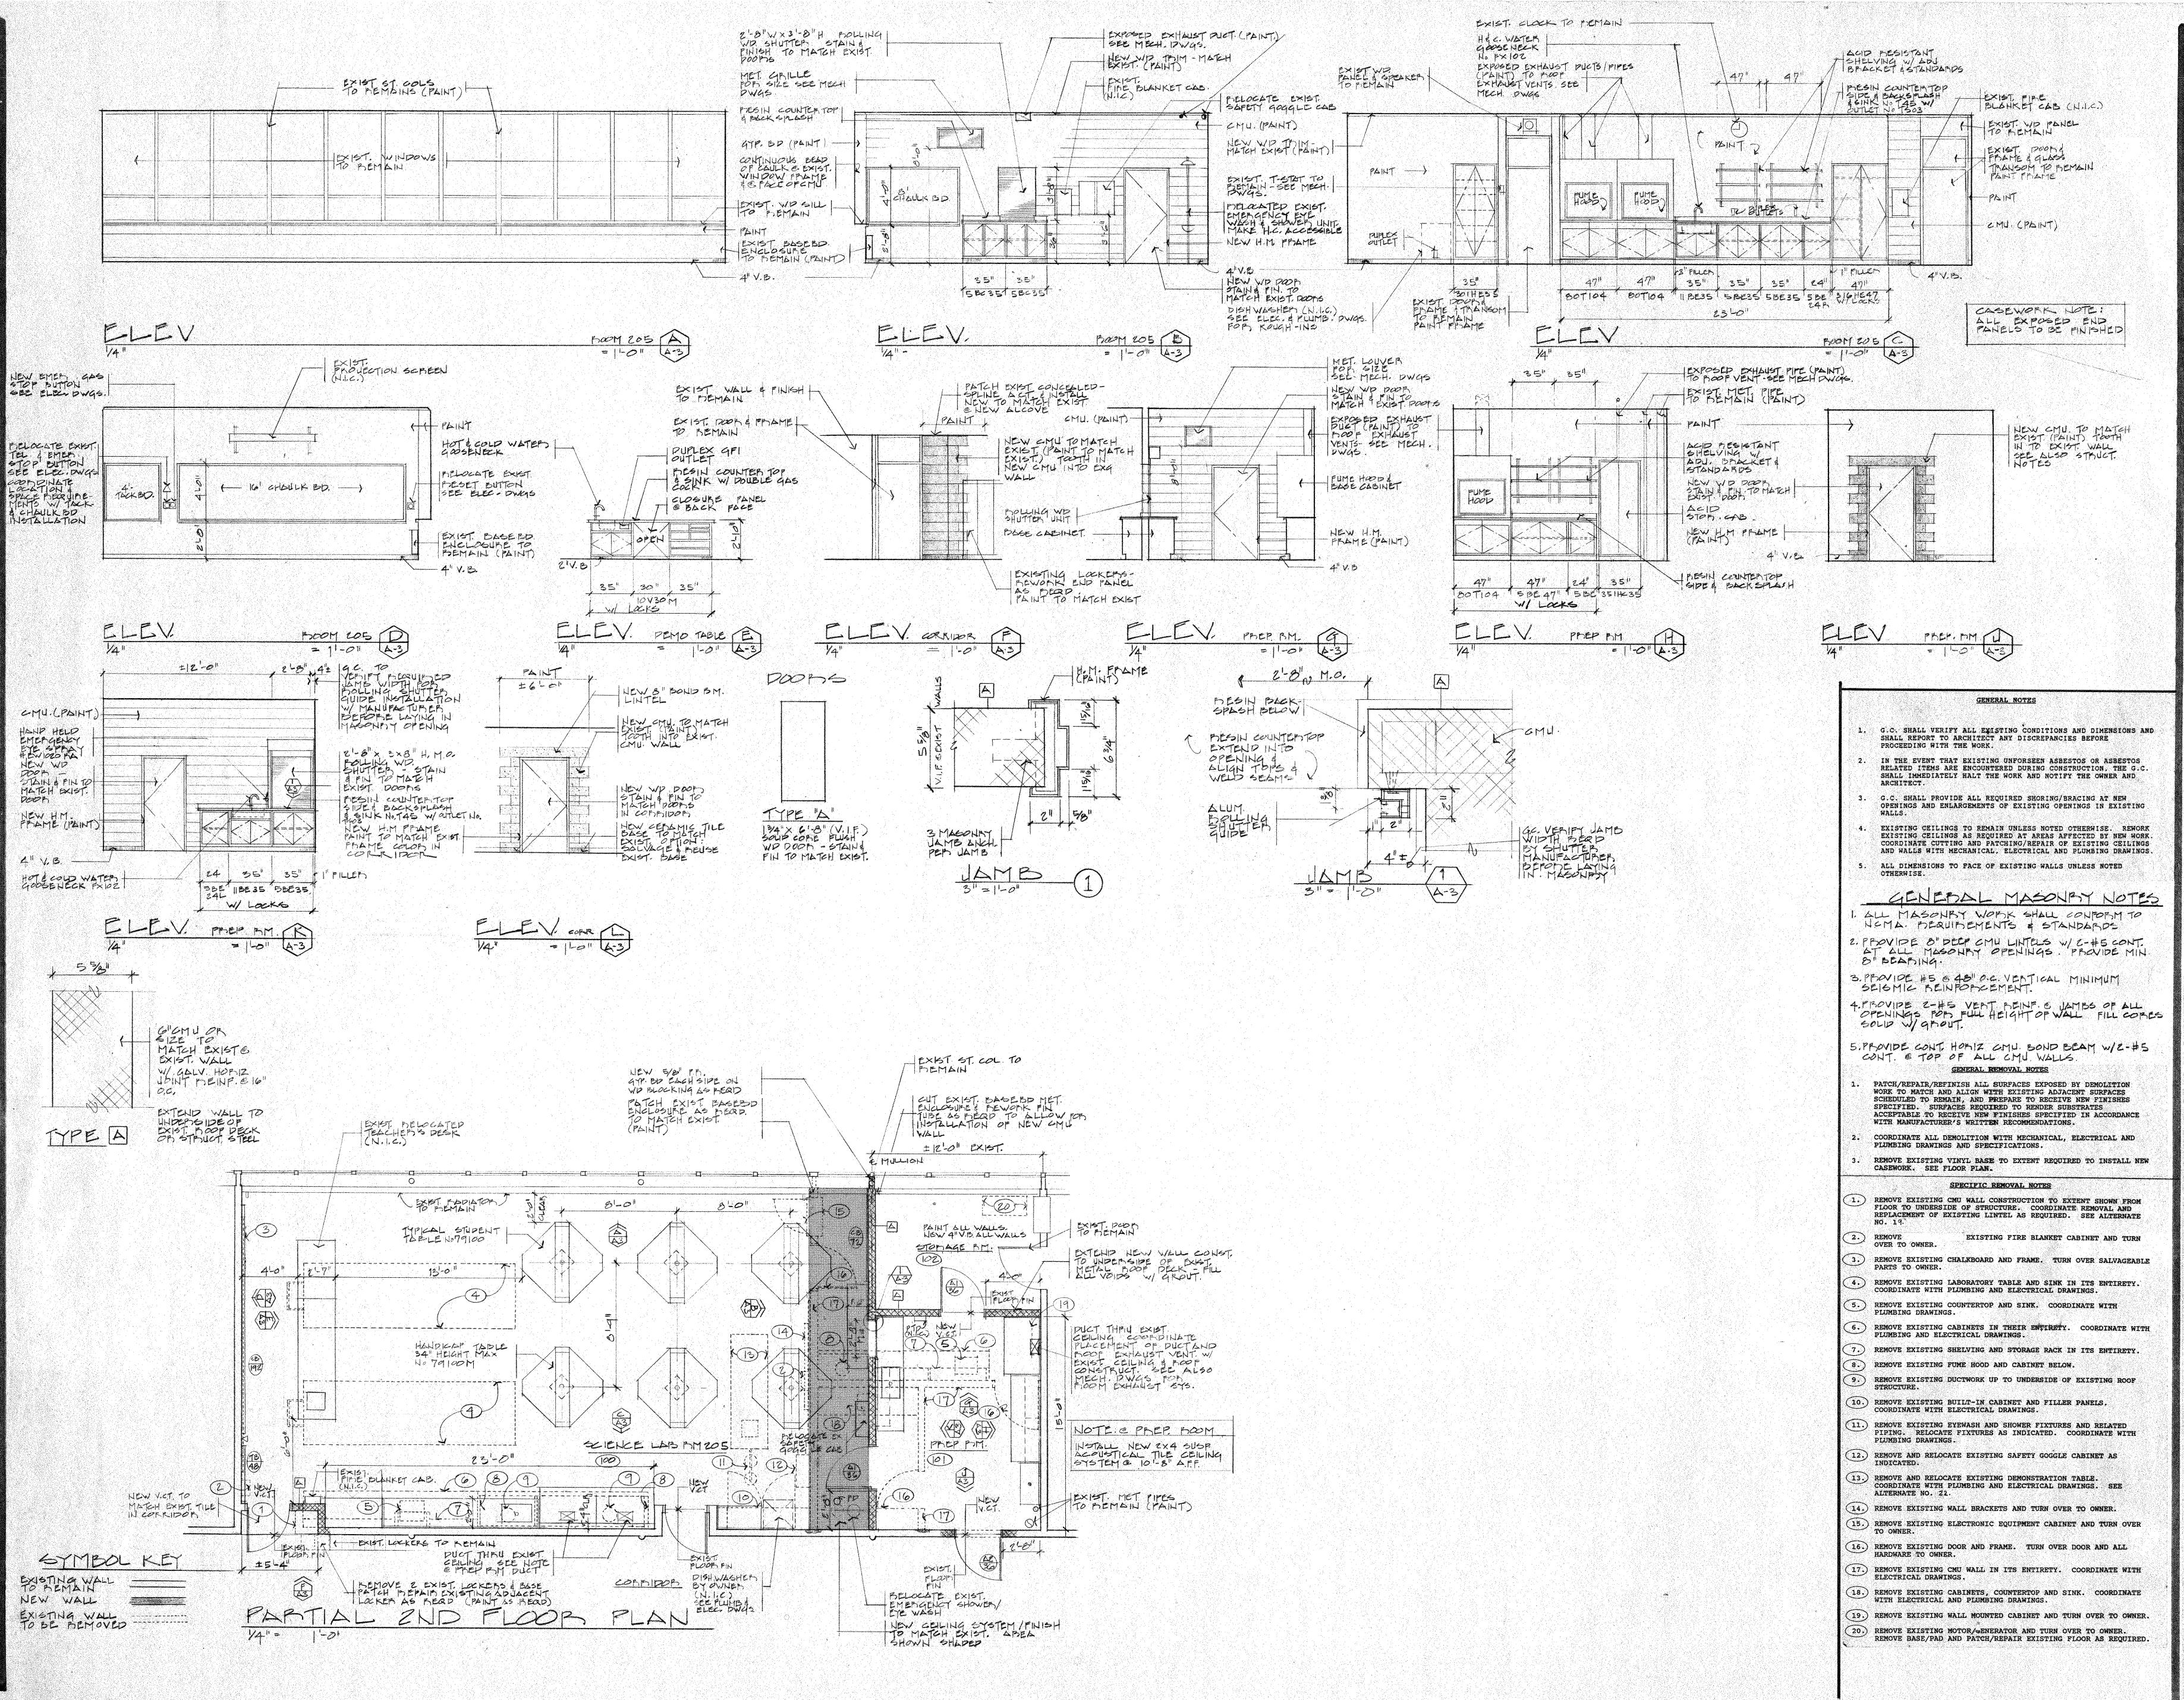

SHEET TITLE PLOOPS PLAN SLEVATIONS & IDSTAILS

SOCIATES

dp

ARCHITECTS
PLANNERS


CRANSTON
RHODE ISLAND



PROJECT
PSENOVATION:
TO
WARWICK
SCHOOL
SCIENCE
LABS

VETEBANG HIGH SCHOOL

DRAWN DATE SHEET NOTE PLANT OF THE PROPERTY OF

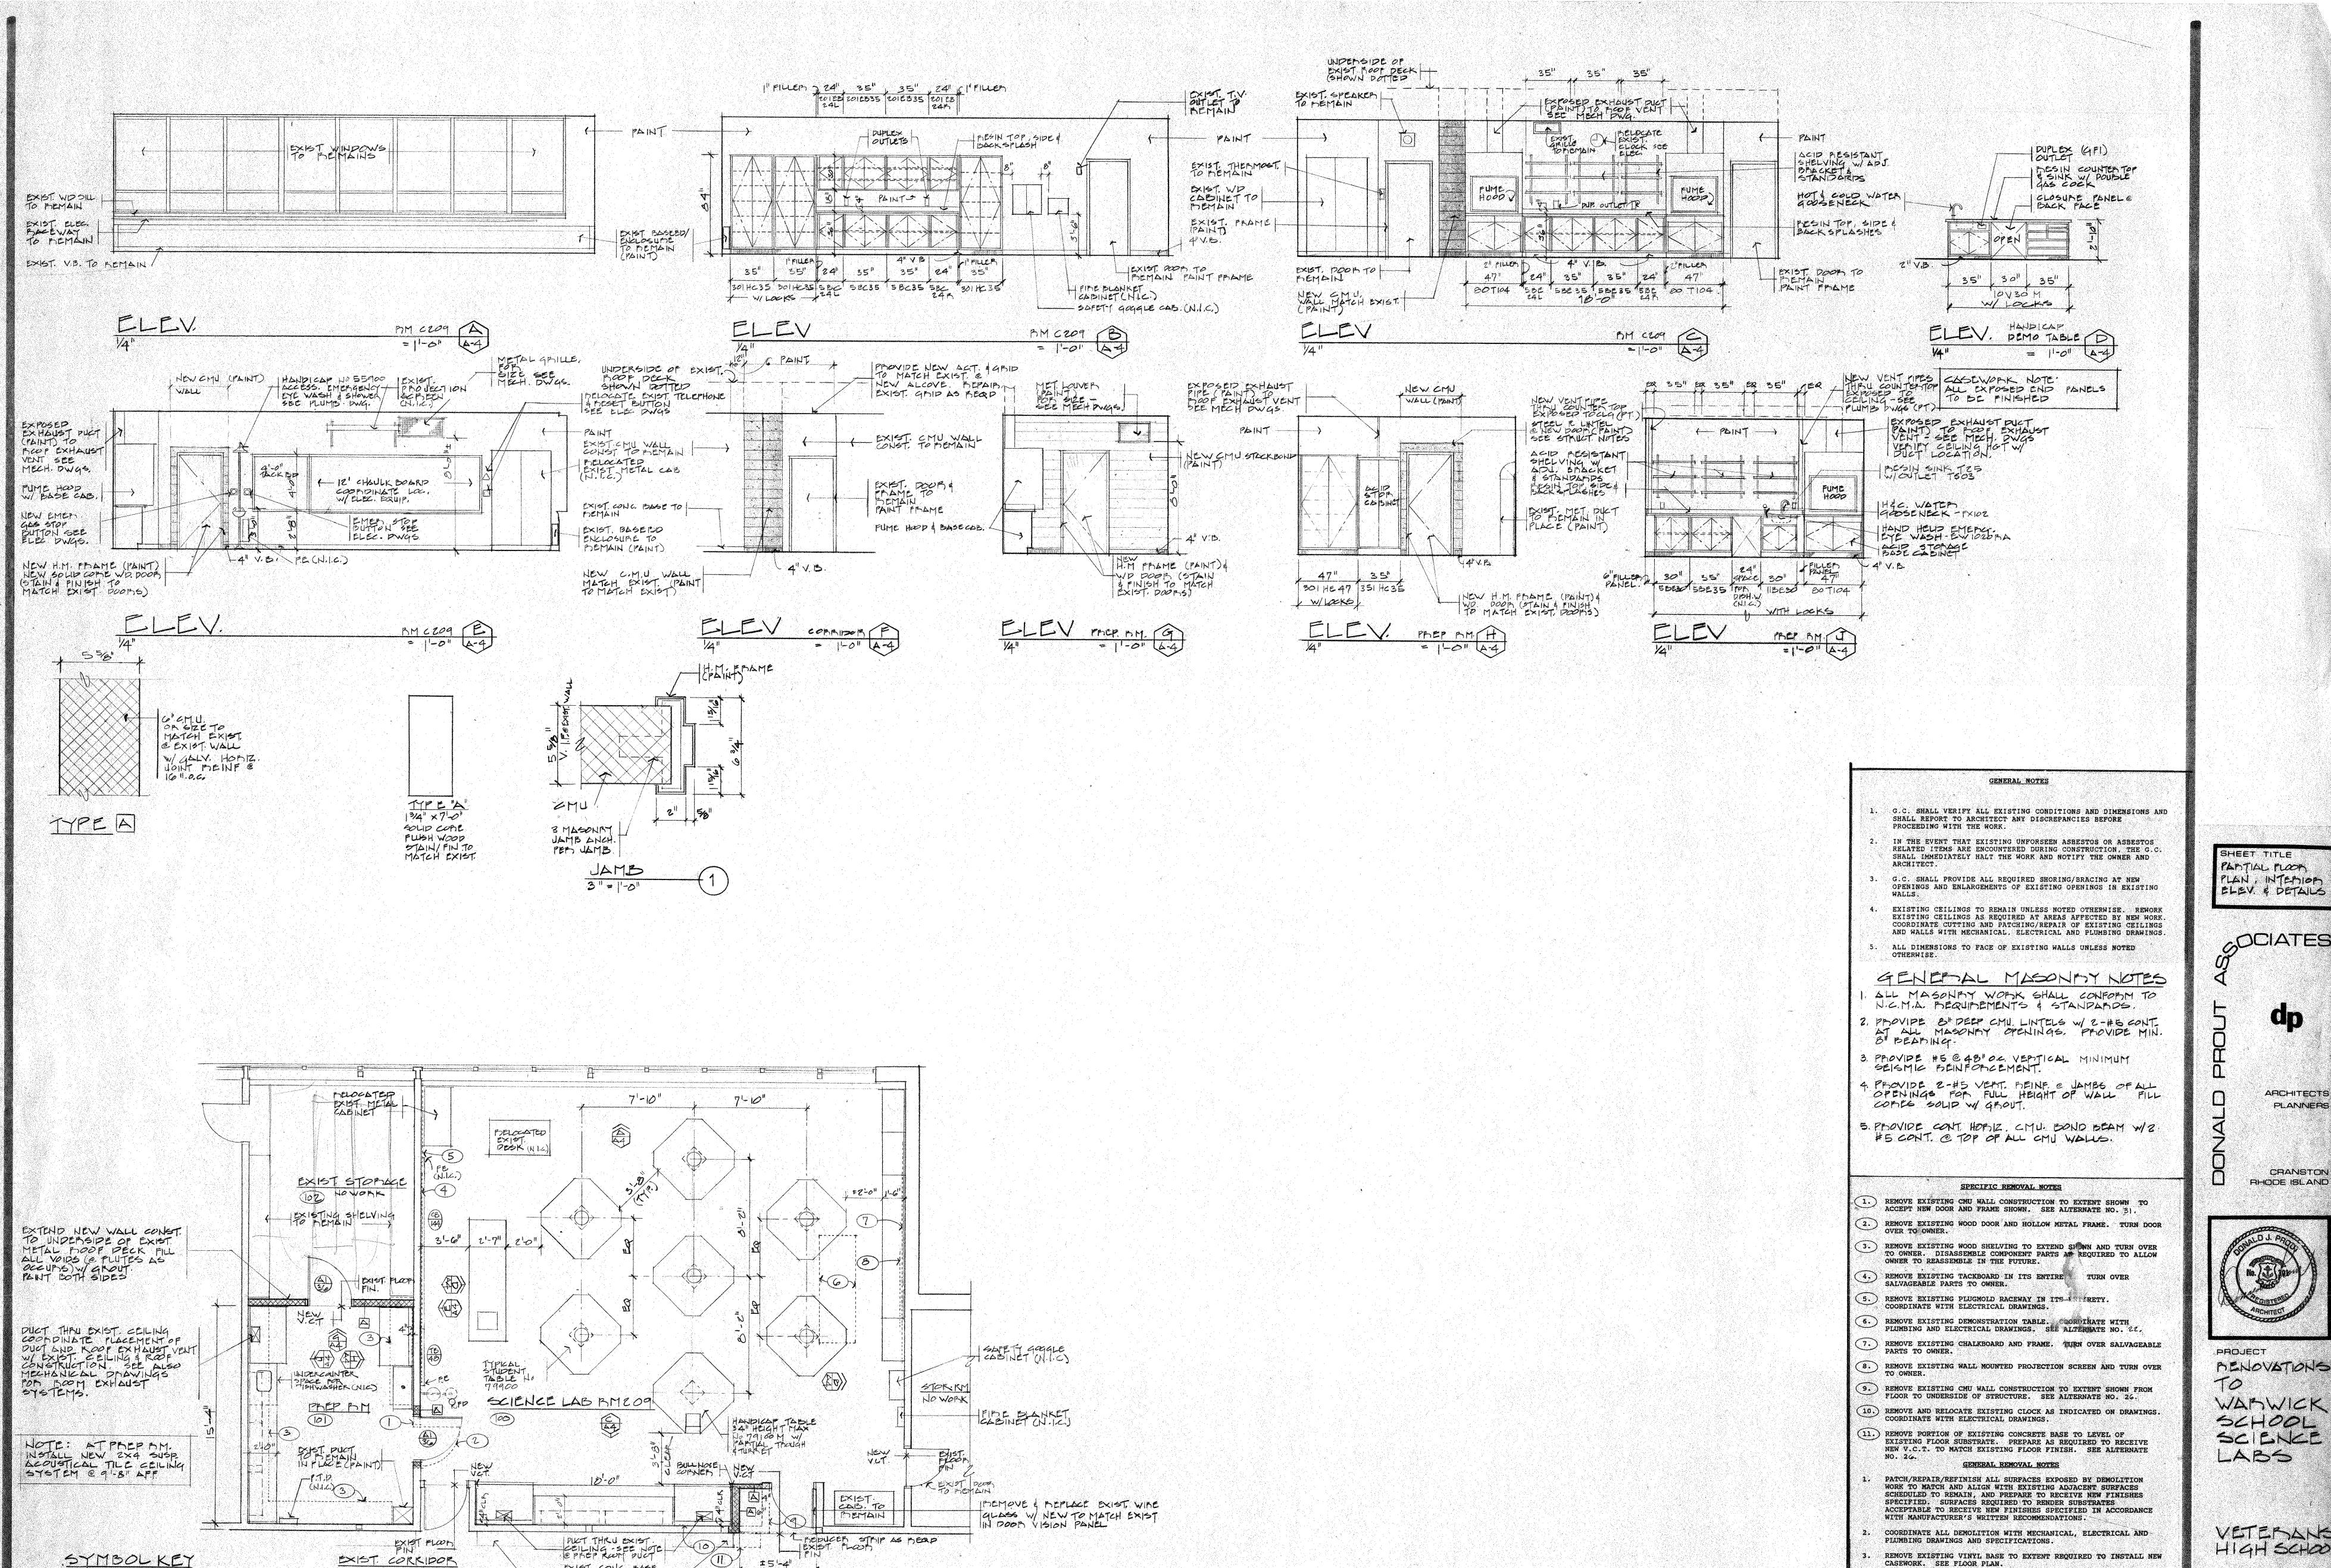

EXIST CONG. BASE

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TO MEMAIN

PARTIAL 2ND FLOOR PLAN

NEW WALL

EXISTING WALL TO BE PLEMOVED

SHEET TITLE PANTIAL FLOOR PLAN, INTERIOR elev & details


OCIATES


ARCHITECTS PLANNERS

> CRANSTON RHODE ISLAND

REMOVE EXISTING VINYL BASE TO EXTENT REQUIRED TO INSTALL NEW CASEWORK. SEE FLOOR PLAN.

LABS VETERANG HIGH SCHOOL

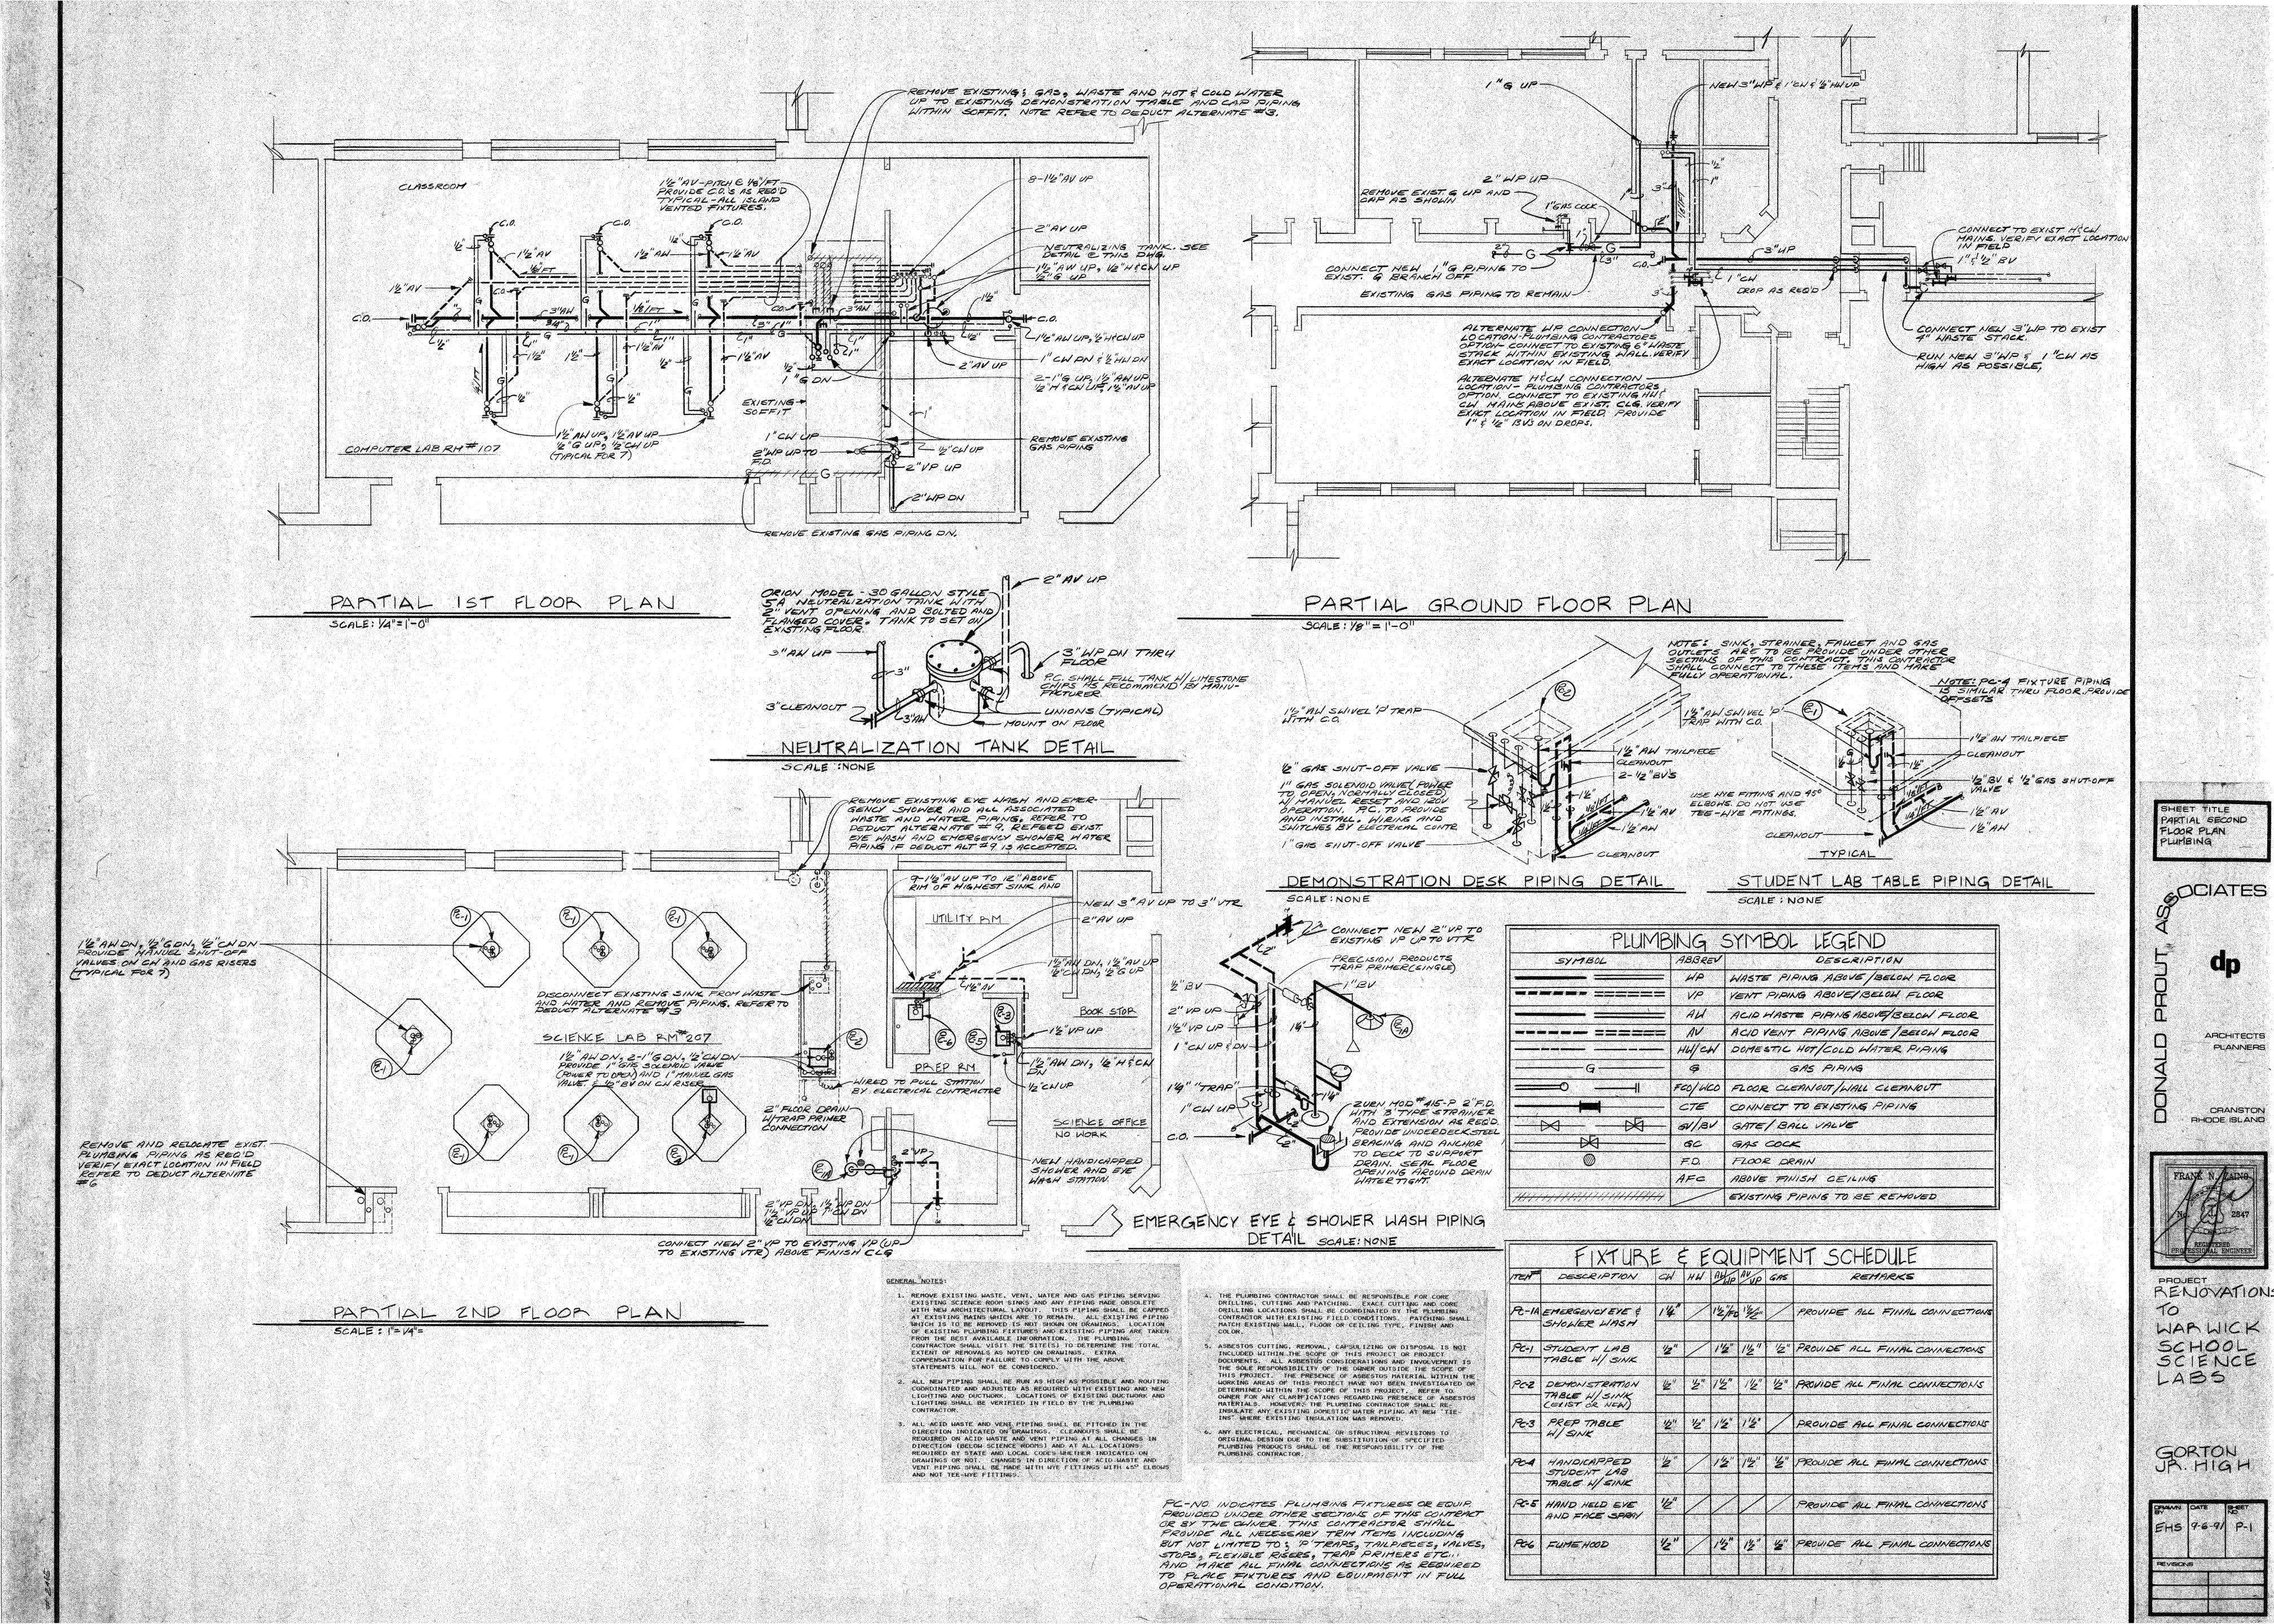

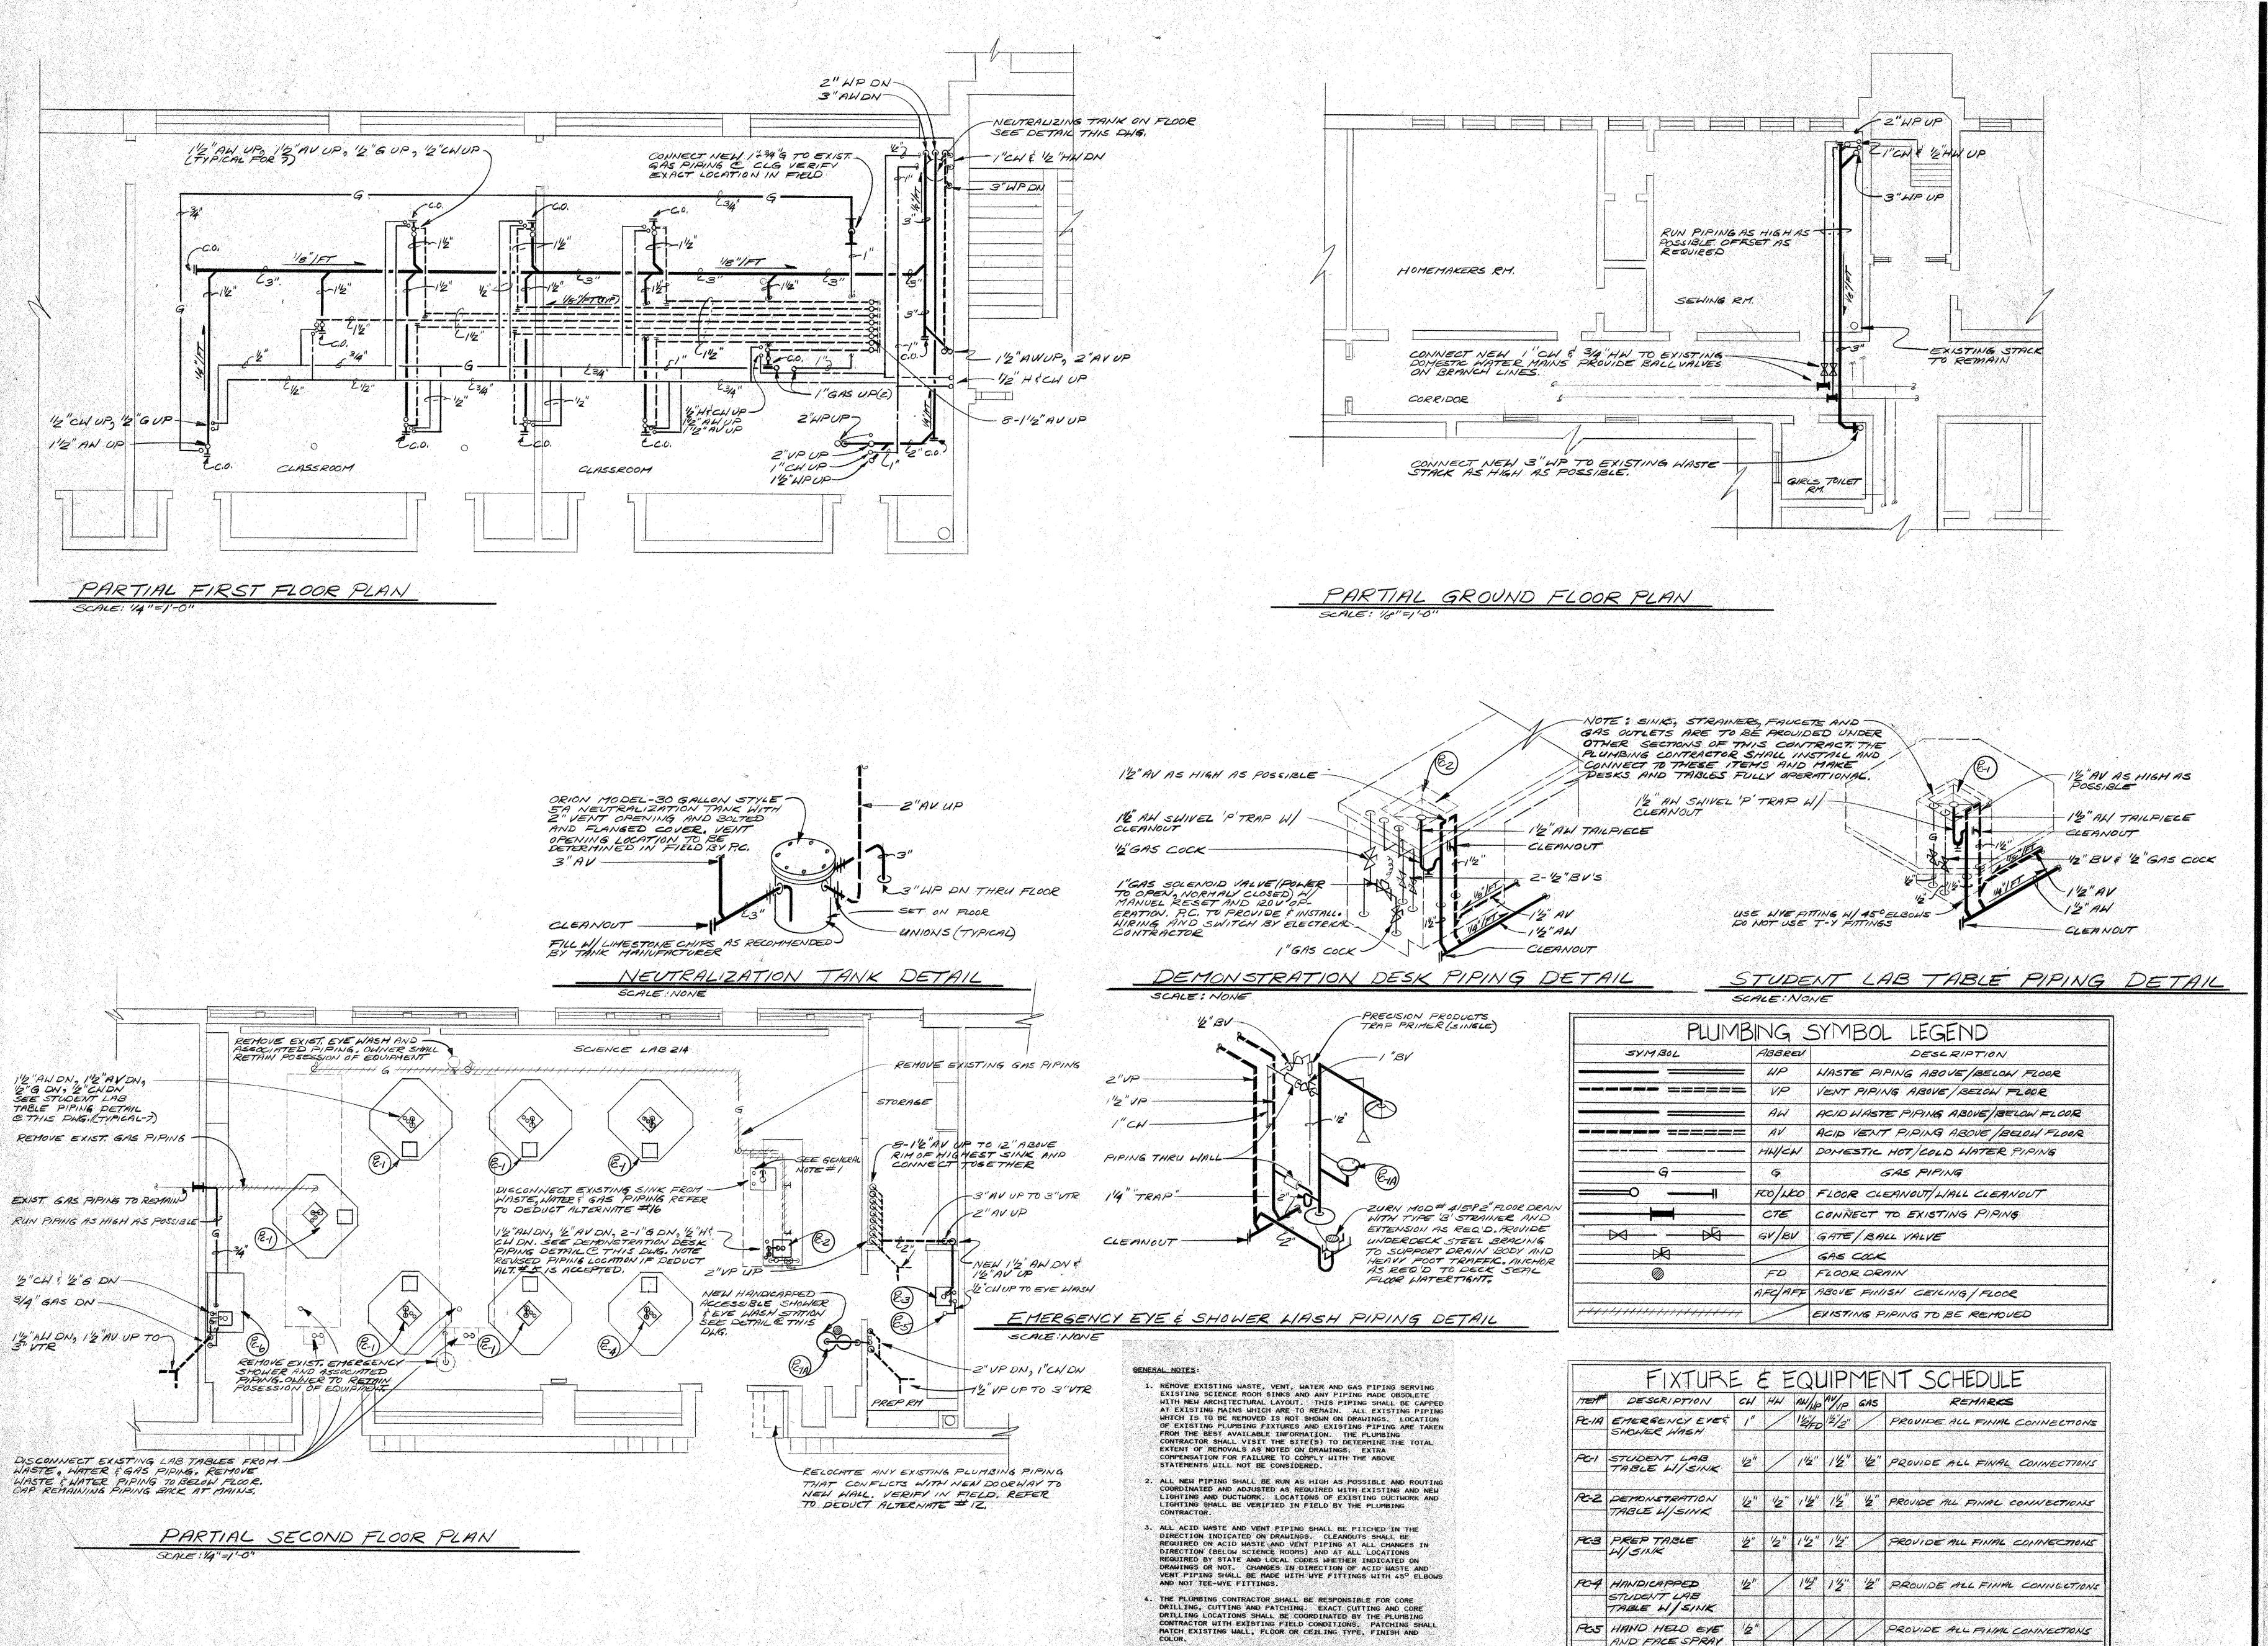

5. ASBESTOS CUTTING, REMOVAL, CAPSULIZING OR DISPOSAL IS <u>NOT</u>
INCLUDED WITHIN THE SCOPE OF THIS PROJECT OR PROJECT
DOCUMENTS. ALL ASBESTOS CONSIDERATIONS AND INVOLVEMENT IS

MATERIALS: HOWEVER, THE PLUMBING CONTRACTOR SHALL RE-

6. ANY ELECTRICAL, MECHANICAL OR STRUCTURAL REVISIONS TO

ORIGINAL DESIGN DUE TO THE SUBSTITUTION OF SPECIFIED PLUMBING PRODUCTS SHALL BE THE RESPONSIBILITY OF THE

INS' WHERE EXISTING INSULATION WAS REMOVED.

PLUMBING CONTRACTOR.

INSULATE ANY EXISTING DOMESTIC WATER PIPING AT NEW "TIE-

THE SOLE RESPONSIBILITY OF THE OWNER OUTSIDE THE SCOPE OF THIS PROJECT. THE PRESENCE OF ASBESTOS MATERIAL WITHIN THE WORKING AREAS OF THIS PROJECT HAVE NOT BEEN INVESTIGATED OR DETERMINED WITHIN THE SCOPE OF THIS PROJECT. REFER TO OWNER FOR ANY CLARIFICATIONS REGARDING PRESENCE OF ASBESTOS

SHEET TITLE
PARTIAL SECOND
FLOOR PLAN
PLUMBING

COCIATES

dp '
ARCHITEGTS
PLANNERS

ARCHITECTS
PLANNERS
CRANSTON
RHODE ISLAND

FRANK W. ZAMO

V. ZAMO

2847

REGISTERED

PROVESSIONAL ENGINEER

PROJECT
RENOVATION
TO
WAR WICK
SCHOOL

SCIENCE

OK! PRICH

PHS 9-6-9 P-2

REVISIONS

"E" / 1"2" 1"2" PROVIDE ALL FINAL CONNECTIONS

PC-NO INDICATES PLUMBING FIXTURES OR EQUIPMENT PROVIDED UNDER OTHER


SECTIONS OF THIS CONTRACT OR BY OHNER, THIS CONTRACTOR SHALL PROVIDE

ALL NECESSARY TRIM ITEMS INCLUDING BUT NOT LIMITED TO: 'P'TRAPS, TAIL

PIECES, VALUES, STOPS, FLEXIBLE RISERS, TRAP PRIMERS ETC. AND MAKE ALL FINAL CONNECTIONS AS REQUIRED TO PLACE FIXTURES AND EQUIPMENT

REG FUME HOOD

IN FULL OPERATIONAL CONDITION.

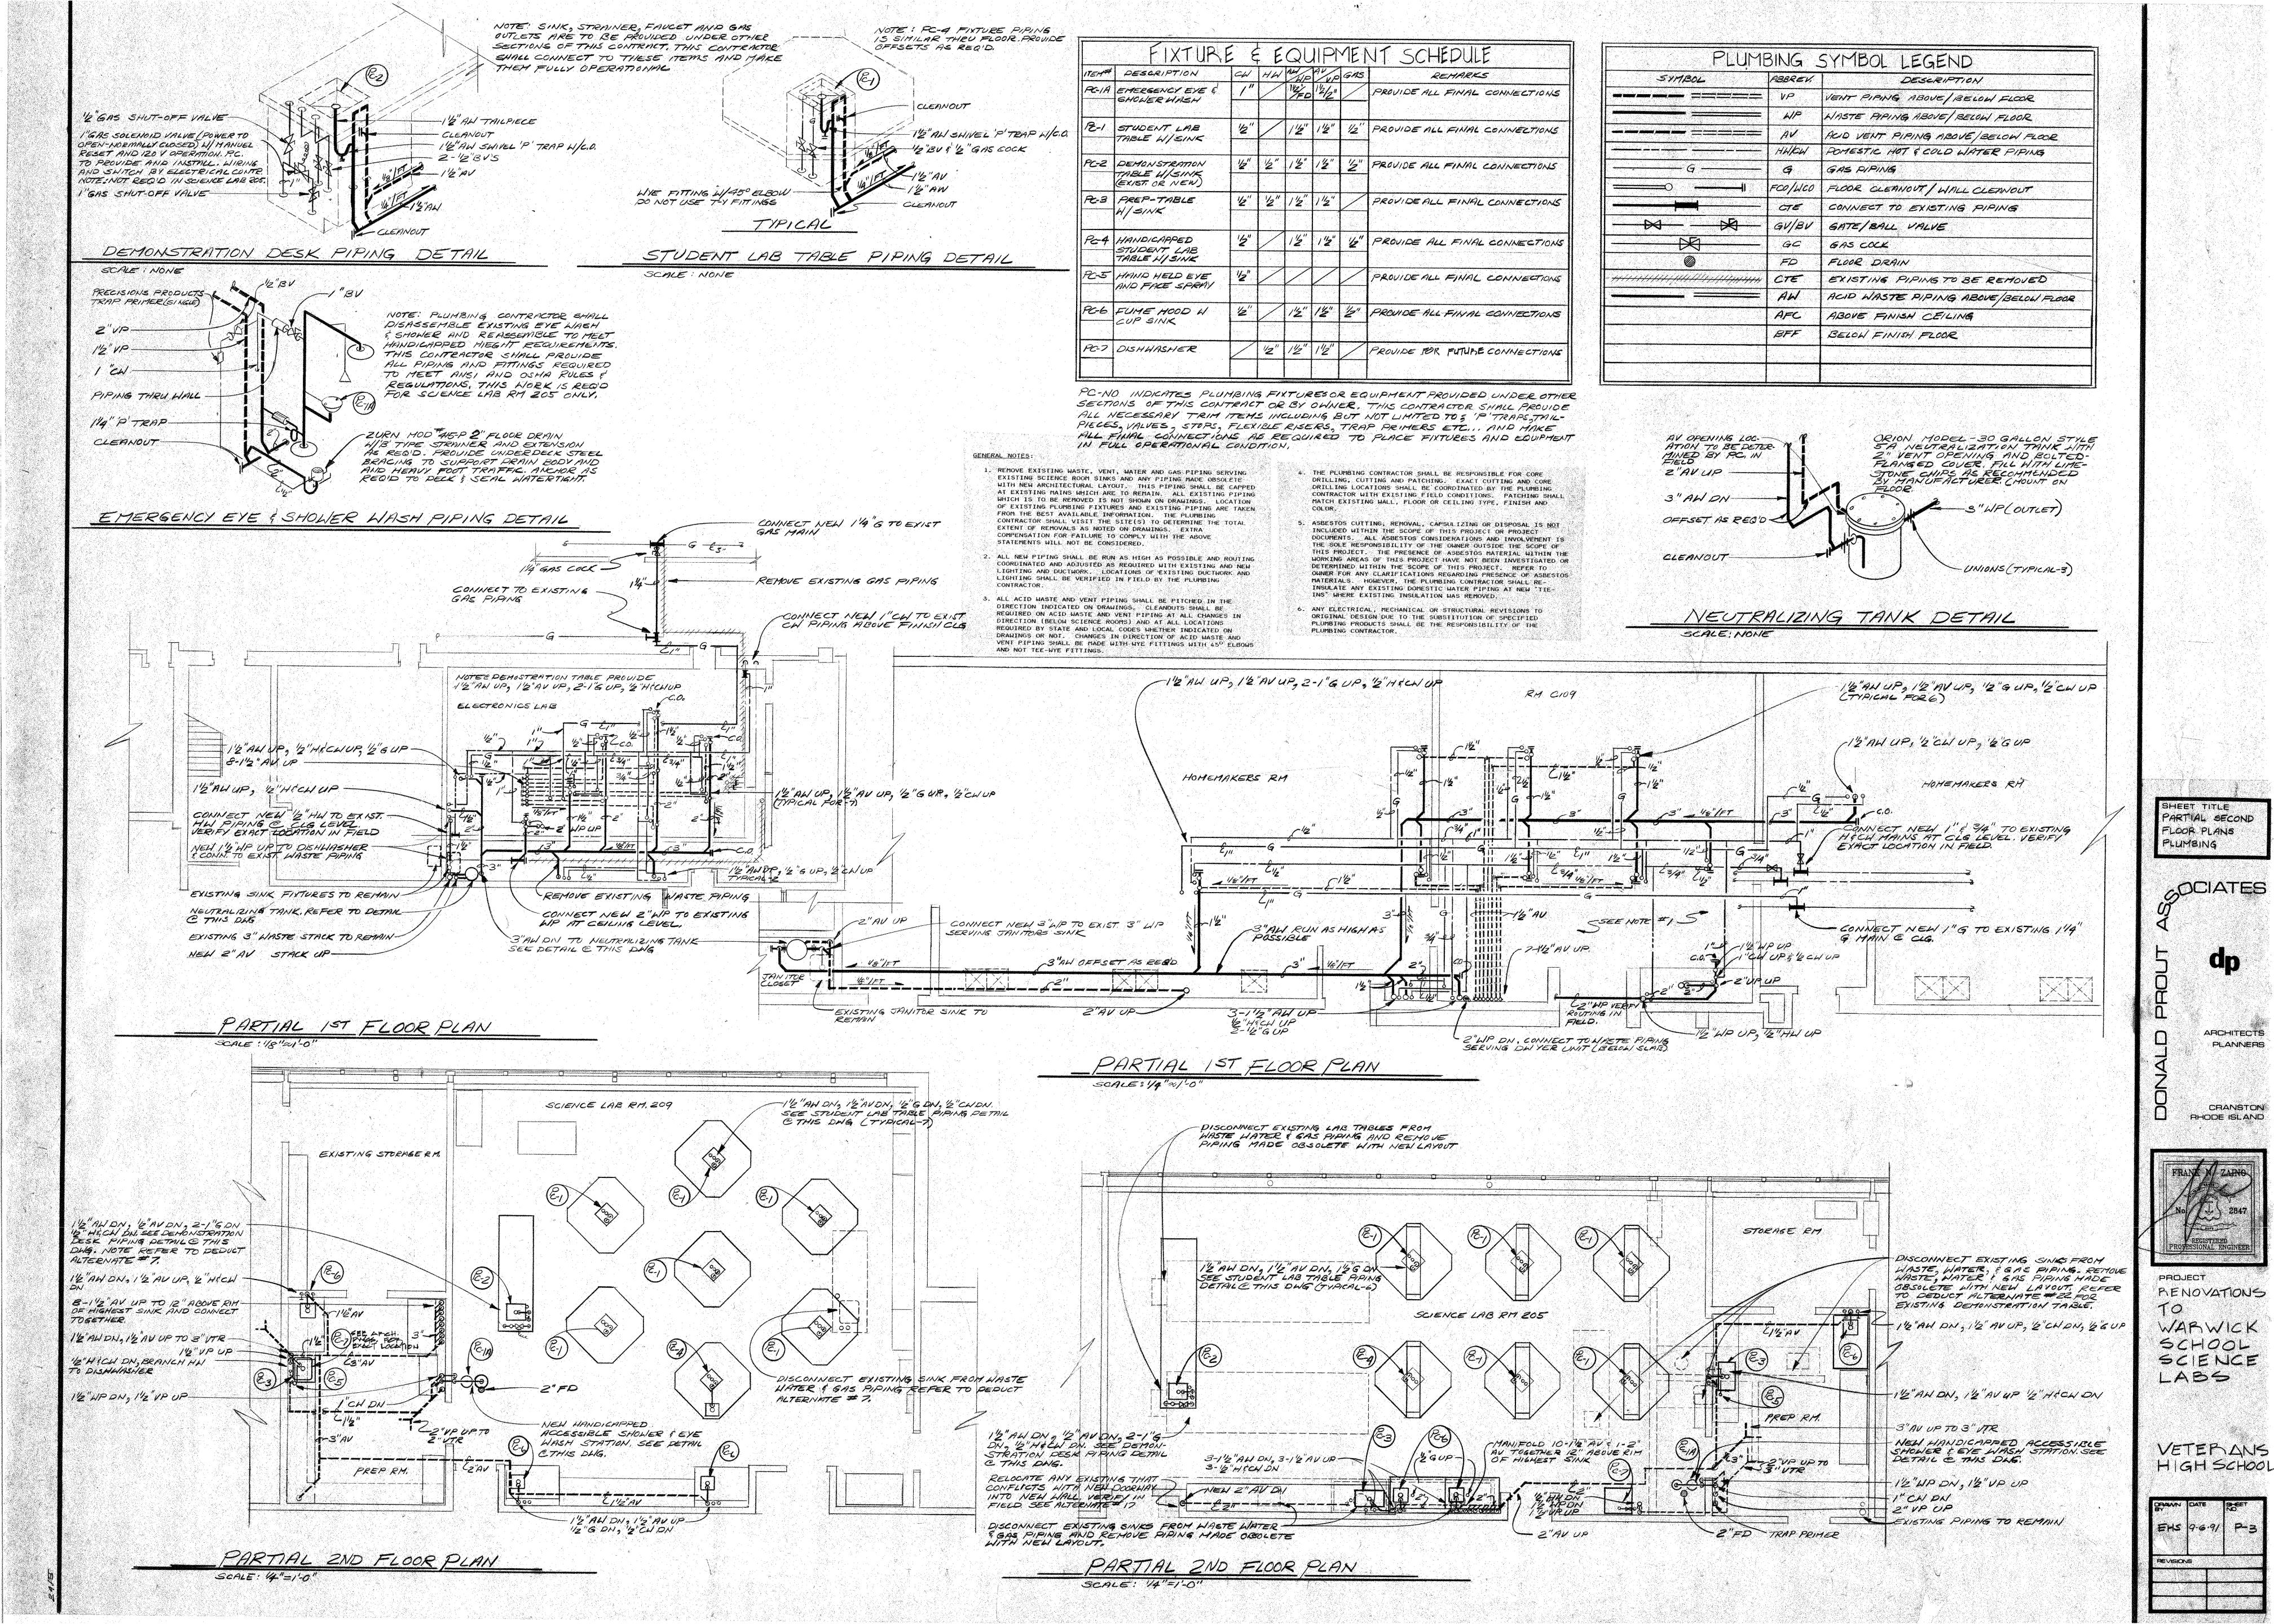

SHEET TITLE PARTIAL DECOND ROOK PLAN

CIATES

ARCHITECTS

PLANÑERS

CRANSTON

RHODE ISLAND

PROJECT

RENOVATIONS

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GORTON

JR. HIGH

REVISIONS

LABS

MECHANICAL

- WEATHER PROOF MOTOR COVER

- DISCONNECT SWITCH

-SECURE TO CURB

-DUCT STIFFENER

EXHAUST FAN DETAIL

YEXISTING ROOF


NO OCALE

FLAGHING AND COUNTERFLASHING

BY THIS CONTRACTOR.

MAKE COMPLETELY WEATHER PROOF (TYP)

BX10(ALUM) EXH.

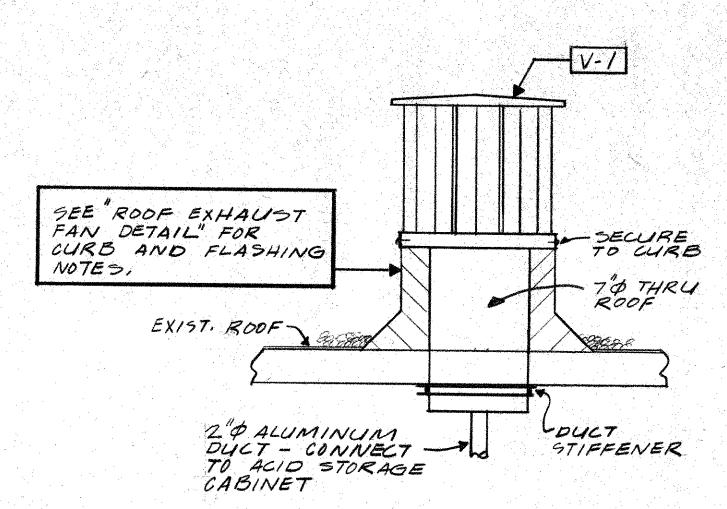



VENTILATOR DETAIL

NO SCALE
VENTILATOR SHALL BE 85 CFM @
5 MPH WIND VELOCITY @ 20°F.
22 GA ALUMINUM , 247 FT, THROAT AREA
UNO VENTAUSTER MODEL VB

	E	XHA	US	TF	9N Sc	HEDULE	
MARK	CFM	ESP	HP	RPM	VOLTS	POOF	DESCRIPTION
REF-1	920	.50"	1/3	1465	120/16	/3 × /3	COOK UCY - 12
REF-2	290	.25"	10	955	120/10	8 × 8	COOK ACE-BIODCZE
AND THE PROPERTY OF THE PARTY O	**************************************				***************************************		

REF-1 SHALL BE COMPLETE W/ WEATHER COVER, EISEN-HEISS COATING AND VIBRATION ISOLATION MOUNTING PADS.

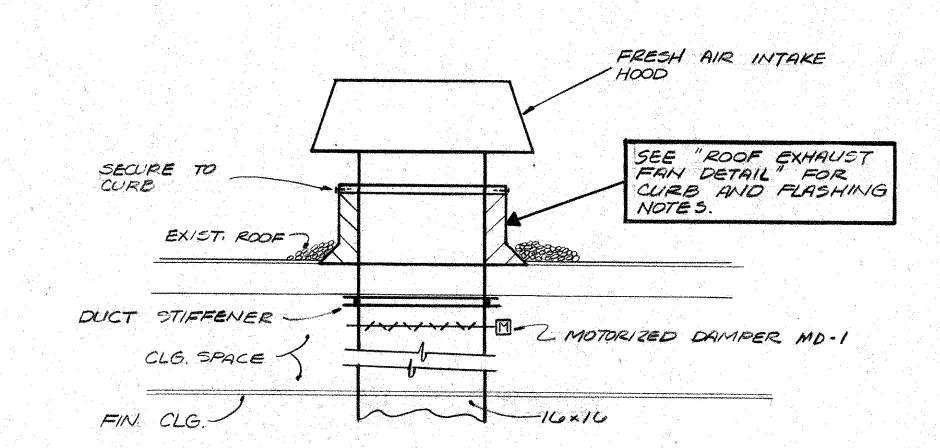


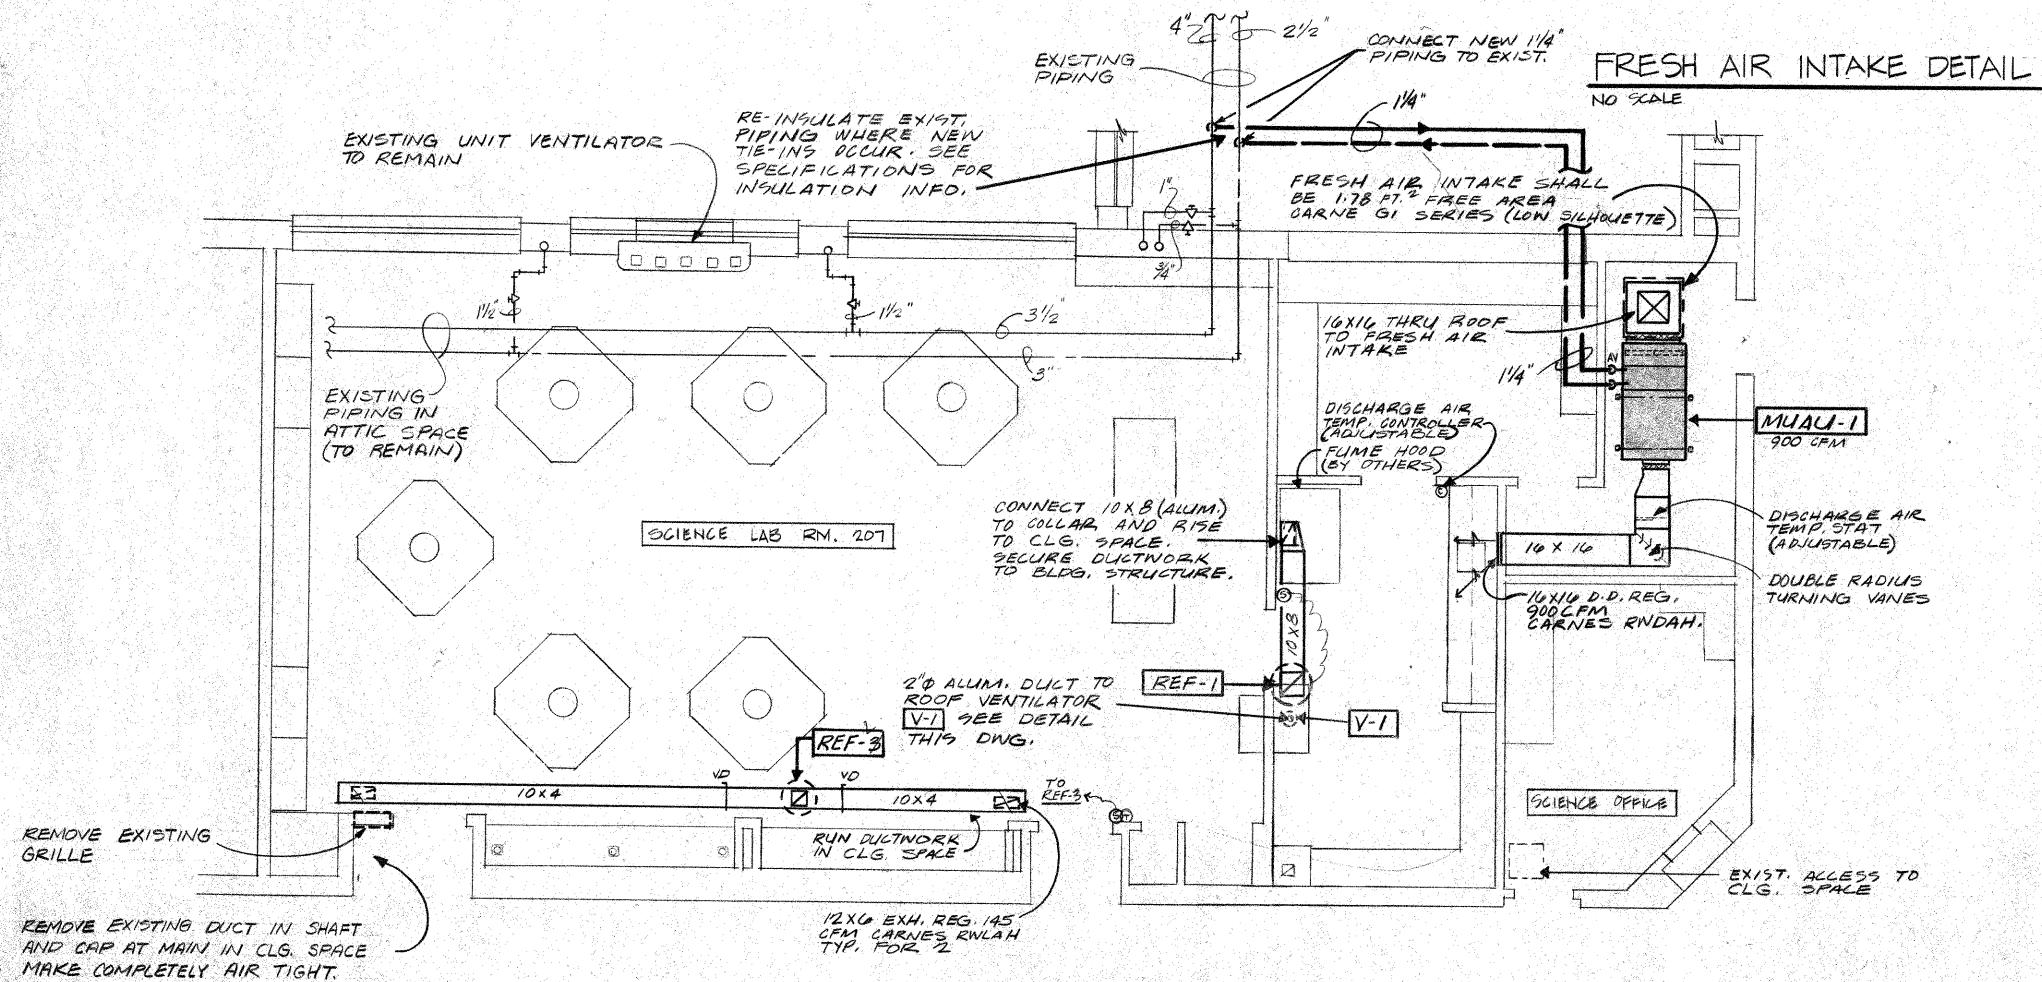


PARTIAL SECOND FLOOR PLAN - MECHANICAL SCALE 1/4"=1"-0"

							MAKE	: - 6	ip	AIR	UNI	7 SCH	EDUL	
M	AR⊭	SUPPLY CFM	O.A. CFM	ESP	HP	VOLTAGE	HEATING BTUH	; ΕΑΤ	LAT	WP4	APJ	STARTER	WEIGHT	DESCRIPTION
ML	AU-I		900			120/1 9		ar pagabigati s						TRANE CC3A - PROVIDE FREEZE STAT

PROVIDE 2-SETS OF THROWAWAY FILTERS

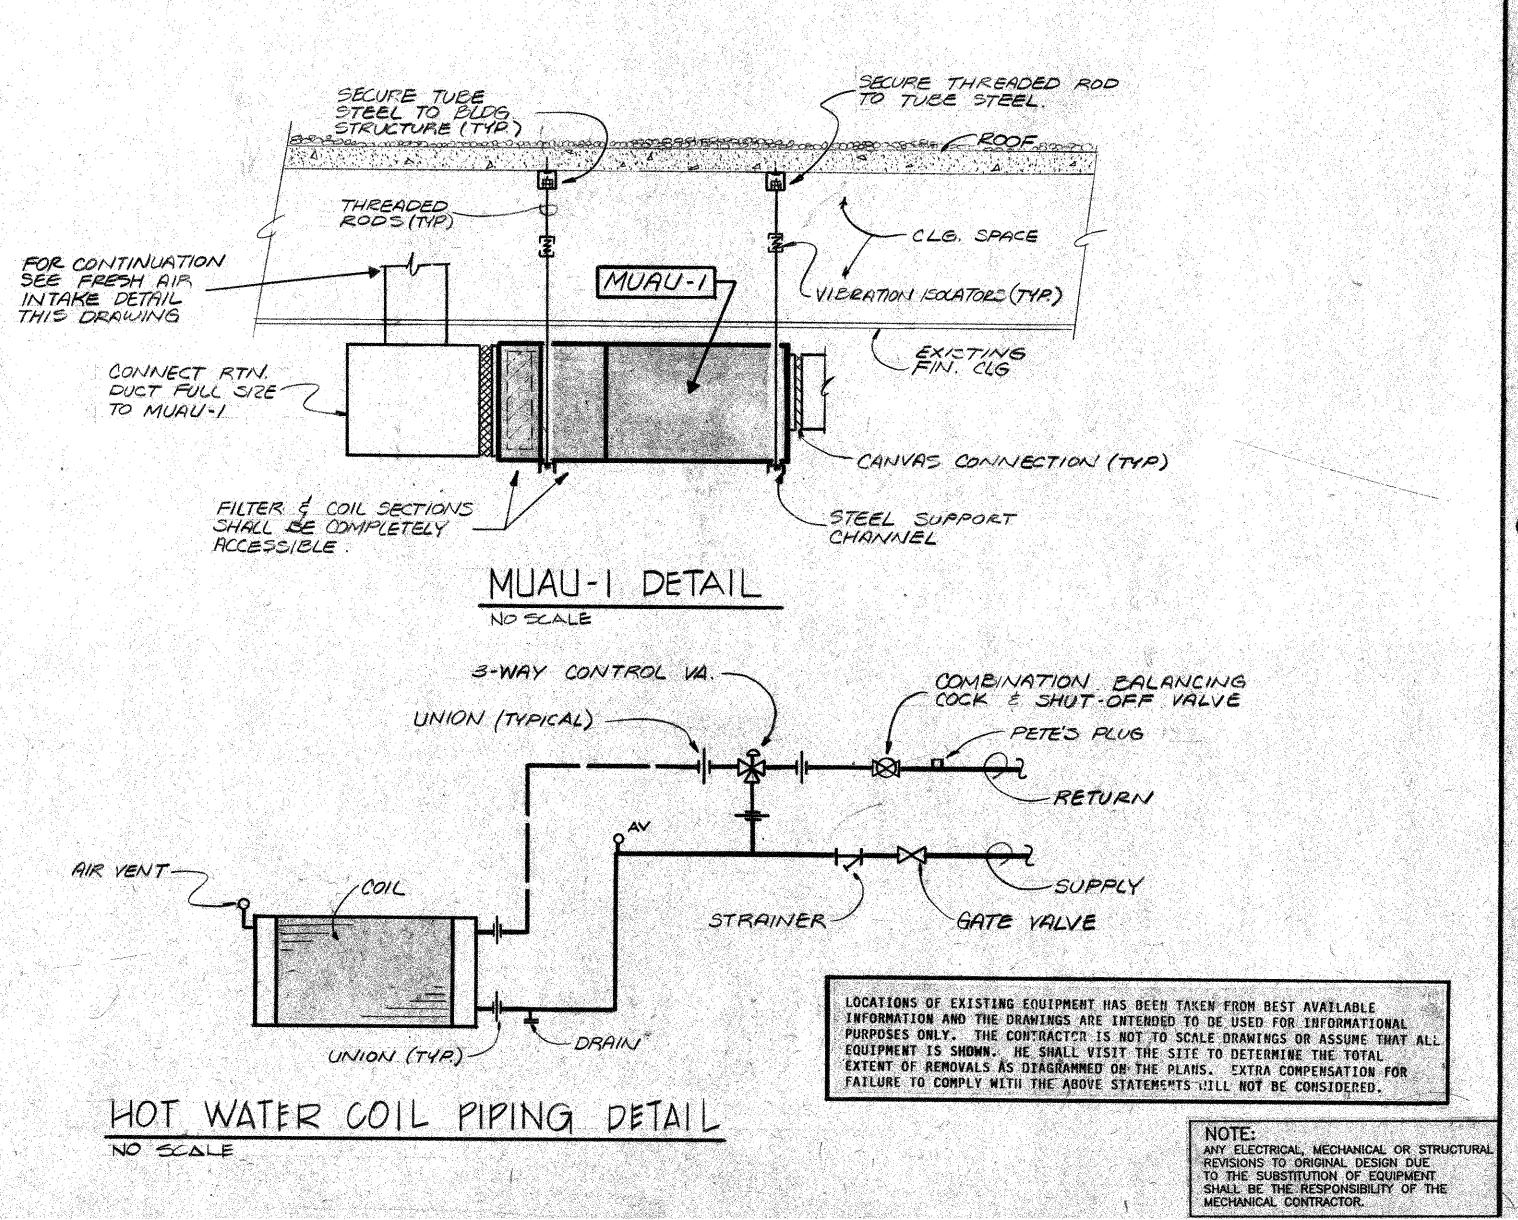


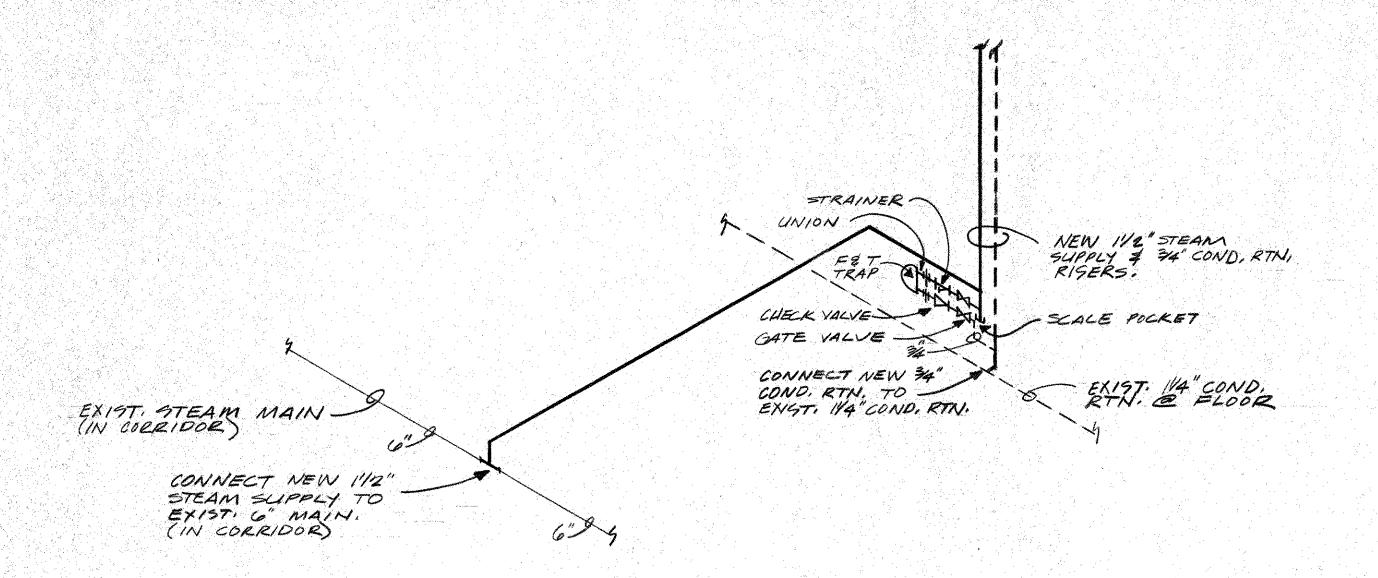



					MAK	E UP	AIR	UI	V/7	SCHE	DULE		
MARK	SUPPLY CFM	O.A. OFM	ESP	HP	VOLTAGE	576 169. /HR,	EAT	HEAT LAT	FING/FT.	516. APd.	STARTER	WEIGHT	DESCRIPTION
MUAU-1	900	900	,38"	1/3	120/10	129	ÓF.	107 F.	108	.08		850 Pds.	TRANE CC3A SIGMA-FLO PROVIDE FREEZE STAT


PROVIDE 2 SETS OF THROWAWAY FILTERS.

NEW STEAM RISER DETAIL NO SCALE

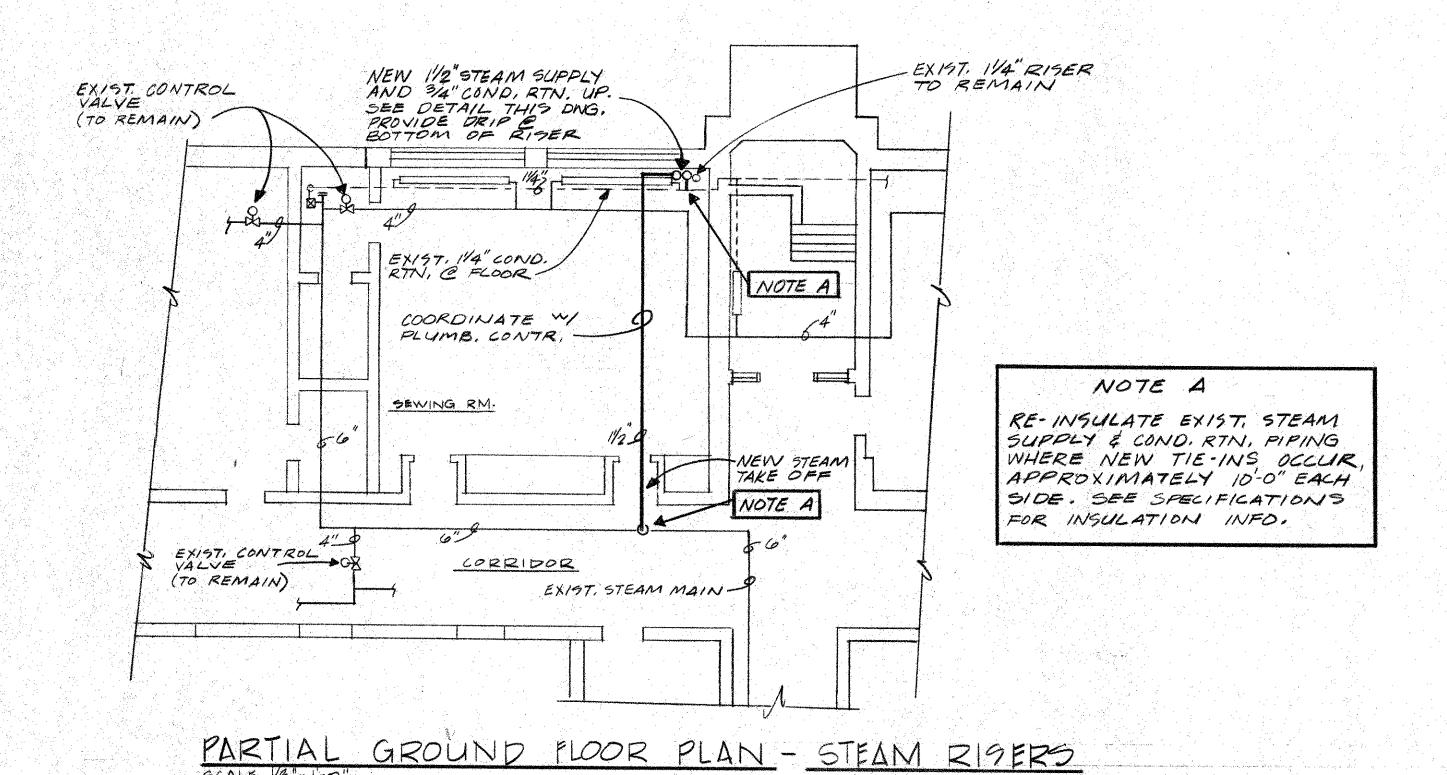

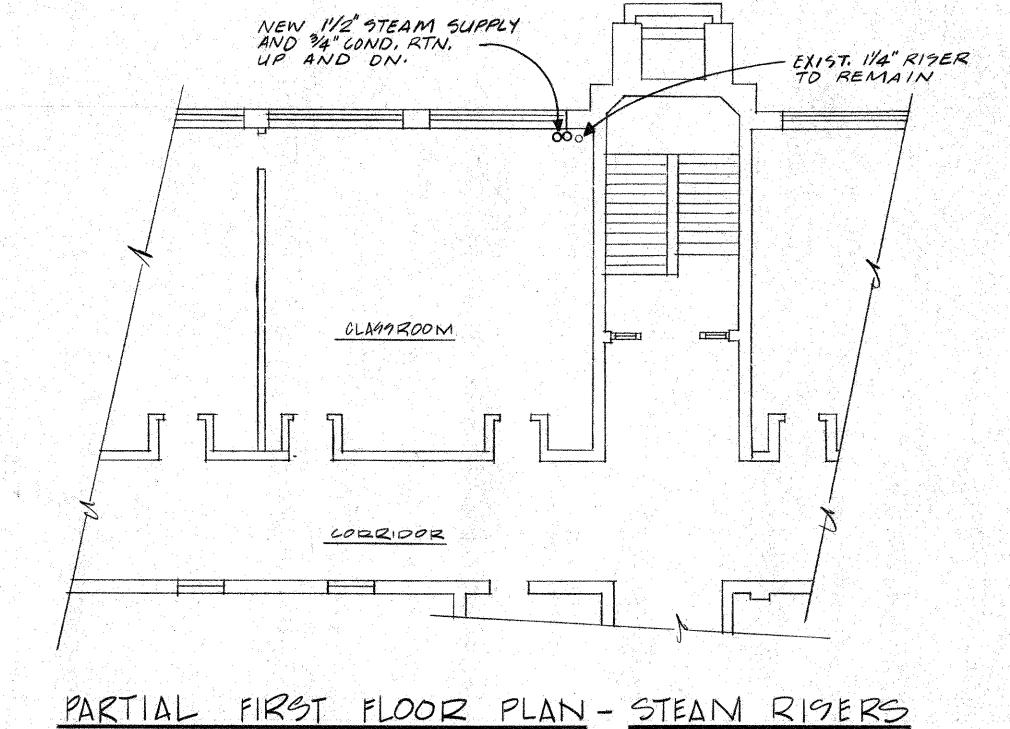

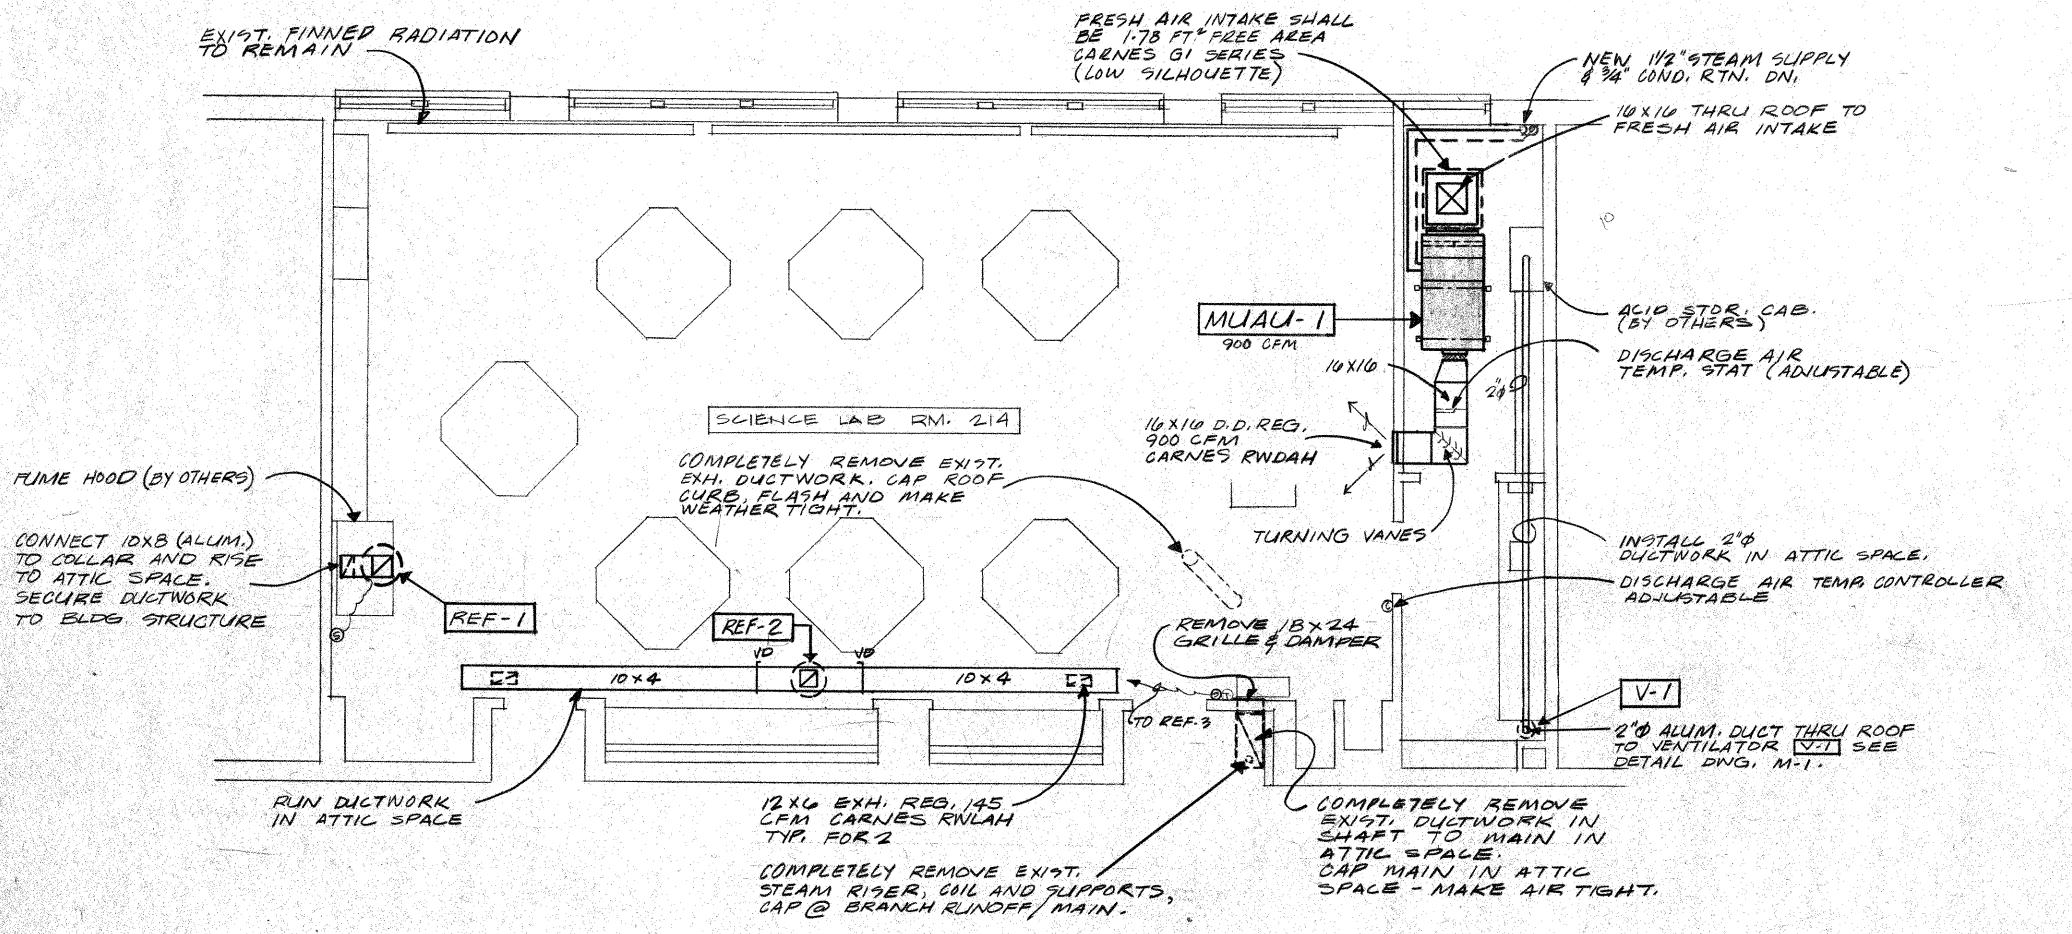

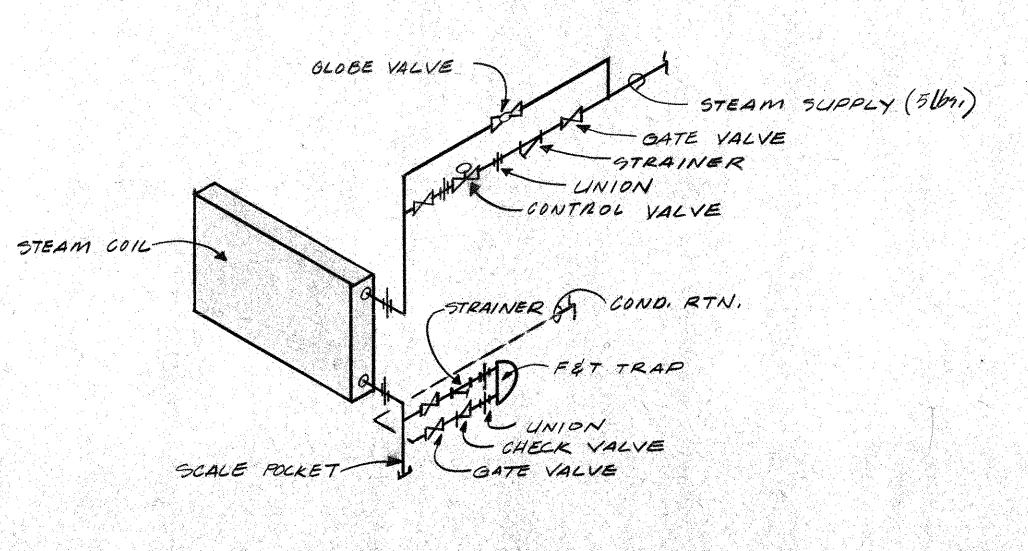

STEAM COIL PIPING DIAGRAM NO SCALE

PARTIAL GECOND FLOOR PLAN - MECHANICAL

LOCATIONS OF EXISTING EQUIPMENT HAS BEEN TAKEN FROM BEST AVAILABLE.
INFORMATION AND THE DRAWINGS ARE INTENDED TO BE USED FOR INFORMATIONAL
PURPOSES ONLY. THE CONTRACTOR IS NOT TO SCALE DRAWINGS OR ASSUME THAT ALL
EQUIPMENT IS SHOWN. HE SHALL VISIT THE SITE TO DETERMINE THE TOTAL
EXTENT OF REMOVALS AS DIAGRAMMED ON THE PURNS. EXTRA COMPENSATION FOR
FAILURE TO COMPLY WITH THE ABOVE STATEMENTS WILL NOT BE CONSIDERED.

NOTE:
ANY ELECTRICAL, MECHANICAL OR STRUCTURAL REVISIONS TO ORIGINAL DESIGN DUE TO THE SUBSTITUTION OF EQUIPMENT SHALL BE THE RESPONSIBILITY OF THE MECHANICAL CONTRACTOR.

SHEET TITLE

MECHANICAL

PARTIAL SECOND FLOOR PLAN -

COCIATES

dp

ARCHITECTS PLANNERS

CRANSTON PHODE ISLAND

RENOVATIONS

WARNICK

SCHOOL


LABS

SCIENCE

ALDRICH

JK. HIGH

PEVISIONS

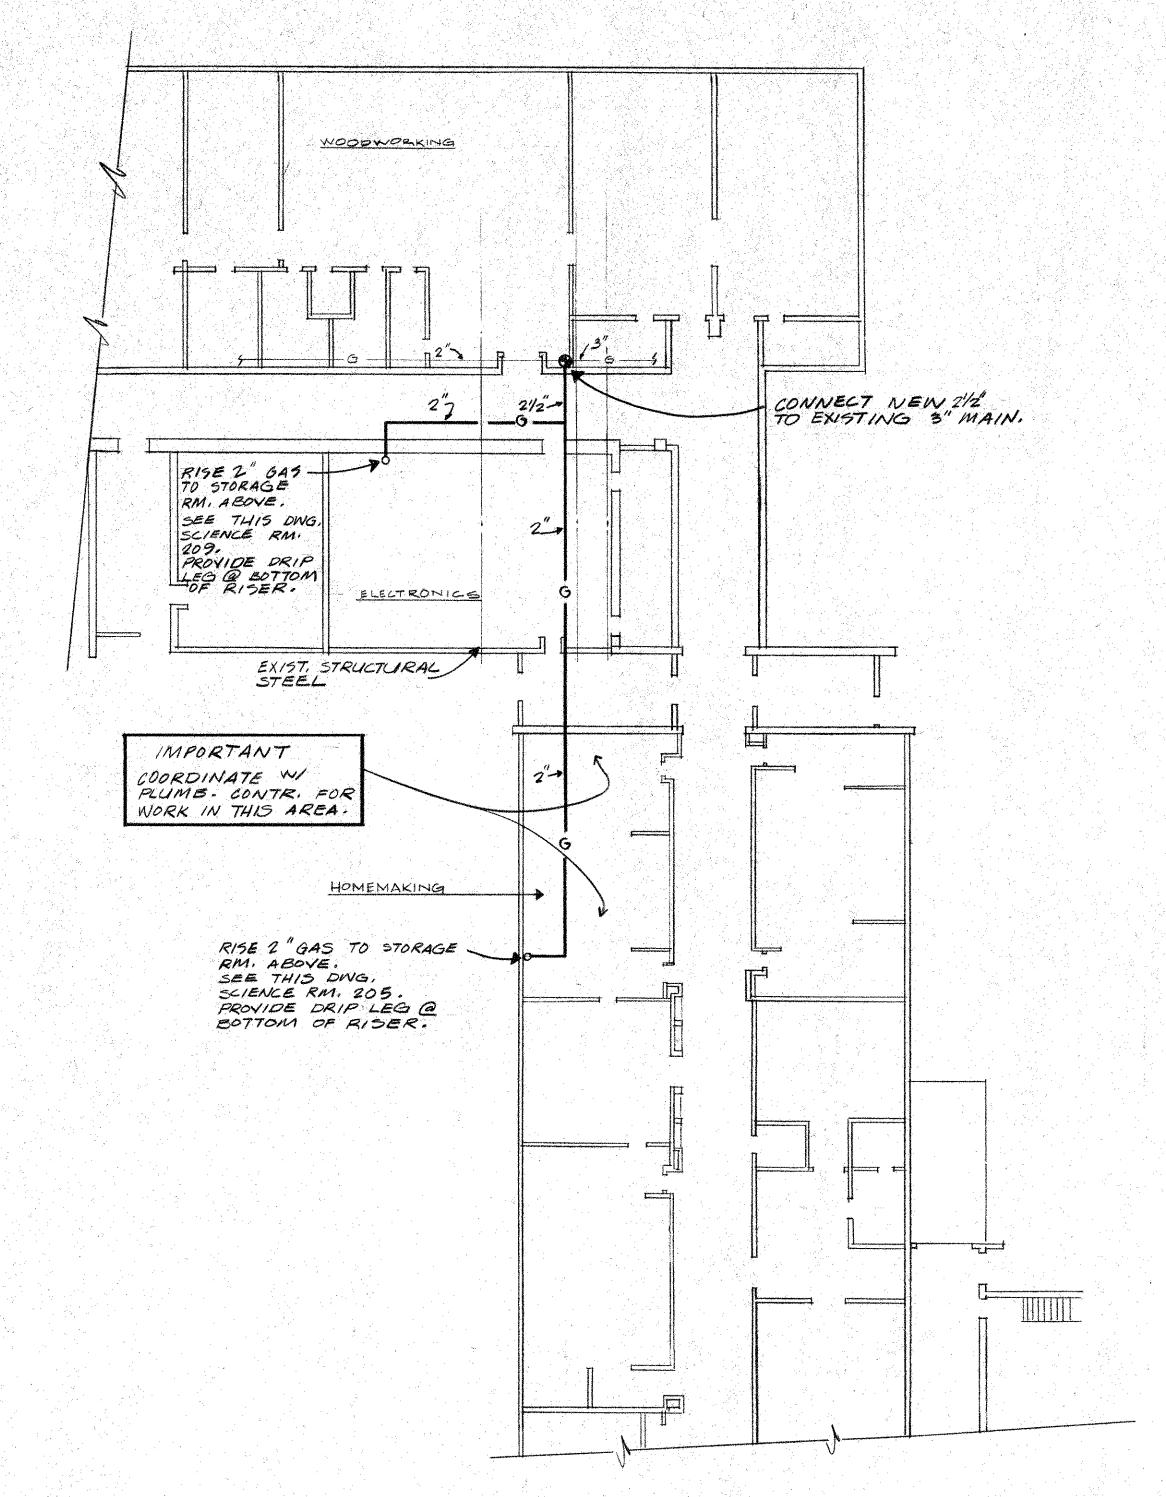

	GA5	FIRED	MA	KE UP	AIR L	INIT	SCH	EDUL	-=		
MARK	SUPPLY	O.A. CFM	EAP	INPUT BTUH	OUTPUT BTUH	CFH	TEMP. RISE	HP	V0L75	WEIGHT	DESCRIPTION
MUAU - 1 MUAU - 2	1900	1900	.5/"	200,000	154,000	200	71°F.	Ž	208/3¢	500 lb3,	TRANE GRNCO20 W/

PROVIDE PRESSURE REGULATOR & FILTERS

NO SCALE

GAS FIRED ROOF
TOP UNIT


GAS INLET

UNITY MEGR'S
ROOF CURB
ROOF
ROOF
GAS PIPING
UNION

GAS PIPING
DUCT STIFFENER
G.C.

GAS FIRED ROOF TOP UNIT DETAIL MUAU

PARTIAL FIRST FLOOR PLAN - GAS PIPING

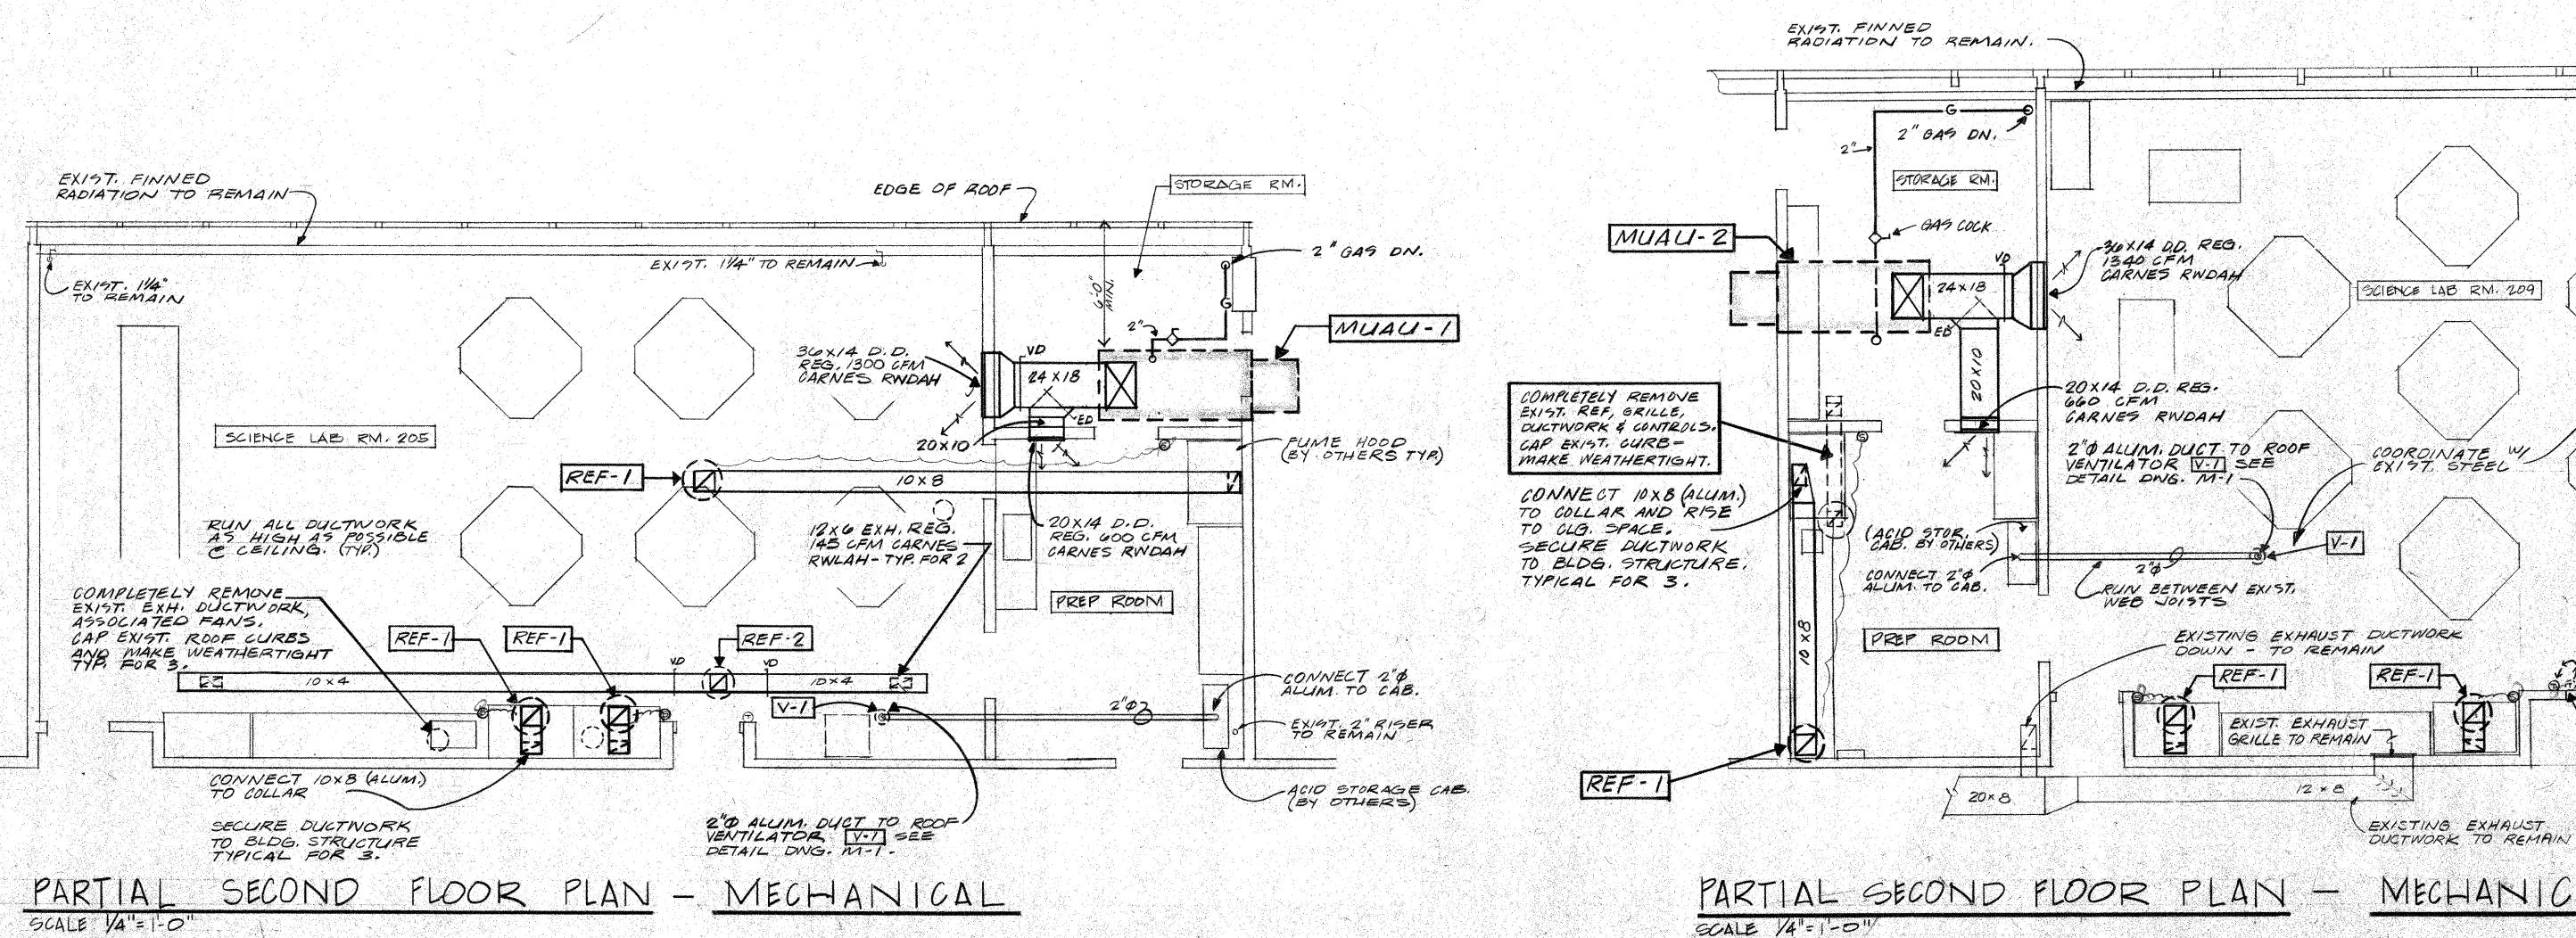

LOCATIONS OF EXISTING EQUIPMENT HAS BEEN TAKEN FROM BEST AVAILABLE INFORMATION AND THE DRAWINGS ARE INTENDED TO BE USED FOR INFORMATIONAL PURPOSES ONLY. THE CONTRACTOR IS NOT TO SCALE DRAWINGS OF ASSUME THAT ALL EQUIPMENT IS SHOWN. HE SHALL VISIT THE SITE TO DETERMINE THE TOTAL EXTENT OF REMOVALS AS DIAGRAMMED ON THE PLANS. EXTRA COMPENSATION FOR FAILURE TO COMPLY WITH THE ABOVE STATEMENTS WILL NOT BE CONSIDERED.

NOTE:

ANY ELECTRICAL, MECHANICAL OR STRUCTURAL REVISIONS TO ORIGINAL DESIGN DUE
TO THE SUBSTITUTION OF EQUIPMENT SHALL BE THE RESPONSIBILITY OF THE MECHANICAL CONTRACTOR.

TREMOVE & RELOCATE EXIST. PNEUMATIC

SHEET TITLE
PARTIAL FEOND
FLOOR PLAN MECHANICAL

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OCIATES

ARCHITECTS
PLANNERS


CRANSTON
RHODE ISLAND


PROJECT

PHOJECT
RENOVATIONS
TO
WARWICK
SCHOOL
SCIENCE
LABS

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PARTIAL SECOND FLOOR PLAN - POWER \$ SIGNAL SCALE: 1/4" = 1'-0"

		FIXTUR	RE SCHEDULE		
TYPE	MANUFACTURER	CATALOG NO.	LAMPS	MOUNTING	COMMENTS
Α	DAY-O-LITE	AR7-T440	4-F40 SPEC35/RS/EW-11	SUSP. TO MATCH EXIST.	
8	DAY-O-LITE	SL4-140	1-F405PEC35/RS/EW-11	SURFACE / CEILING	
C	PAY-O-LITE	SL4-T240	2-F405PEC35/RS/EW-11	SURFACE / CEILING	
D	DAY-O-LITE	AR7-240	2-F40 SPEC 35/RS/EW-11	SUSP. 1-0" STEMS	

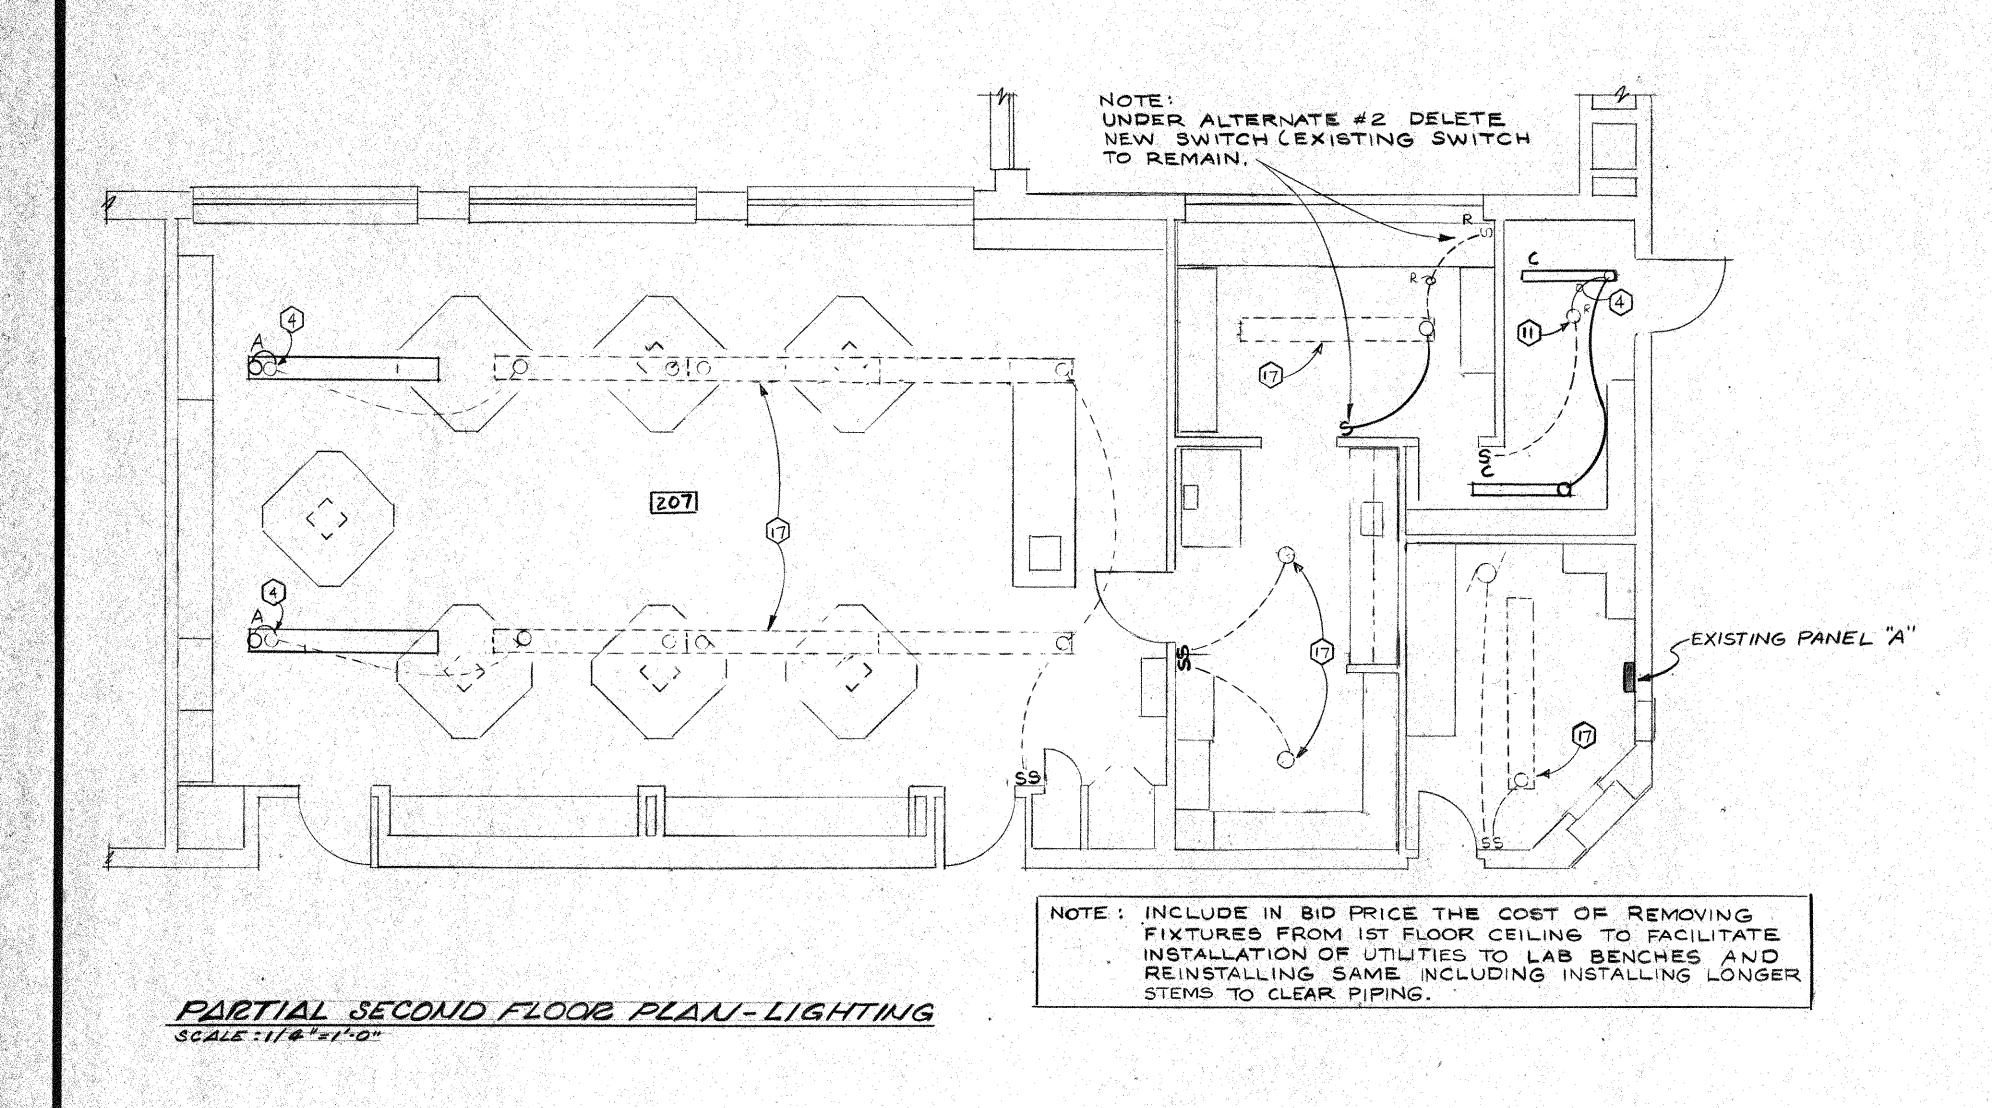NOTES

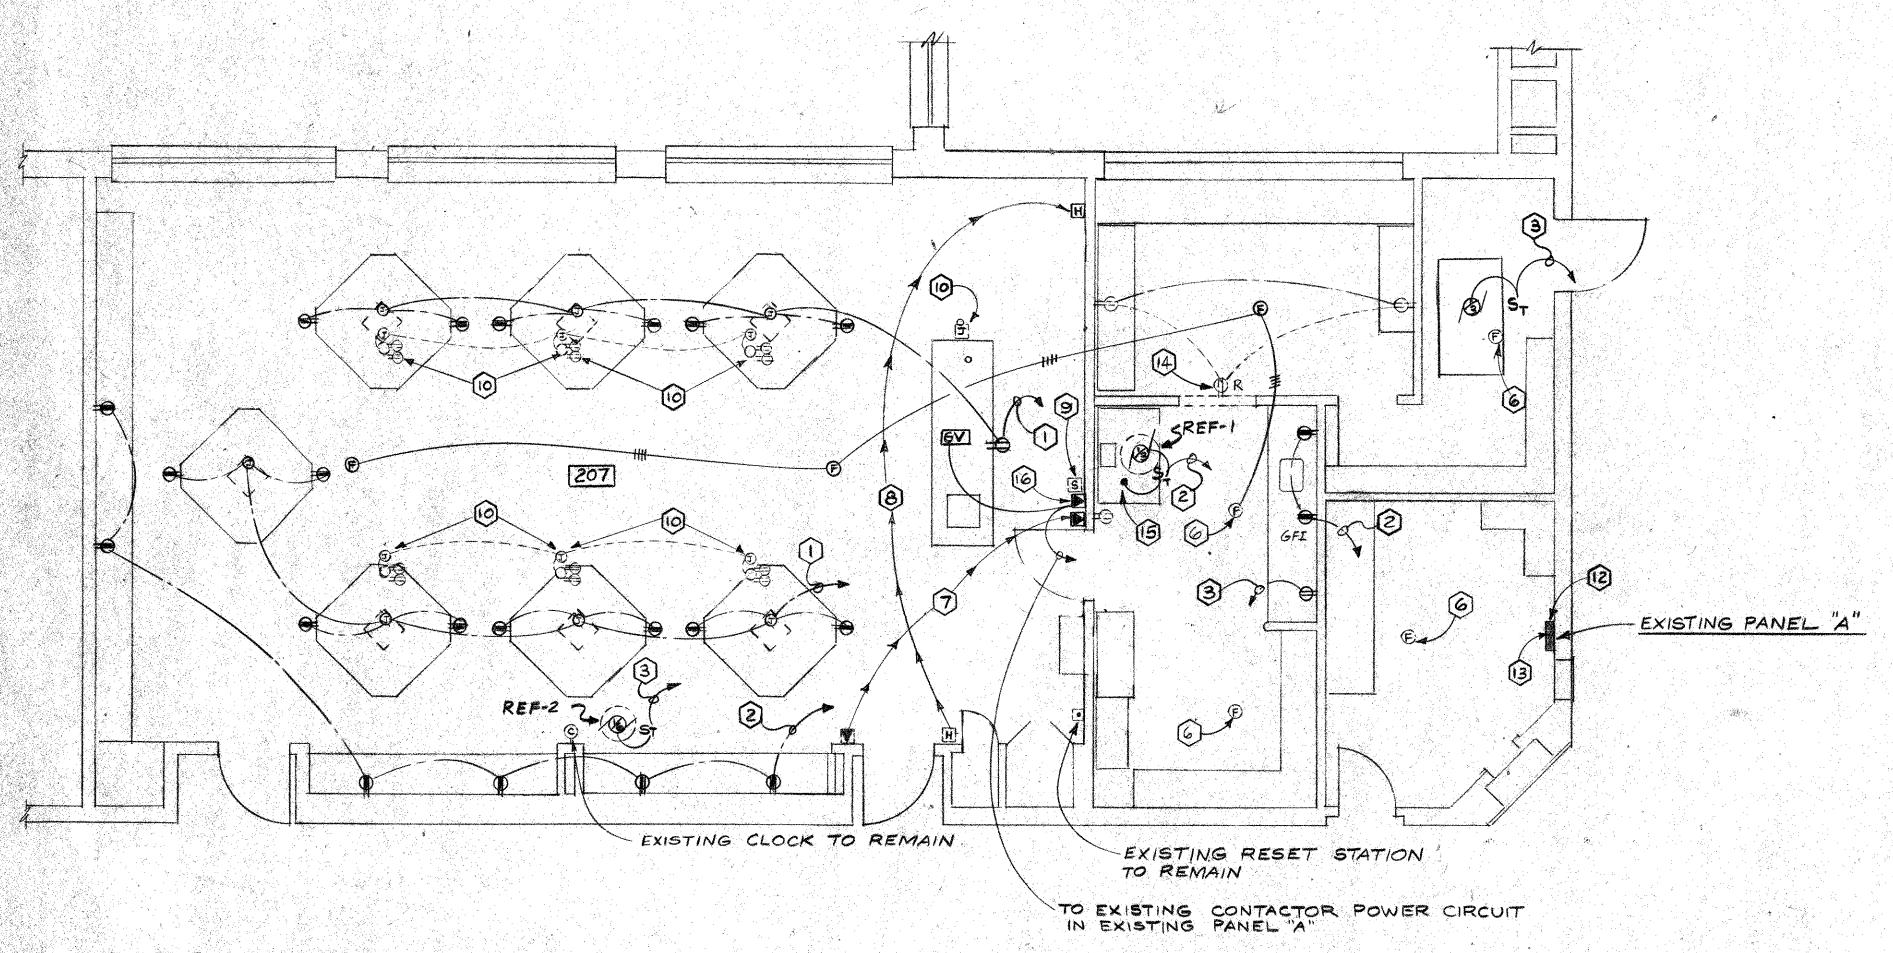- 1) TO NEW 20A IP G.F.I CIRCUIT BKR. IN PANEL "A" VIA EXISTING RELAY.
- TO NEW 20A IP G.F.I CIRCUIT BKR. IN PANEL "A" VIA
- 3 TO NEW 20A IP CIRCUIT BKR. IN PANEL "A".
- 4 TIE INTO EXISTING LIGHTING CIRCUIT
- 6 ALL WIRING TO LAB TABLES SHALL BE FROM BELOW
- 6 EXISTING F.A. THERMODETECTOR TO REMAIN
- RELOCATE EXISTING EMERGENCY STOP STATION AS INDICATED, PROVIDE NEW WIRING FROM NEW LOCATION TO EXISTING RELAY.
- B RELOCATE EXISTING CLASSROOM SOUND SYSTEM HAND-SET STATION AS INDICATED. EXTEND EXISTING WIRING TO NEW LOCATION
- 9 EXISTING CLASSROOM SOUND SYSTEM SPEAKER TO
- REMOVE EXISTING STANCHION AND QUADRAPLEX RECEPTACLES ALONG W/ RELATED WIRING.
- REMOVE EXISTING LIGHTING IN THIS ROOM AND RE-PLACE WITH NEW FIXTURES AS INDICATED. REVISE SWITCHING AS INDICATED
- (2) PROVIDE IN EXISTING PANEL "A" 5-20A IP G.F.I. AND 3-20 A IP CIRCUIT BREAKERS. CIRCUIT BREAKERS SHALL BE COMPATIBLE WITH EXISTING CROUSE HINDS TYPE CTL LOAD CENTER.
- B PROVIDE ONE 20 AMP 3 POLE RELAY TO MATCH EXISTING RELAYS. INSTALL IN NEMA I ENCLOSURE AND WIRE TO EXISTING EMERGENCY STOP CONTROL CIRCUIT.
- (4) EXISTING RECEPTACLE TO BE REMOVED . MAINTAIN INTEGRITY OF EXISTING RECEPTACLES TO REMAIN.
- (5) TIE INTO HOOD LT AND RECEPTACLE. SW. FAN WITH HOOD FAN SWITCH
- PROVIDE NEW YELLOW MUSHROOM HEAD MAINT, CONTACT
 IP N.C. CONTROL STATION LABEL "GAS VALVE CONTROL"
 WIRE TO NORMALLY CLOSED MANUAL RESET GAS VALVE
 UNDER DEMO TABLE
- 1 EXISTING LIGHTING FIXTURES TO REMAIN


GENERAL NOTES

- THE ELECTRICAL CONTRACTOR SHALL VISIT THE SITE AND COMPLETELY FAMILIARIZE HIMSELF WITH ALL EXISTING CONDITIONS BEFORE SUBMITTING HIS BID.
- ALL EXISTING ELECTRICAL EQUIPMENT MADE OBSOLETE BY NEW CONSTRUCTION SHALL BE COMPLETELY REMOVED AND DISPOSED OF IN A LEGAL MANNER
- 3 MAINTAIN INTEGRITY OF ALL EXISTING CIRCUITRY TO REMAIN.

<u>LEGEND</u>

- TYPE
- 5 SINGLE POLE SWITCH MTD. 48" A.F.F. TO Q.
- DUPLEX CONVENIENCE OUTLET-MTD. 18" A.F.F. TO
- DUPLEX CONVENIENCE OUTLET MTD. 46" A.F.F. TO Q UNLESS OTHERWISE NOTED
- GROUND FAULT INTERRUPTING RECEPTACLE
- BRANCH CIRCUIT WIRING CONCEALED IN CEILING OR WALL
- --- BRANCH CIRCUIT WIRING CONCEALED IN FLOOR OR WALL

- REQUIRED IF MORE THAN TWO
- # A HOME RUN TO PANEL LETTER INDICATES PANEL NUMERALS INDICATE CIRCUITS.
- JUNCTION BOX SIZE AS REQUIRED BY N.E.C. OR AS NOTED
- FIRE ALARM THERMODETECTOR 135°F FIXED TEMP.
 AND RATE OF RISE. (MATCH EXISTING). TIE INTO
 EXISTING DETECTOR CIRCUIT AS REQUIRED

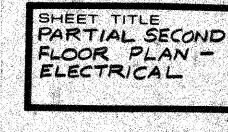

ARCHITECTS
PLANNERS

CRANSTON
RHODE ISLAND

FRANK N/ZADNO

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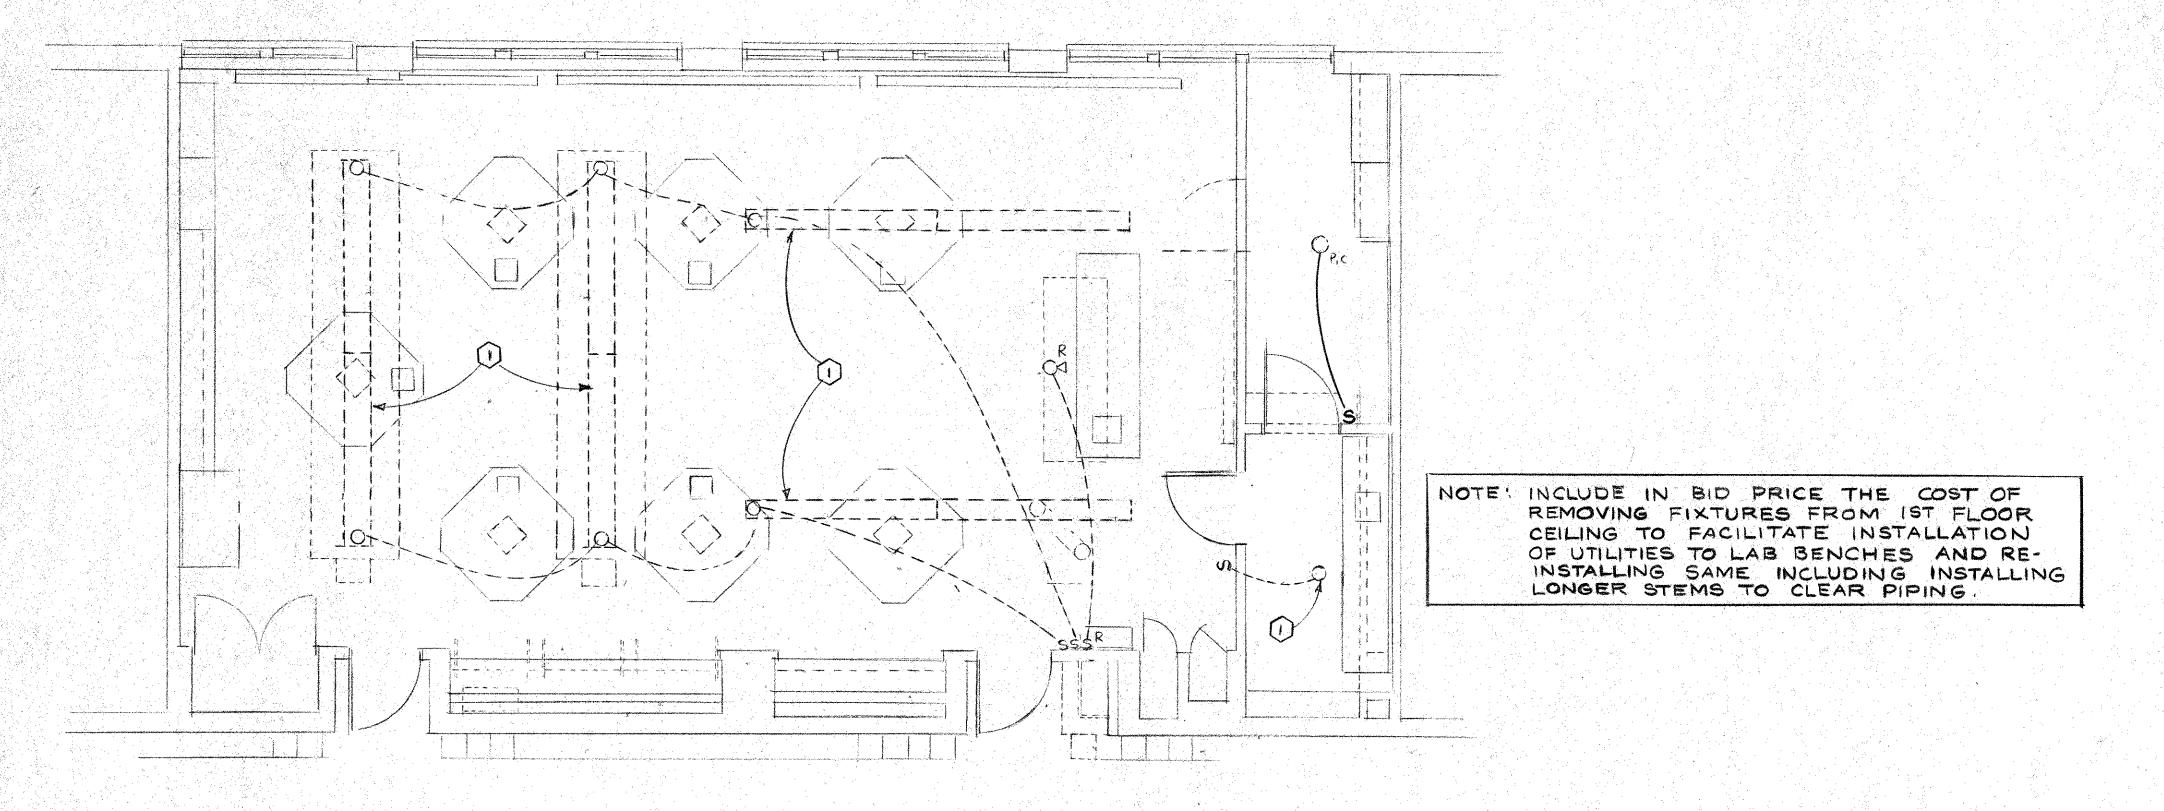
REGISTERED
PROFFESSIONAL ENGINEER

PROJECT Prenovation


WARWICK SCHOOL SCIENCE LABS

GORTON JR. HIGH

JAH 9-6-91 E-1



PARTIAL SECOND FLOOR PLAN - LIGHTING SCALE: 1/4"= 1-0"

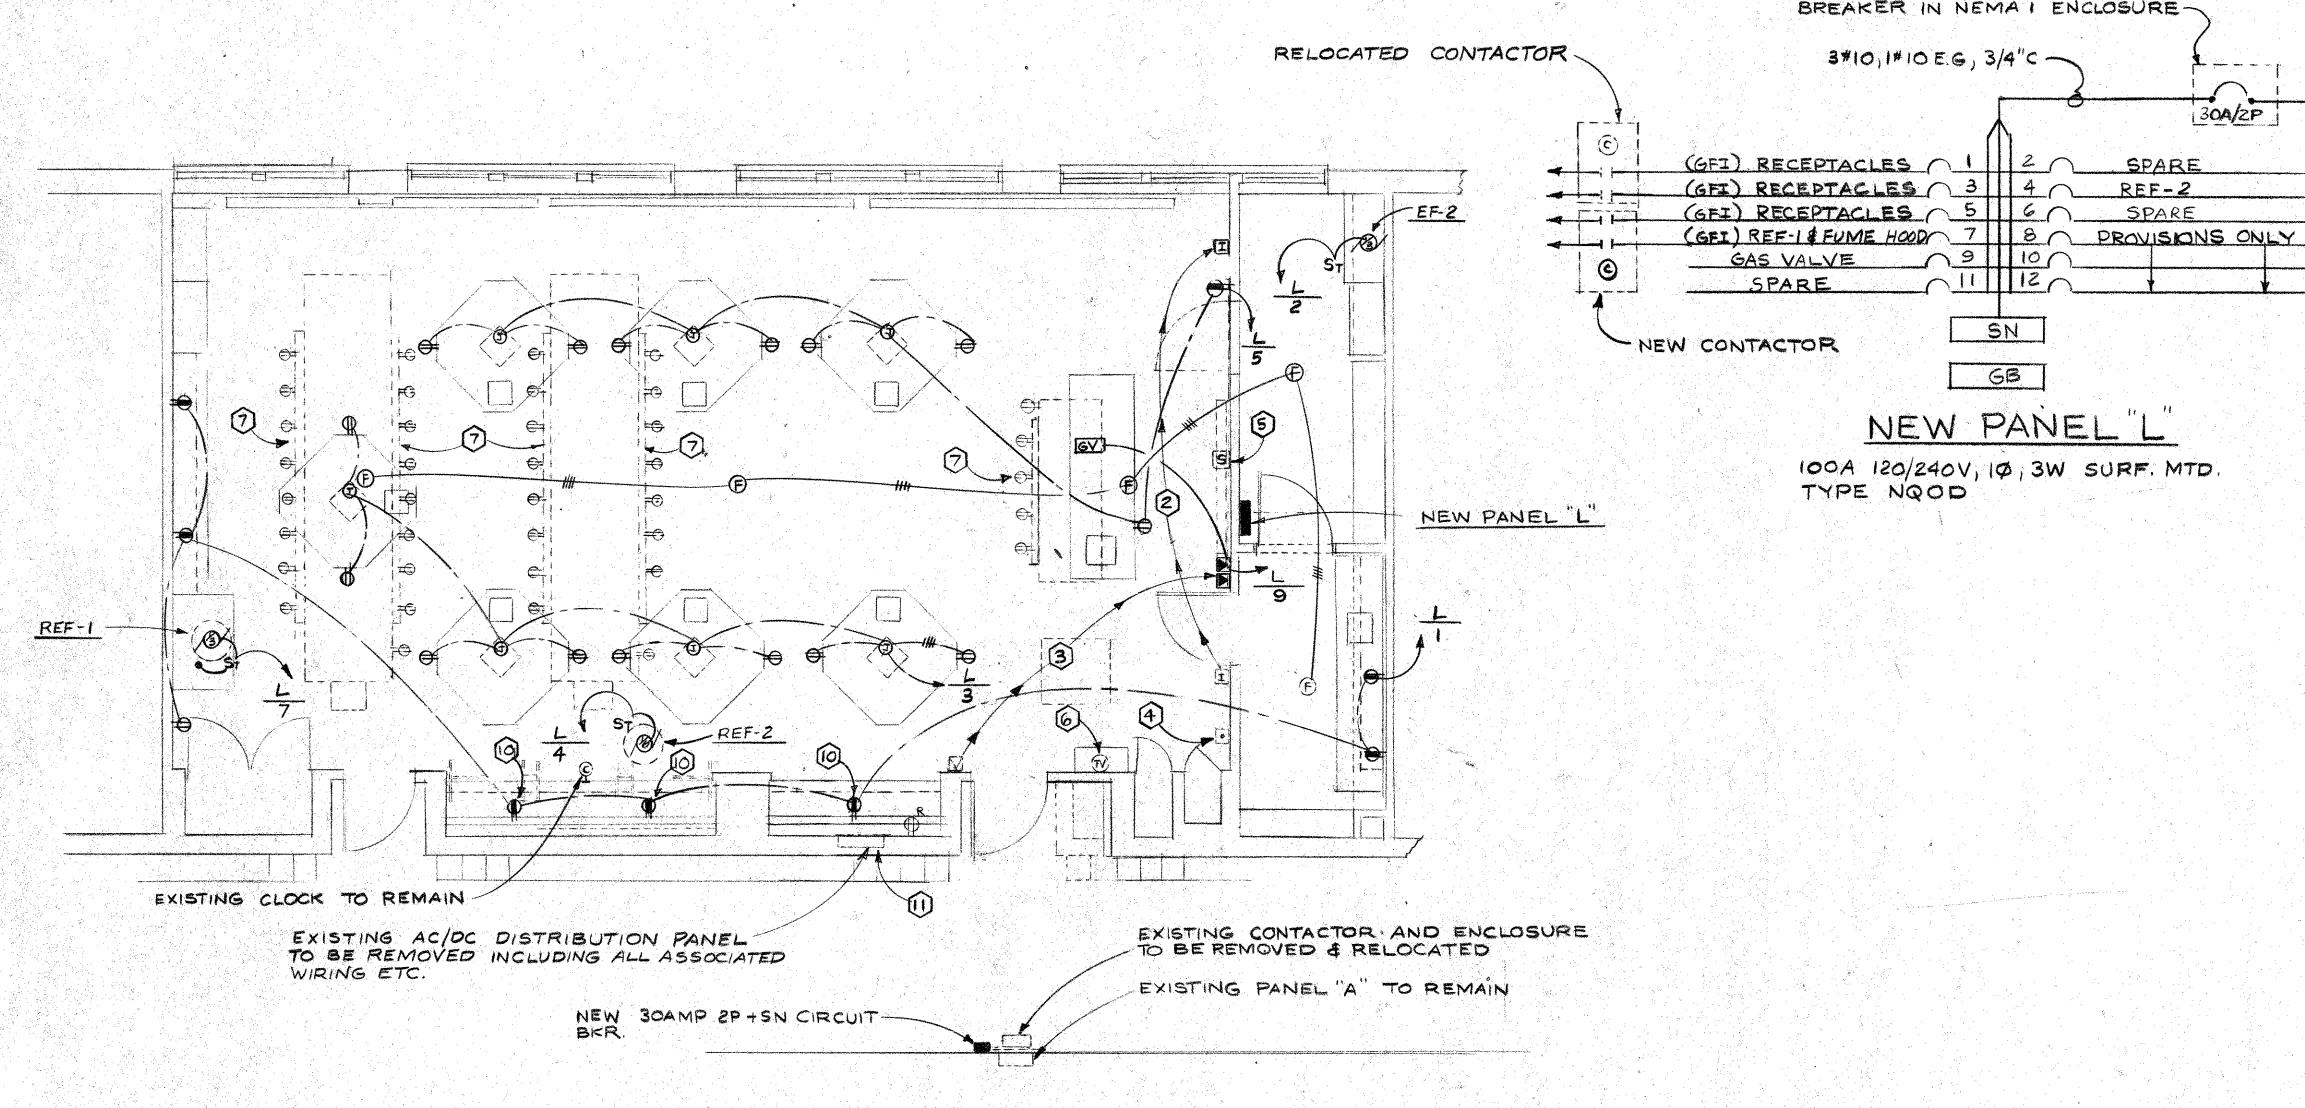

PARTIAL SECOND FLOOR PLAN - POWER AND SIGNAL SCALE : 1/4"= 1-0"

NOTES

3#10, 1#10E6, 3/4"C TIE

PANEL A.

30A/ZP

30A 2P+5N, 120/240V CIRCUIT

3*10,1*10 E.G., 3/4"C -

BREAKER IN NEMA I ENCLOSURE-


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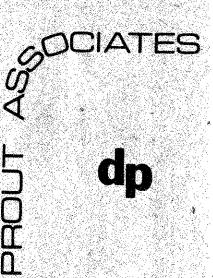
GB


NEW PANEL L

100A 120/240V, 10, 3W SURF. MTD. TYPE NOOD


- () EXISTING LIGHTING FIXTURES TO REMAIN
- REMOVE EXISTING CLASSROOM SOUND SYSTEM HANDSET AND RELOCATE AS INDICATED. EXTEND EXISTING WIRING TO NEW LOCATION
- REMOVE EXISTING EMERGENCY POWER DISC. PUSH BUTTON AND RELOCATE AS INDICATED. EXTEND EXISTING WIRING TO NEW LOCATION
- EXISTING EMERGENCY POWER DISC. SYSTEM RESET TO REMAIN.
- S EXISTING CLASSROOM SPEAKER TO REMAIN
- @ EXISTING T.V. OUTLET TO REMAIN
- TREMOVE EXISTING WIRING TO ALL BENCHES
- REMOVE EXISTING 2 POLE CONTACTOR AND RELOCATE TO ABOVE NEW PANEL "L". PROVIDE NEW 2 POLE CONTACTOR TO MATCH EXISTING CONTACTOR AND MOUNT ADJACENT TO EXISTING. WIRE BOTH CON-TACTORS TO BE CONTROLLED AS PER EXISTING SYSTEM.
- PROVIDE NEW YELLOW MUSHROOM HEAD MAINTAINED CONTACT IP N.C. CONTROL STATION. LABEL "GAS VALVE CONTROL'. WIRE TO NORMALLY CLOSED MANUAL RESET GAS VALVE UNDER DEMO. TABLE.
- UNDER ALTERNATE #13 NEW RECEPTACLE TO BE DELETED
- UNDER ALTERNATE #13 EXISTING DISTRIBUTION PANEL TO REMAIN



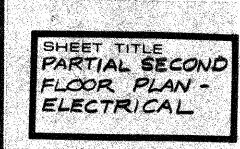

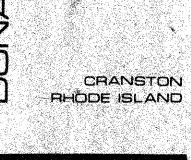


ARCHITECTS PLANNERS

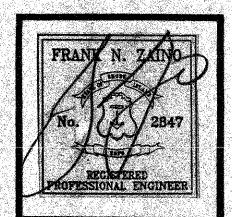


PENOVATIONS WARWICK SCHOOL SCIENCE LABS

ALDRICH JR. HIGH

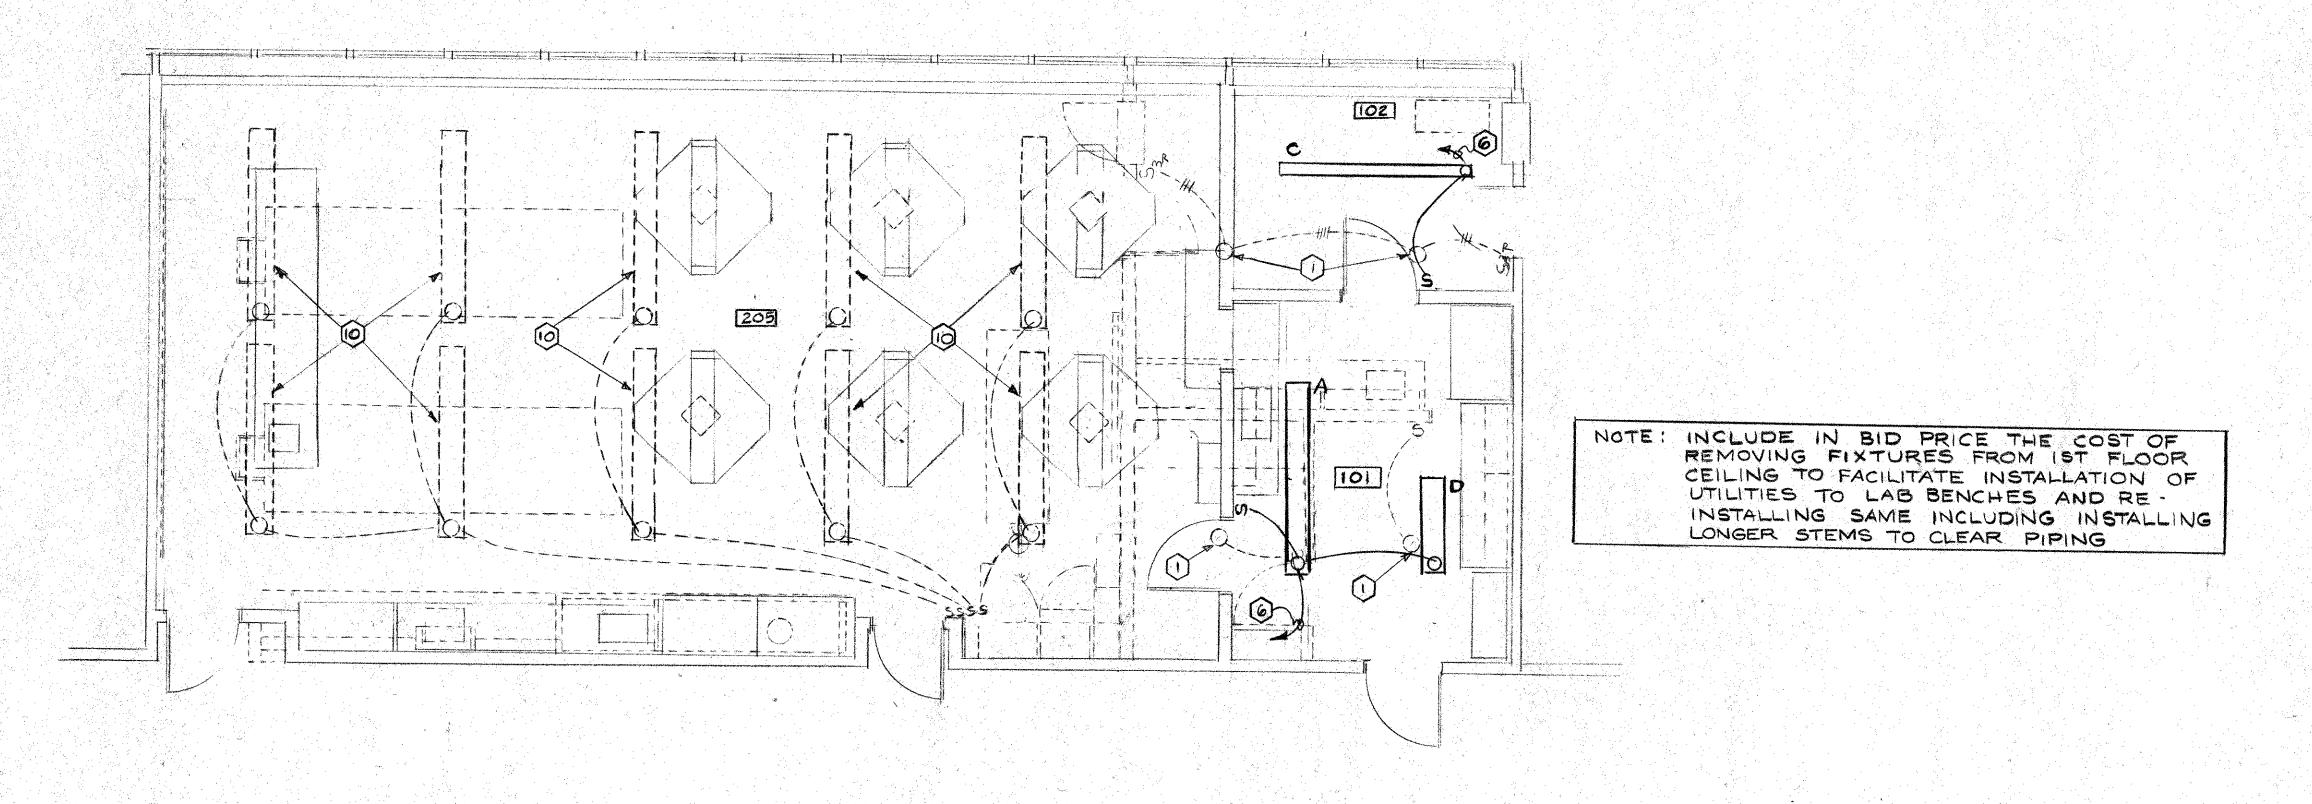


PARTIAL SECOND FLOOR PLAN- LIGHTING

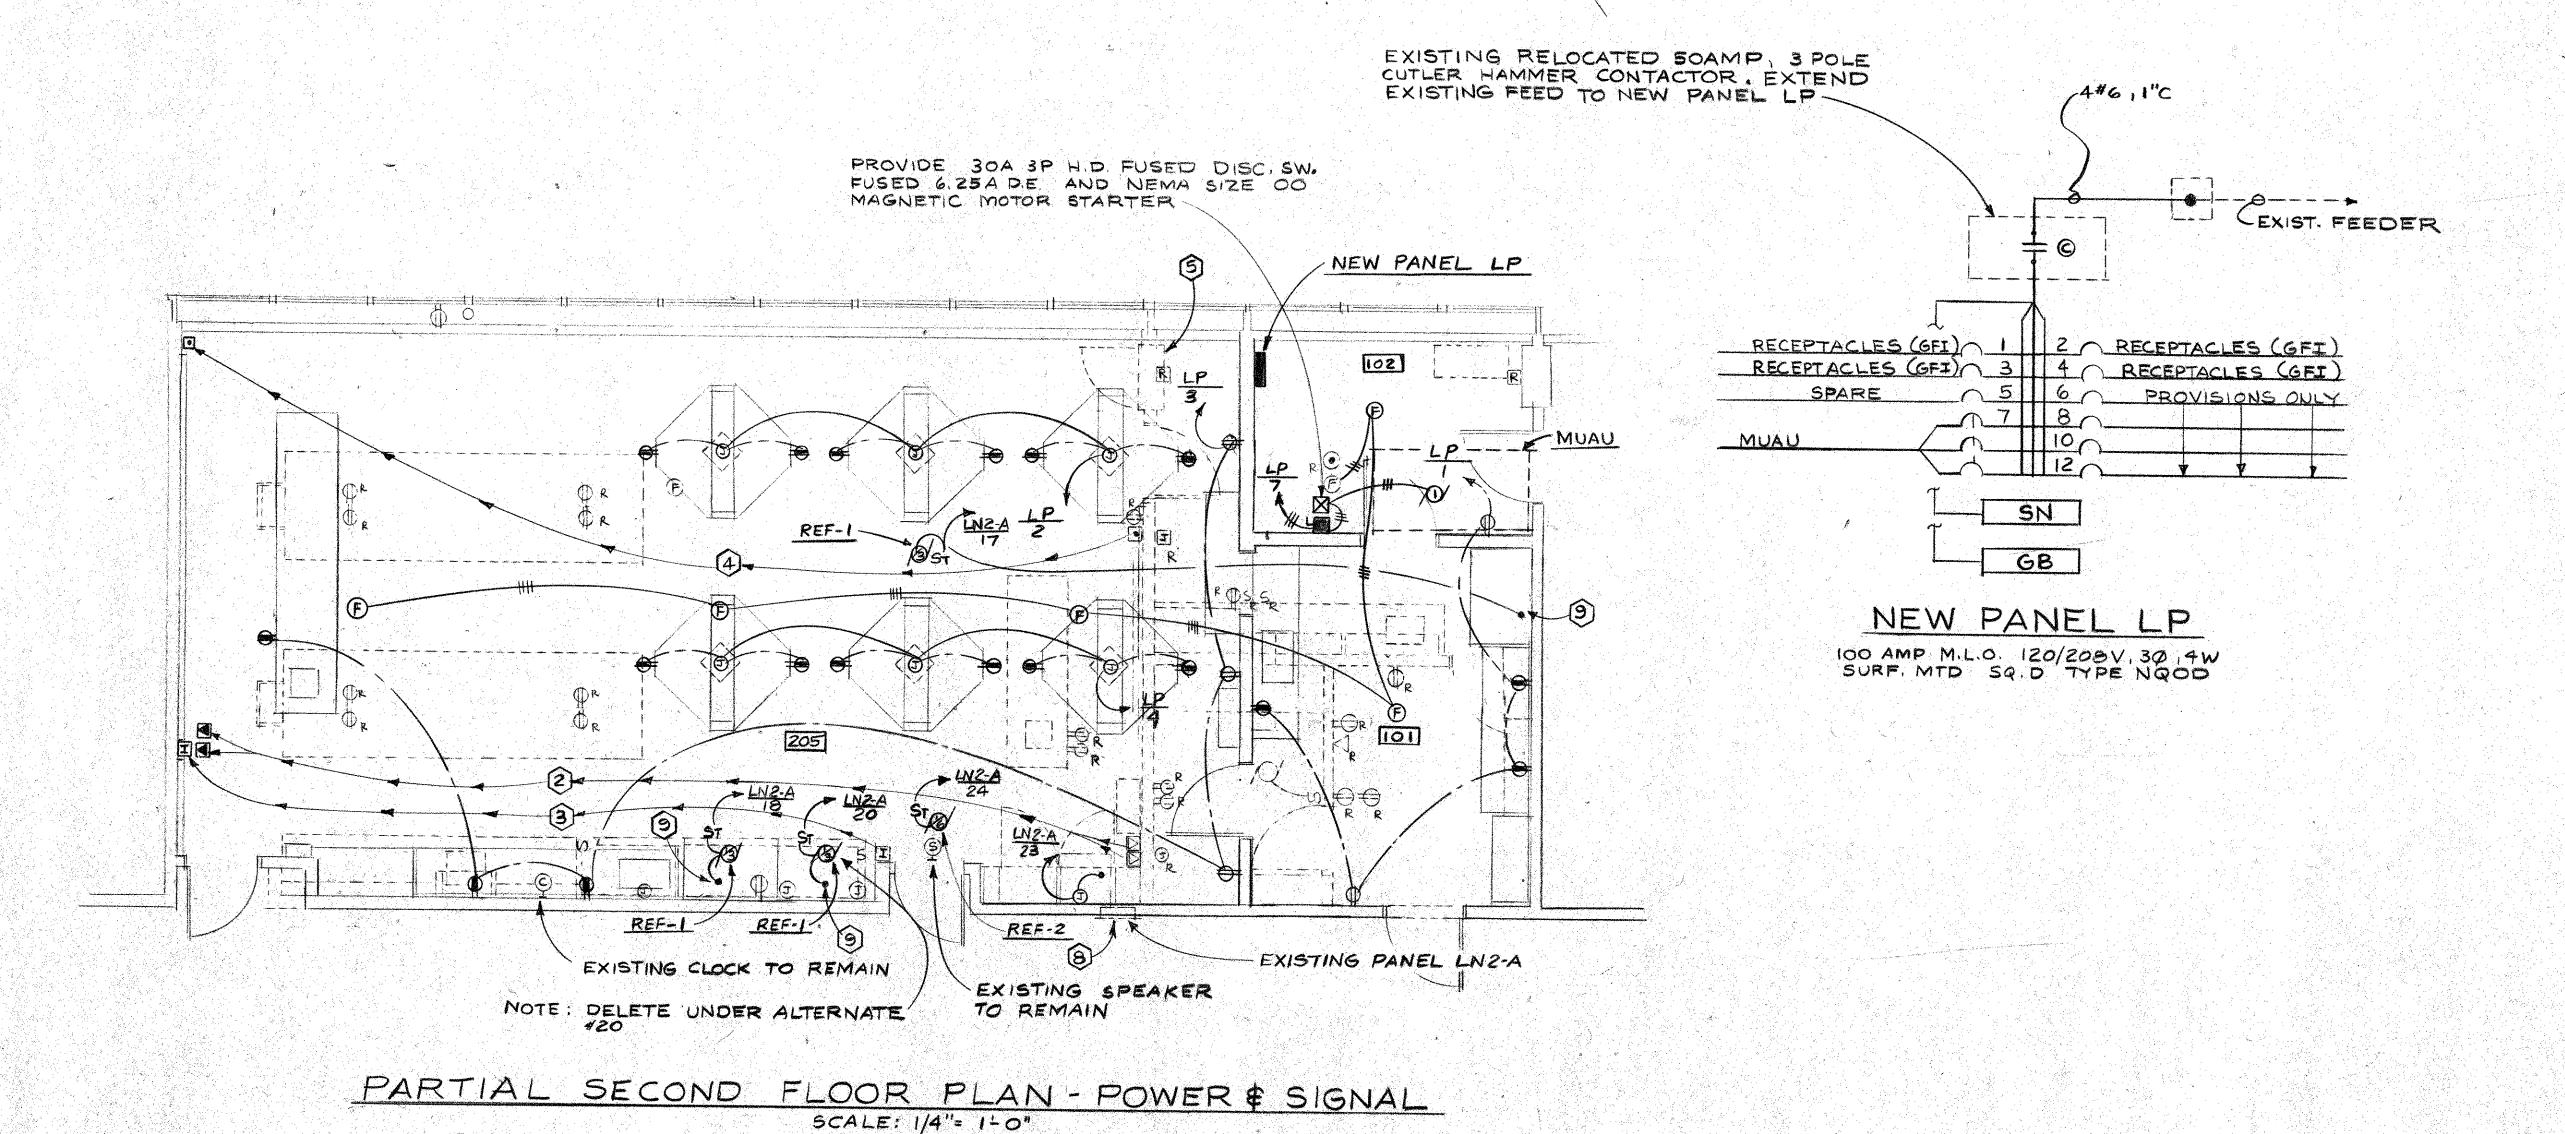

NOTES

- PREMOVE EXISTING LIGHTING FIXTURES IN THIS ROOM AND REPLACE WITH NEW FIXTURES AS INDICATED.
- PELOCATE EXISTING EMERGENCY STOP STATIONS AS INDICATED. EXTEND EXISTING WIRING TO NEW LOCATION.
- (3) RELOCATE EXISTING CLASSROOM SOUND SYSTEM HANDSET AS INDICATED. EXTEND EXISTING WIRING TO NEW LOCATION
- PELOCATE EXISTING EMERGENCY STOP SYSTEM
 RESET BUTTON AS INDICATED. EXTEND EXISTING
 WIRING TO NEW LOCATION
- S EXISTING LAB ELECTRICAL DISTRIBUTION PANEL TO BE REMOVED
- 6 TIE INTO EXISTING LIGHTING CIRCUIT
- TIE INTO EXISTING FIRE ALARM DETECTOR CIRCUIT
- REPLACE EXISTING CIRCUIT BREAKERS * 18, * 20, *17 AND *23 IN EXISTING PANEL LN2-A WITH NEW 20 AMP GROUND FAULT INTERRUPTION SINGLE POLE CIRCUIT BREAKERS.
- 9 TIE INTO HOOD LT. & RECEPTACLES.
- EXISTING LIGHT FIXTURE TO REMAIN

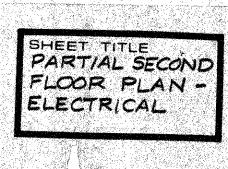


CEIATES

Sylvinia

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ARCHITECTS
PLANNERS

CRANSTON
PHODE ISLAND

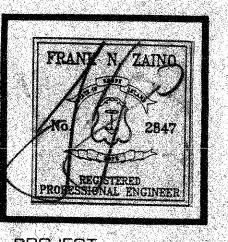


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PENOVATIONS WARWICK

SCHOOL SCIENCE LABS


VETERANS HIGH SCHOOL

DAM 9:6:91 E-3

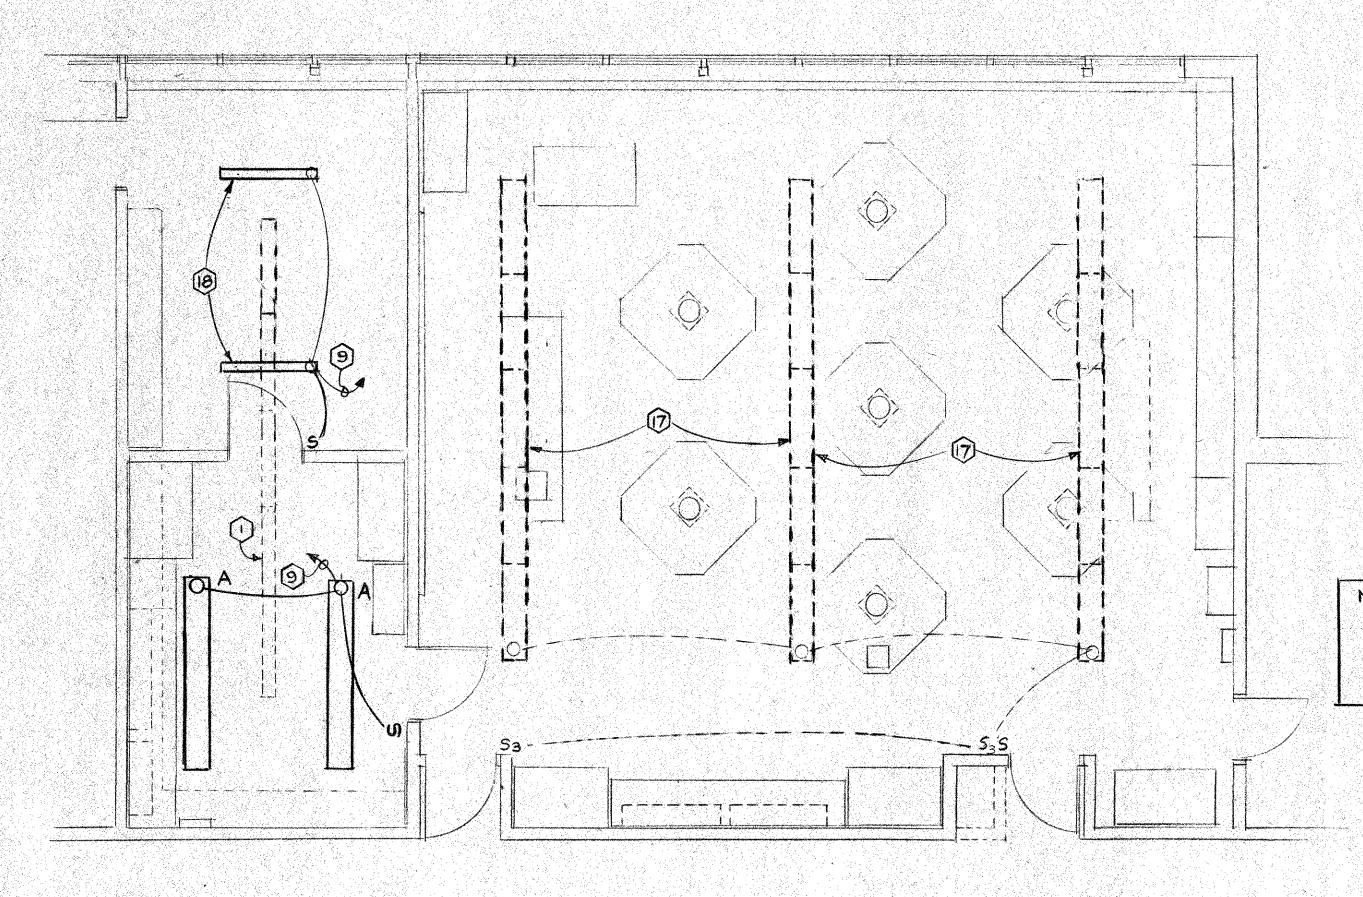

NOTE: INCLUDE IN BID PRICE THE COST OF
REMOVING FIXTURES FROM IST FLOOR
CEILING TO FACILITATE INSTALLATION OF
UTILITIES TO LAB BENCHES AND REINSTALLING SAME INCLUDING INSTALLING
LONGER STEMS TO CLEAR PIPING

PARTIAL SECOND FLOOR PLAN-LIGHTING

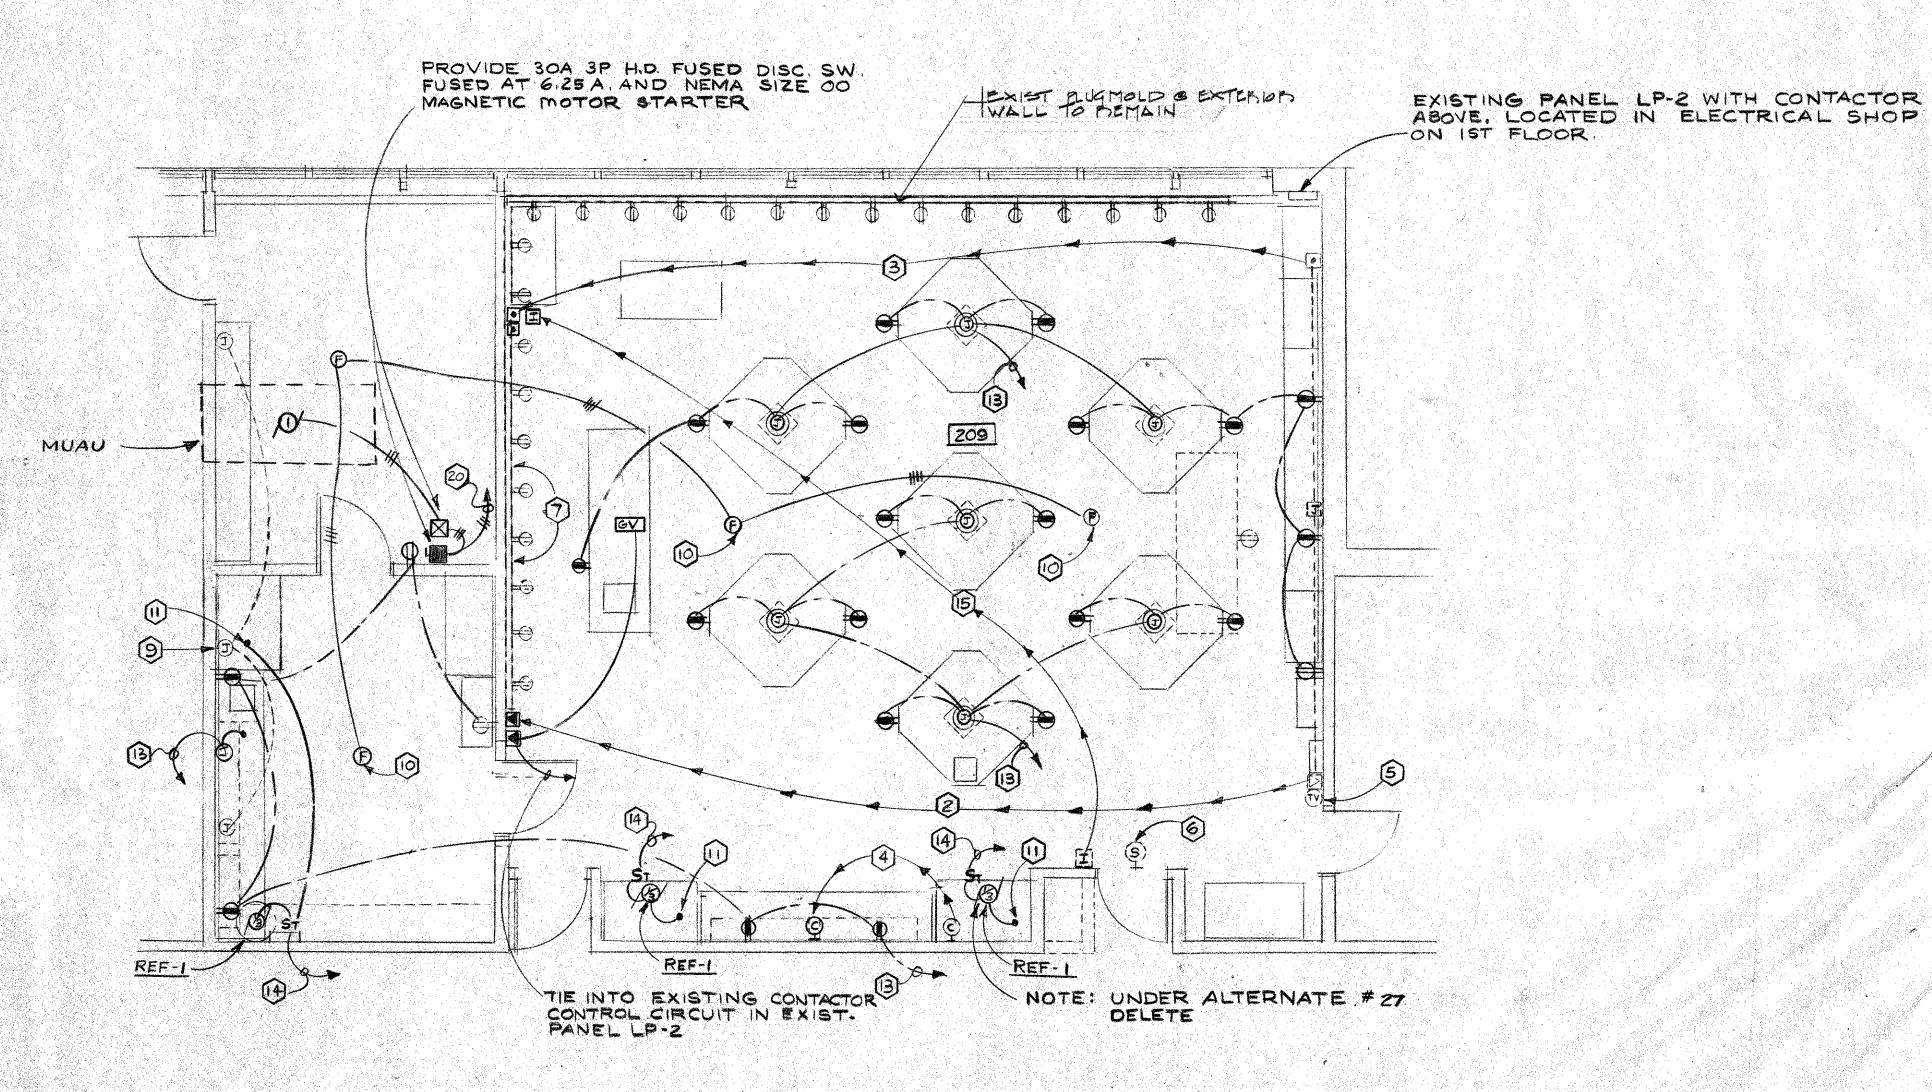

PARTIAL SECOND FLOOR PLAN-POWER & SIGNAL SCALE: 1/8"=1-0"

NOTES

- REMOVE EXISTING LIGHTING FIXTURES IN THIS ROOM AND REPLACE WITH NEW FIXTURES AS INDICATED.
- REMOVE EXISTING EMERGENCY POWER DISC. PUSH BUTTON AND RELOCATE AS INDICATED. EXTEND EXISTING WIRING TO NEW LOCATION.
- (3) REMOVE EXISTING EMERGENCY POWER DISC.
 SYSTEM RESET BUTTON AND RELOCATE AS
 INDICATED. EXTEND EXISTING WIRING TO NEW
 LOCATION
- REMOVE EXISTING CLOCK AND RELOCATE AS INDICATED, EXTEND EXISTING WIRING TO NEW LOCATION
- S EXISTING TV. OUTLET TO REMAIN
- @ EXISTING SOUND SYSTEM SPEAKER TO REMAIN
- 1 REMOVE EXISTING PLUGMOLD
- (8) RELOCATE EXISTING JUNCTION BOX TO CLEAR NEW FUME HOOD. EXTEND EXISTING CONDUIT AND WIRE AS REQUIRED.
- 1 TIE INTO EXISTING LIGHTING CIRCUIT
- PROVIDE NEW F.A. THERMODETECTOR TO MATCH EXISTING THERMODETECTOR AND TIE INTO EXIST. DETECTOR CIRCUIT
- (1) TIE INTO HOOD LIGHT AND RECEPTACLES.
- PROVIDE IN EXISTING PANEL LP-2 SEVEN (7) NEW 20A, IP G.F.I. CIRCUIT BREAKERS TO REPLACE EXISTING SPARE CIRCUIT BREAKERS.
- (B) TO NEW 20A, IP G.F.I. CIRC. BKR. IN EXISTING PANEL LP-2 VIA EXISTING RELAY CONTACT.
- (4) TO NEW 20A, IP G.F.I. CIRC. BKR. IN EXISTING PANEL LP-2.
- RELOCATE EXISTING CLASSROOM SOUND SYSTEM HANDSET AS INDICATED, EXTEND EXISTING WIRING TO NEW LOCATION.
- PROVIDE NEW YELLOW MUSHROOM HEAD MAINT.
 CONTACT IP N.C. CONTROL STATION, LABEL "GAS VALVE CONTROL" AND WIRE TO NORMALLY CLOSED MANUAL RESET GAS VALVE UNDER DEMO TABLE.
- D EXISTING LIGHTING FIXTURES TO REMAIN
- (8) RELOCATE 2-4' ZLAMP STRIP LITES AS INDICATED.
- PROVIDE IN EXISTING PANEL LP.2 ONE 20A 3POLE CIRCUIT BREAKER
- (2) TO NEW 20A 3POLE CIRCUIT BREAKER IN EXISTING PANEL LP-2.
- (1) EXISTING PLUGMOLD TO REMAIN ALONG THIS WALL, RECONNECT TO EXISTING CIRCUIT.

SHEET TITLE
PARTIAL SECOND
FLOOR PLANELECTRICAL

COCIATES


Government

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Government

Anchitects
Planingers

CRANSTON RHODE ISLAND

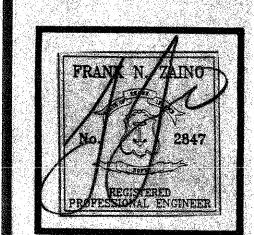

PROJECT
RENOVATIONS
TO
WARWICK
SCHOOL
SCIENCE
LABS

VETERANS HIGH SCHOOL

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REVISIONS