

ABREVIATIONS:

CONCRETE

GRAVITY VENT

OSCILLATING GRAVITY VENT

N.I.C. NOT IN CONTRACT

P.T. PRESSURE TREATED

RD ROOF DRAIN

ROOF EXHAUST FAN

SKYLT SKYLIGHT

VENT PIPE

WIND TURBINE VENT

ROOF PLAN A1.3 /SCALE: 1/16" = 1'-0"

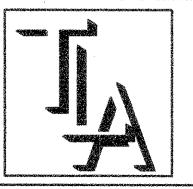
ALDRICH MIDDLE SCHOOL 40,000+/- SQ. FT.

GENERAL NOTES:

- 1. SCRAPE & REMOVE EXISTING GRAVEL FROM ROOF; ROOF FELTS, EDGE METAL, EDGE BLOCKING AND INSULATION TO REMAIN. EXISTING ROOF SYSTEM IS TAR & GRAVEL BUILT-UP ROOFING ON INSULATION OVER CONCRETE SLABS & WOOD DECK AT THE
- 2. USE APPROVED INDEPENDENT INSPECTOR TO VERIFY THE INTEGRITY OF EXISTING ROOF SYSTEM PRIOR TO RE-ROOFING. PATCH AND REPAIR DAMAGED EDGE METAL, EDGE BLOCKING AND INSULATION, WHERE REQUIRED WITH SIMILAR MATERIALS, REVIEW AREAS OF DAMAGE WITH ARCHITECT PRIOR TO PROCEEDING WITH REPAIRS. COST OF REQUIRED REPAIRS TO BE PROCESSED AS CHANGE ORDERS BASED ON UNIT PRICES.
- 3. INSTALL NEW DOUBLE P.T. WOOD BLOCKING AS DETAILED AT PERIMETER OF ROOF, INSULATION, MEMBRANE, EDGE METAL & FLASHING AS SPECIFIED. TIE NEW ROOF DRAINS TO EXISTING LEADERS OR DRAIN LINES AS DETAILED. COMPLETE INSTALLATION OF ALL RELATED FLASHING, LIFT AND RESET MECHANICAL EQUIPMENT AS REQUIRED TO INSTALL FLASHING AND TO MAINTAIN A MIN. 8 INCHES 7. REFER TO TYPICAL DETAILS ON SHEETS A2.1 & A2.2 FOR DETAILING OF VERTICAL DIMENSION BETWEEN ROOF SURFACE AND TOP OF BASE FLASHING.
- ALL EXPOSED EDGE METAL, COPINGS & FLASHING TO BE FACTORY FABRICATED, FASTENED IN ACCORDANCE W/ SMACNA & MANUFACTURER'S RECOMMENDATIONS. FIELD FABRICATED EDGE METAL & COPINGS WILL NOT BE ACCEPTED. ALL EXPOSED EDGE METAL, COPINGS AND FLASHING TO HAVE KYNAR 500 FINISH, COLOR TO BE SELECTED.
- INSTALL COMPLETE SYSTEM AS REQUIRED TO PROVIDE ROOFING MANUFACTURER'S 15 YEAR WARRANTY. SYSTEM TO INCLUDE 60 MIL. NON-REINFORCED E.D.P.M. MEMBRANE, FULLY ADHERED TO 2" ISO INSULATION WITH MIN. DENSITY OF 25 PSI, ANCHORED WITH MIN. PULLOUT* OF 800 PSI TO CONCRETE DECK WITH 14-10 FASTENERS AND %2" PILOT HOLE & 1 ½" MIN. PENETRATION. * 360 PSI @ WOOD DECK WITH HP FASTENERS.
 - 6. RESURFACING OF ROOF TO INCLUDE THE ENTIRE ORIGINAL BUILDING.
 - ROOF PENETRATIONS (I.E., PENETRATION POCKETS, ROOF VENTS, PLUMBING VENTS, CURBS, ETC.
 - ALL DRAINS ARE TO BE AUGURED OUT AFTER ROOF STRIPPING AND/OR ABATEMENT IS COMPLETE, AND ARE TO BE WATER TESTED TO INSURE DRAINAGE AFTER ROOF INSTALLATION.

GENERAL REMOVAL NOTES:

- 1. IT IS THE RESPONSIBILITY OF THE CONTRACTOR TO VERIFY ALL EXISTING CONDITIONS AND DIMENSIONS AS THEY RELATE TO THE RE-ROOFING (ALL DIMENSIONS GIVEN, ARE APPROXIMATE). REPORT ALL OBSERVATIONS AND ANY DISCREPANCIES TO THE ARCHITECT PRIOR TO PROCEEDING WITH THE WORK.
- 2. NO AREA OF REMOVAL IS TO BE LEFT OPEN OVER NIGHT OR DURING ADVERSE WEATHER CONDITIONS. IT IS THE RESPONSIBILITY OF THE CONTRACTOR TO MAINTAIN THE WORK AREAS WEATHER & WATERTIGHT AT THE END OF EACH WORK DAY DURING THE ENTIRE PROJECT. THE CONTRACTOR SHALL BE HELD LIBEL FOR ANY AND ALL WATER DAMAGES CAUSED BY HIS NEGLIGENCE.
- 3. UNLESS OTHERWISE NOTED, ALL REMOVALS ARE TO BE PROPERLY DISPOSED OF
- 4. VERIFY ALL REMOVALS DO NOT AFFECT THE OPERATION OF EXISTING MECHANICAL, ELECTRICAL OR PLUMBING EQUIPMENT ON OR UNDER THE ROOF.
- 5. IN THE EVENT THAT EXISTING UNFORESEEN ASBESTOS OR ASBESTOS RELATED ITEMS ARE ENCOUNTERED DURING CONSTRUCTION, THE CONTRACTOR SHALL IMMEDIATELY NOTIFY THE OWNER AND HALT THE WORK.



THOMAS LONARDO **ASSOCIATES** A CORPORATION

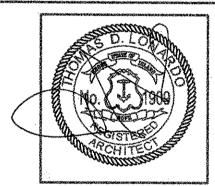
> ARCHITECTURE INTERIOR DESIGN · MANAGEMENT

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WARWICK SCHOOLS RE-ROOFING PROJECTS

> ALDRICH MIDDLE SCHOOL

789 POST ROAD WARWICK RHODE ISLAND



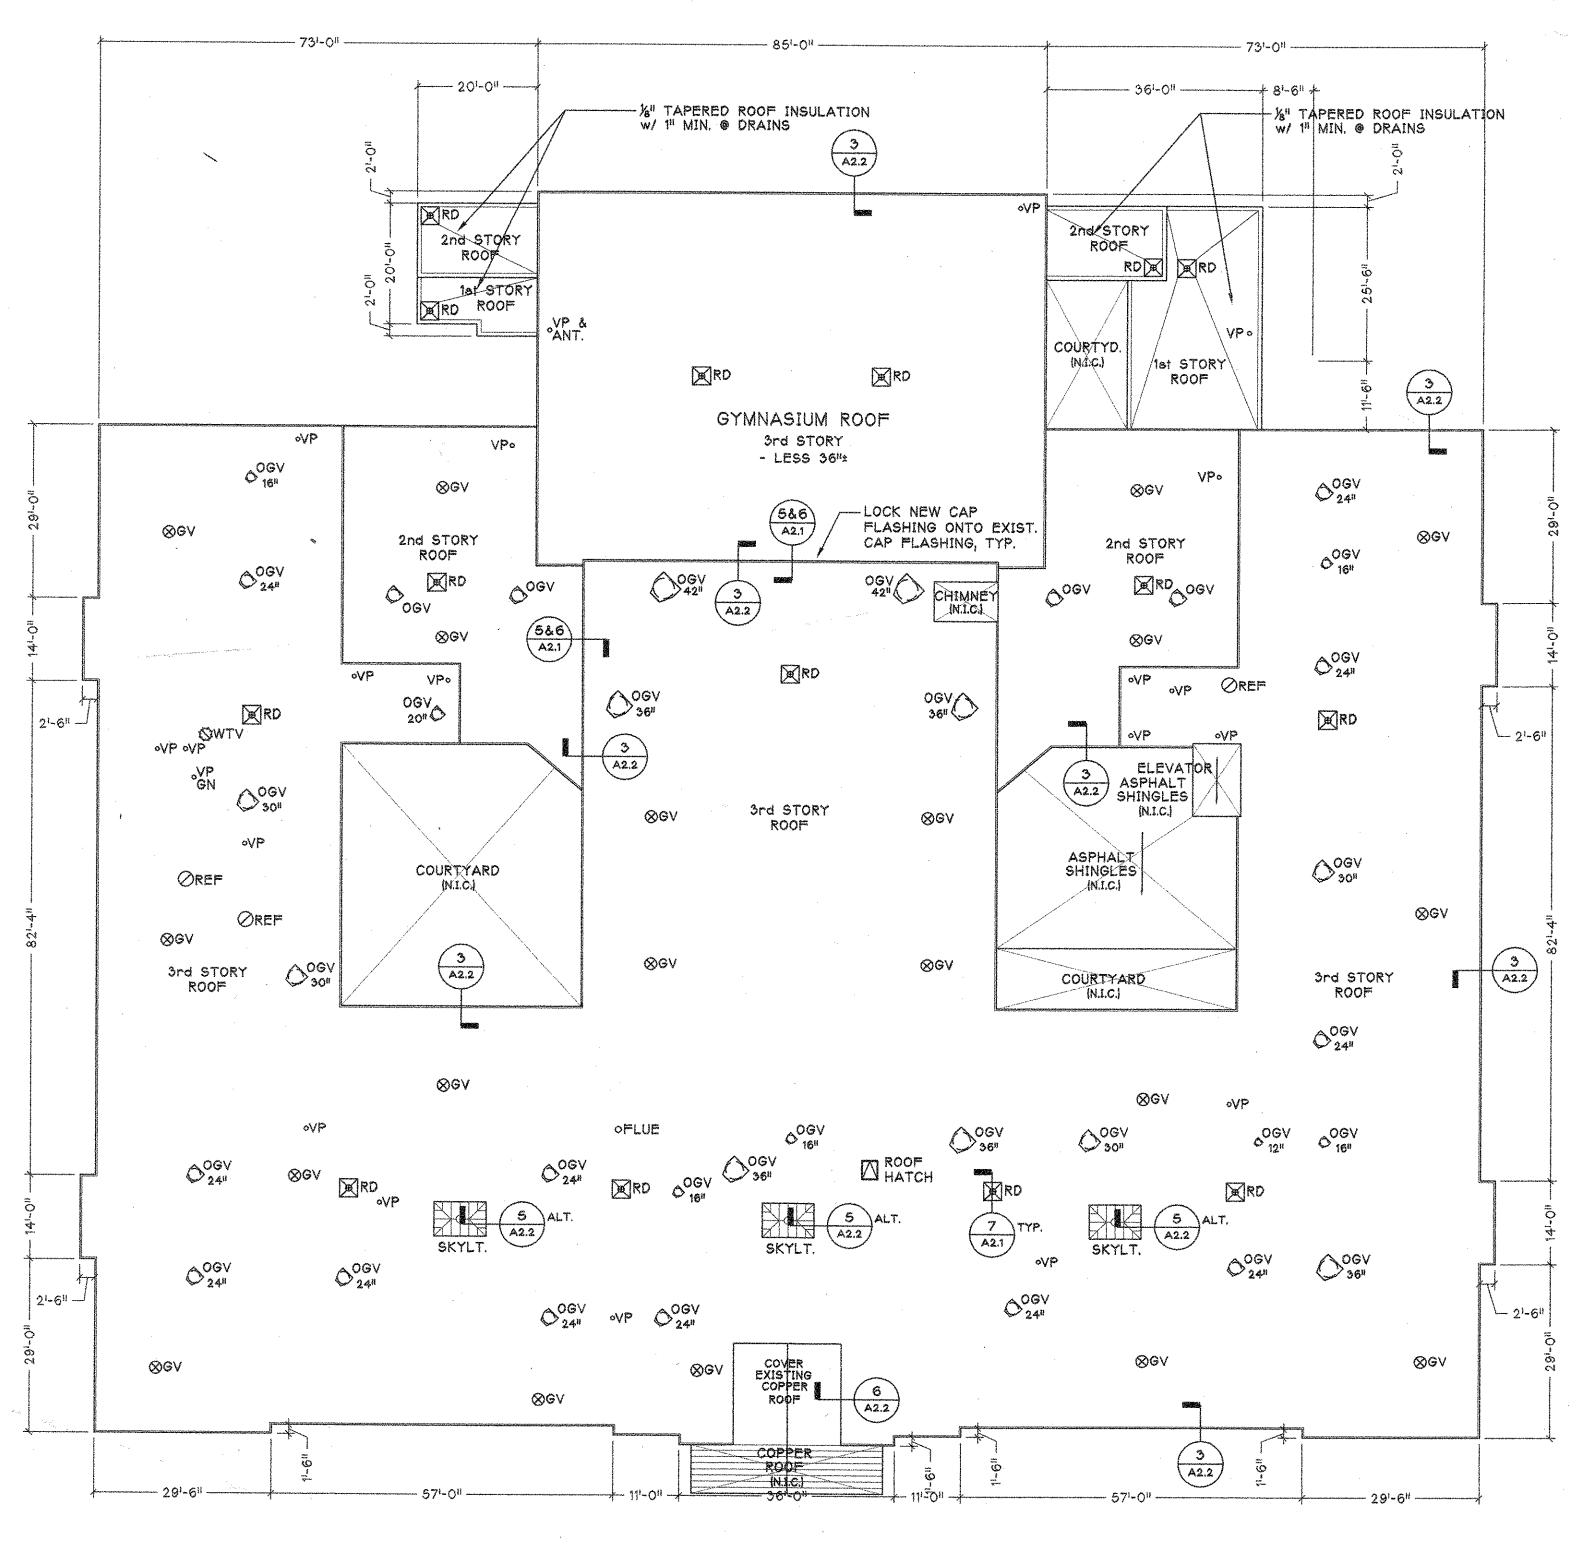
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ROOF PLAN & NOTES

SCALE: 1/16" = 1'-0" DRAWN: BASH CHKD. TDL

P.I.C. TDL DATE: JULY 19, 2000 PROJECT # 0003 SHEET NO. 3 OF 6



ABREVIATIONS:

ANT. ANTENNA

CONG. CONCRETE

GV GRAVITY VENT

OGV OSCILLATING GRAVITY VENT

N.I.C. NOT IN CONTRACT

P.T. PRESSURE TREATED

RD ROOF DRAIN

REF ROOF EXHAUST FAN

SKYLT. SKYLIGHT

VP VENT PIPE

WTV WIND TURBINE VENT

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ALDRICH MIDDLE SCHOOL 40,000+/- SQ. FT.

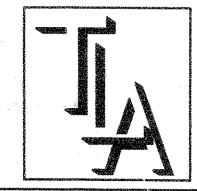
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THOMAS LONARDO & ASSOCIATES

ARCHITECTURE
INTERIOR DESIGN
MANAGEMENT

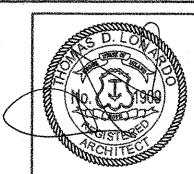
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DRAWING ROOF PLAN & NOTES

SCALE: 1/16" = 1'-0"

DRAWN: BASH

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PRC