
CITY OF WARWICK, RHODE ISLAND


SYSTEM OF SEWERS

CONTRACT NO. 102

AIRPORT INTERCEPTOR REHABILITATION

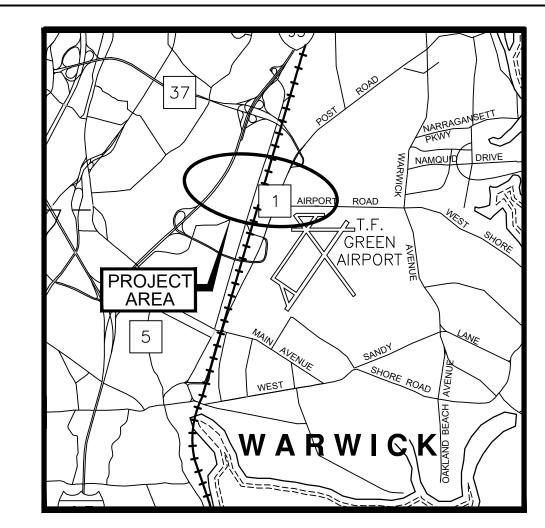

LOCATION PLAN

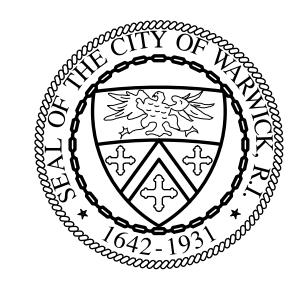

HONORABLE FRANK J. PICOZZI, MAYOR

WARWICK SEWER AUTHORITY

GARY C. JARVIS, CHAIRMAN

THOMAS H. CHADRONET CARLO E. PISATURO, JR SCOTT GOODINSON

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COVER SHEET

STREETS COVERED

NOTES AND KEY PLANS


AIRPORT INTERCEPTOR PLAN SHEETS 1 - 6

MAINTENANCE AND PROTECTION OF TRAFFIC PLANS 1 & 2

SCOTT PHILLIPS
GARY P. MARINO
PETER GINIATT

MAY 2021



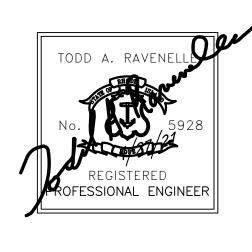

GENERAL NOTES

- 1. SPECIFICATIONS GOVERNING THIS PROJECT SHALL BE THE RIDOT "STANDARD SPECIFICATIONS FOR ROAD AND BRIDGE CONSTRUCTION" (AMENDED AUGUST 2013, INCLUDING ALL REVISIONS, ADDENDA AND SUPPLEMENTAL SPECIFICATIONS; AND THE "RHODE ISLAND STANDARD DETAILS" (1998, INCLUDING ALL REVISIONS. ALL PROJECT SITE IMPROVEMENTS SHALL CONFORM TO THE APPLICABLE STANDARDS SET FORTH IN THESE DOCUMENTS (AND THE SUB-REFERENCES INCORPORATED THEREIN) UNLESS OTHERWISE INDICATED IN THE CONTRACT DOCUMENTS.
- 2. THE PROJECT LIMITS OF CLEARING AND SURFACE DISTURBANCE SHALL BE LIMITED TO EXISTING CITY EASEMENTS AND TEMPORARY CONSTRUCTION AGREEMENT. THE CONTRACTOR WILL BE RESPONSIBLE FOR RESTORING (THROUGH PROVISION AND PLACEMENT OF LOAM AND SEED) ANY UNPAVED AREAS OUTSIDE OF THE PROJECT LIMITS OF DISTURBANCE IMPACTED BY CONSTRUCTION OPERATIONS. ANY REQUIRED RESTORATION OUTSIDE THE PROJECT LIMITS OF DISTURBANCE SHALL BE COMPLETED TO THE SATISFACTION OF THE ENGINEER AND AT THE CONTRACTOR'S EXPENSE.
- 3. ANY DAMAGE CAUSED BY THE CONTRACTOR TO EXISTING CURBING, SIDEWALKS, PAVEMENTS, FENCES, OR OTHER SITE FEATURES TO REMAIN IN PLACE SHALL BE REPAIRED OR REPLACED BY THE CONTRACTOR AT NO ADDITIONAL COST TO THE OWNER.
- 4. THE CONTRACTOR SHALL BE RESPONSIBLE FOR THE DISPOSAL OF ALL EXCESS EXCAVATED PAVEMENTS, CURBING, SIDEWALKS, CURB STOPS, AND OTHER CONSTRUCTION WASTE IN ACCORDANCE WITH ALL APPLICABLE LOCAL, STATE AND FEDERAL LAWS AND REGULATIONS.
- 5. THE CONTRACTOR SHALL MAINTAIN ALL EXCAVATION IN A DRY CONDITION. NO SEPARATE PAYMENT OR ALLOWANCE SHALL BE MADE FOR DEWATERING.
- 6. THE CONTRACTOR SHALL BE RESPONSIBLE FOR REMOVING SEDIMENTS FROM DEWATERING OPERATION DISCHARGES THROUGH THE USE OF STILLING BASINS, FILTER FABRIC DEVICES, AND/OR OTHER SUITABLE MEANS AS APPROVED BY THE ENGINEER.
- 7. THE CONTRACTOR SHALL PROVIDE CONTINUOUS DUST CONTROL (USING WATER AND/OR CALCIUM CHLORIDE OR OTHER APPROVED METHODS) FOR ALL EARTH STOCKPILES, EARTH PILED ALONG EXCAVATIONS AND SURFACES OF BACK FILLED TRENCHES, IN ACCORDANCE WITH THE RIDOT STANDARD SPECIFICATIONS AND AS DIRECTED BY THE ENGINEER.
- 8. THE CONTRACTOR SHALL PROVIDE ALL REQUIRED NOTICES AND COMPLY WITH ALL PERMITS, LAWS, ORDINANCES, RULES AND REGULATIONS BEARING ON THE CONDUCT OF THE WORK AS DRAWN AND SPECIFIED IN THE CONTRACT DOCUMENTS.
- 9. IN ACCORDANCE WITH CURRENT STATE "DIG SAFE" LAWS AND RULES, THE CONTRACTOR SHALL VERIFY THE LOCATIONS OF ALL EXISTING DRAINAGE SYSTEM ELEMENTS AND UTILITIES (BOTH UNDERGROUND AND OVERHEAD) BEFORE ANY EXCAVATION MAY COMMENCE. THE CONTRACTOR IS ADVISED THAT (A) NOT ALL UTILITY PROVIDERS SUBSCRIBE TO THE DIGSAFE PROGRAM, AND (B) IT IS THE CONTRACTOR'S RESPONSIBILITY TO NOTIFY ALL POTENTIALLY AFFECTED UTILITY COMPANIES AND ENSURE THAT ALL UTILITIES HAVE BEEN MARKED PRIOR TO THE COMMENCEMENT OF WORK. EXCAVATION SHALL BE PERFORMED IN ACCORDANCE WITH ALL APPLICABLE STATUTES, ORDINANCES, RULES AND REGULATIONS OF ANY MUNICIPAL, STATE OR FEDERAL AGENCY OR AUTHORITY HAVING JURISDICTION OVER THE WORK. ANY DAMAGE TO EXISTING UTILITIES MARKED IN THE FIELD OR UNMARKED UTILITIES (AS A RESULT OF FAILING TO CONTACT THE APPROPRIATE UTILITY COMPANY) SHALL BE REPAIRED OR REPLACED BY THE CONTRACTOR AT NO COST TO THE OWNER.
- 10. THE CONTRACTOR IS ADVISED THAT WORK UNDER EXISTING OVERHEAD UTILITIES IS REQUIRED, AND THAT MINIMUM CLEARANCES SHALL BE MAINTAINED AT ALL TIMES IN ACCORDANCE WITH UTILITY COMPANY REQUIREMENTS. THIS MAY REQUIRE SPECIAL MEANS AND METHODS IN ORDER TO PROPERLY COMPLETE THE WORK. SHOULD THE CONTRACTOR ELECT TO RELOCATE EXISTING OVERHEAD UTILITIES, THEN THE CONTRACTOR SHALL CONDUCT ALL COORDINATION WITH THE AFFECTED UTILITY COMPANIES AND BEAR ALL COSTS ASSOCIATED WITH UTILITY RELOCATIONS NOT INCLUDED IN THE CONTRACT.
- 11. PRIOR TO WORK, THE CONTRACTOR IS RESPONSIBLE FOR VERIFYING THE LOCATION (HORIZONTAL AND VERTICAL) OF ALL EXISTING PIPES AND/OR STRUCTURES WHICH ARE TO BE CONNECTED OR REMOVED. ANY VARIATION FROM THE PLANS MUST BE BROUGHT TO THE ENGINEER'S ATTENTION PRIOR TO DRAINAGE AND UTILITY CONSTRUCTION, WHEREUPON WORK CAN COMMENCE ONLY UPON THE ENGINEER'S AUTHORIZATION.
- 12. ALL EXISTING PIPE, SUBSURFACE STRUCTURES, PAVEMENTS, EXCESS EXCAVATED MATERIALS AND MISCELLANEOUS MATERIALS REMOVED IN THE COURSE OF WORK SHALL BE LEGALLY DISPOSED OF BY THE CONTRACTOR AT AN OFFSITE LOCATION.
- 13. SEWER SERVICES TO EXISTING BUILDINGS AND FACILITIES SHALL BE MAINTAINED TO THE MAXIMUM EXTENT POSSIBLE. SERVICE SHALL NOT BE SHUT-DOWN WITHOUT NOTIFICATION AND APPROVAL OF THE WARWICK SEWER AUTHORITY.
- 14. THE CONTRACTOR SHALL CALL DIGSAFE AT 811 AT LEAST 72 HOURS, SATURDAYS, SUNDAYS, AND HOLIDAYS EXCLUDED, PRIOR TO EXCAVATING AT ANY LOCATION. A COPY OF THE DIGSAFE PROJECT REFERENCE NUMBER(S) SHALL BE GIVEN TO THE OWNER BY THE CONTRACTOR PRIOR TO EXCAVATION.
- 15. ALL AREAS DISTURBED BY THE CONTRACTOR SHALL BE RESTORED.
- 16. THE CONTRACTOR SHALL MAINTAIN SIDE SLOPES AND DRAINAGE SWALES DURING CONSTRUCTION TO PREVENT PONDING AND EROSION.
- 17. THE CONTRACTOR SHALL NOT STORE ANY APPARATUS, MATERIALS, SUPPLIES, AND EQUIPMENT ON DRAINAGE STRUCTURES OR WITHIN 100 FEET OF WETLANDS.
- 18. THE CONTRACTOR SHALL GRADE TO MEET EXISTING CONDITIONS.
- 19. THE CONTRACTOR SHALL NOT TRACK OR SPILL EARTH, DEBRIS, OR OTHER CONSTRUCTION MATERIAL ON PUBLIC OR PRIVATE STREETS. THE CONTRACTOR SHALL BE RESPONSIBLE FOR THE IMMEDIATE ASSOCIATED CLEAN UP.
- 20. ALL CATCH BASINS, MANHOLES, VALVE PITS, VALVE BOXES AND OTHER BURIED FACILITIES WITH SURFACE ACCESS SHALL BE ADJUSTED TO MATCH FINAL GRADES, UNLESS OTHERWISE INDICATED.
- 21. THE CONTRACTOR SHALL REMOVE AND DISPOSE OF ALL DEBRIS AND EXCESS EXCAVATED MATERIAL FROM WITHIN THE CONSTRUCTION LIMIT OF WORK TO A SUITABLE SITE PROVIDED BY THE CONTRACTOR IN COMPLIANCE WITH ALL STATE AND LOCAL REGULATIONS.
- 22. WHERE EXISTING MATERIAL IS REMOVED AND REPLACED, MATCH EXISTING GRADES TO THE EXTENT POSSIBLE. COORDINATED FINE GRADING WITH THE ENGINEER.
- 23. REFER TO SPEC, DIVISION 15 FOR PIPE INFORMATION.
- 24. ALL PIPE LINES SHALL SLOPE UNIFORMLY BETWEEN ELEVATIONS INDICATED ON THE DRAWINGS. NO CRESTS OR SAGS IN PIPING WILL BE PERMITTED. OPENINGS FOR PIPE IN PRECAST STRUCTURES SHALL BE CAST IN THE REQUIRED LOCATIONS DURING MANHOLE MANUFACTURE. FIELD CUT OPENINGS WILL NOT BE PERMITTED UNLESS APPROVED BY THE ENGINEER.
- 25. ANY SETTLEMENT OCCURRING WITHIN ONE YEAR OF FINAL COMPLETION OF THE WORK SHALL BE CORRECTED BY THE CONTRACTOR AT NO ADDITIONAL COST.
- 26. THE CONTRACTOR SHALL COMPLY WITH ALL APPLICABLE REGULATIONS OF THE OCCUPATIONAL SAFETY AND HEALTH ADMINISTRATION (OSHA), AND ALL OTHER OVERSIGHT AGENCIES.
- 27. ALL STRUCTURES AND PIPELINES LOCATED ADJACENT TO ANY TRENCH EXCAVATION SHALL BE PROTECTED AND FIRMLY SUPPORTED BY THE CONTRACTOR UNTIL THE TRENCH IS BACKFILLED. DAMAGE TO ANY SUCH STRUCTURES CAUSED BY OR RESULTING FROM THE CONTRACTOR'S OPERATIONS SHALL BE REPAIRED AT THE CONTRACTORS EXPENSE. ALL UTILITIES REQUIRING REPAIR, RELOCATION OR ADJUSTMENT AS A RESULT OF THE PROJECT SHALL BE COORDINATED THROUGH THE OWNER.
- 28. UNLESS OTHERWISE NOTED ON THE DRAWINGS, ALL EXISTING UTILITIES ENCOUNTERED

- DURING CONSTRUCTION SHALL BE EITHER: NOT DISTURBED, PROTECTED IN PLACE OR RELOCATED.
- 29. ALL EXISTING UTILITIES REPLACED OR RELOCATED SHALL BE CONSTRUCTED OF NEW MATERIALS APPROVED BY THE ENGINEER AND SIMILAR TO THOSE OF THE EXISTING UTILITY.
- 30. THE CONTRACTOR SHALL BE RESPONSIBLE FOR THE LAYOUT OF ALL PROPOSED WORK AS SHOWN ON THE DRAWINGS. THE CONTRACTOR SHALL REPORT ANY LAYOUT DISCREPANCIES IMMEDIATELY TO THE ENGINEER.
- 31. THE LOCATION AND LIMITS OF ALL ON-SITE WORK AND STORAGE AREAS SHALL BE REVIEW /COORDINATED WITH, AND ACCEPTABLE TO, THE OWNER AND ENGINEER.
- 32. WRITTEN DIMENSIONS SHALL PREVAIL OVER SCALE DISTANCES FROM THE DRAWINGS, REPORT ANY DISCREPANCIES IMMEDIATELY TO THE ENGINEER.

EROSION AND SEDIMENT CONTROL NOTES

- 1. THE CONTRACTOR SHALL SUBMIT A SOIL EROSION AND SEDIMENTATION CONTROL PLAN FOR APPROVAL BY THE OWNER TO BE EMPLOYED ON THE PROJECT. CONTROL MEASURES SHALL BE FURNISHED, INSTALLED, MAINTAINED FOR THE DURATION OF CONSTRUCTION, AND SUBSEQUENTLY REMOVED, ALL IN ACCORDANCE WITH THE RIDOT STANDARD SPECIFICATIONS, THE LATEST EDITION OF THE "RHODE ISLAND SOIL EROSION AND SEDIMENT CONTROL HANDBOOK" (REVISED 2014), AND ANY SITE-SPECIFIC EROSION AND SEDIMENT CONTROL / POLLUTION PREVENTION PLAN INCLUDED IN THE CONTRACT DOCUMENTS.
- 2. ALL CLEARING, GRADING AND EARTHWORK ACTIVITIES SHALL BE MINIMIZED.
- 3. ALL EROSION AND SEDIMENTATION CONTROL MEASURES SHALL BE ROUTINELY INSPECTED AND MAINTAINED IN ACCORDANCE WITH THE RIDOT STANDARD SPECIFICATIONS, THE RHODE ISLAND SOIL EROSION AND SEDIMENT CONTROL HANDBOOK, AND THE APPLICABLE CONDITIONS OF ANY REGULATORY/ENVIRONMENTAL PERMITS ISSUED FOR THE PROJECT.
- 4. PRIOR TO THE COMMENCEMENT OF ANY CONSTRUCTION ACTIVITIES, EROSION AND SEDIMENTATION CONTROLS SHALL BE INSTALLED. CLEARING MAY OCCUR PRIOR TO INSTALLATION OF SUCH CONTROLS; HOWEVER NO GRUBBING, GRADING, FILLING, OR OTHER SOIL DISTURBANCE SHALL OCCUR PRIOR TO INSTALLATION.
- 5. PERIMETER EROSION CONTROL BARRIERS (STAKED COMPOST FILTER SOCK, SILT FENCE, OR OTHER DEVICES AS INDICATED) SHALL BE INSTALLED IN CONTINUOUS UNINTERRUPTED RUNS AND MAINTAINED IN EFFECTIVE CONDITION UNTIL ALL DISTURBED AREAS HAVE BEEN STABILIZED WITH VEGETATION. FOLLOWING SUCCESSFUL STABILIZATION OF DISTURBED AREAS, ALL PERIMETER EROSION CONTROL BARRIERS SHALL BE REMOVED. PRIOR TO REMOVAL OF THE DEVICES, ALL ACCUMULATED SEDIMENT AND DEBRIS TRAPPED BY THE BARRIERS SHALL BE REMOVED AND DISPOSED OF LEGALLY AT A SUITABLE OFFSITE LOCATION.
- 6. UNTIL VEGETATIVE COVER IS ESTABLISHED AND DISTURBED AREAS ARE FULLY STABILIZED, TRAPPED SEDIMENTS SHALL BE PERIODICALLY REMOVED FROM PERIMETER EROSION CONTROL BARRIERS. AT A MINIMUM, MATERIAL SHALL BE REMOVED ONCE THE DEPTH OF ACCUMULATED SEDIMENT REACHES SIX (6) INCHES OR ONE-HALF THE BARRIER HEIGHT, WHICHEVER IS LESS. ALL REMOVED MATERIAL SHALL BE DISPOSED OF LEGALLY AT A SUITABLE OFFSITE LOCATION.
- 7. ALL MATERIAL STOCKPILES SHALL BE SURROUNDED BY A SECURED PERIMETER OF COMPOST FILTER SOCK
- 8. ALL EXISTING AND CONSTRUCTED DRAINAGE SYSTEM INLETS SHALL BE PROVIDED WITH INLET PROTECTION DEVICES (FILTER BAGS/SILT SACKS, SANDBAGS, WATTLES, ETC.). ALL INLET PROTECTION DEVICES SHALL BE INSTALLED, MAINTAINED, AND CLEANED FOR THE DURATION OF CONSTRUCTION AND UNTIL ALL STORMWATER CONTROLS ARE FULLY STABILIZED AND ONLINE, AT WHICH TIME THEY SHALL BE REMOVED.
- 9. DURING CONSTRUCTION, THE CONTRACTOR SHALL BE RESPONSIBLE FOR MAINTAINING DRAINAGE AND RUNOFF FLOW DURING STORMS AND PERIODS OF RAINFALL.
- 10. EROSION CONTROL DEVICES SHOULD BE INSPECTED WEEKLY AND AFTER RAINFALL EVENTS EXCEEDING ONE HALF INCH (½") IN ANY 24-HOUR PERIOD. MAINTENANCE AND REPAIRS SHALL BE COMPLETED WITH 24 HOURS OF THE INSPECTION.
- 11. TEMPORARY SURFACE STABILIZATION TREATMENTS SHALL CONSIST OF A HAY, STRAW, OR FIBER MULCH OR PROTECTIVE COVERS SUCH AS FIBER MESH, EROSION CONTROL BLANKETS, OR OTHER MATTING. THEY SHALL BE INCORPORATED INTO THE WORK AS WARRANTED OR AS DIRECTED BY THE ENGINEER. HAY OR STRAW APPLICATIONS SHOULD BE IN THE AMOUNT OF 3,000-4,000 POUNDS PER ACRE (1.9-2.5 POUNDS PER SQUARE YARD). IF NEEDED, TEMPORARY SEEDING (PROVIDED IN ACCORDANCE WITH APPLICABLE SECTIONS OF THE STANDARD SPECIFICATIONS AND EROSION AND SEDIMENT CONTROL GUIDANCE) MAY BE EMPLOYED TO FURTHER MINIMIZE EROSION.
- 12. TOPSOIL SHALL HAVE A SANDY LOAM TEXTURE, FREE OF SUBSOIL, STONES, ROCKS, ROOTS, BRUSH, REFUSE, CONSTRUCTION DEBRIS AND OTHER DELETERIOUS MATERIALS AND SHALL CONFORM TO SUBSECTION M.18.01 OF THE RIDOT STANDARD SPECIFICATIONS.
- 13. THE SEEDED MIX SHALL BE INOCULATED WITHIN 24 HOURS, BEFORE MIXING AND PLANTING, WITH APPROPRIATE INOCULUM FOR EACH VARIETY.
- 14. THE DESIGN MIX SHALL BE COMPRISED OF THE FOLLOWING AND BE APPLIED AT A SEEDING RATE OF 100 POUNDS PER ACRE:

COMPONENT	% BY WEIGHT
RED FESCUE	70
KENTUCKY BLUEGRASS	15
COLONIAL BENTGRASS	5
PERENNIAL RYEGRASS	10

- 15. THE NORMAL ACCEPTABLE SEASONAL SEEDING DATES ARE APRIL 1 JUNE 1 AND AUGUST 15 -
- 16. STABILIZATION OF ONE FORM OR ANOTHER AS DESCRIBED ABOVE SHALL BE ACHIEVED WITHIN 14 DAYS OF FINAL RESTORATION. PLANTING OF GRASS SHALL BE ACCOMPLISHED BY THE CONTRACTOR AS EARLY AS POSSIBLE UPON COMPLETION OF GRADING AND CONSTRUCTION.
- 17. THE CONTRACTOR MUST REPAIR AND OR RESEED ANY AREAS THAT DO NOT DEVELOP WITHIN THE PERIOD OF ONE (1) CALENDAR YEAR AND SHALL DO SO AT NO ADDITIONAL EXPENSE TO THE OWNER.


BYPASS PUMPING NOTES

- 1. THE PLANS PROVIDE SUGGESTED PIPE ROUTES TO FACILITATE BYPASS PUMPING. THE CONTRACTOR MAY MODIFY THE ROUTES TO FACILITATE THEIR MEANS AND METHODS, AND SEQUENCE OF CONSTRUCTION.
- 2. CONTRACTOR SHALL PREPARE PUMP AND BYPASS PLAN AND SCHEDULE IN ACCORDANCE WITH THE CONTRACT DOCUMENTS.
- 3. THE FLOW RATES INDICATED ON THE PLANS ARE APPROXIMATE AND MAY VARY DEPENDENT ON RAINFALL EVENTS, SEASONAL VARIATIONS, AND TIME OF DAY.




KEY PLAN AIRPORT INTERCEPTOR
SCALE: 1" = 500'


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				SCALE AS NOTED	AIRPORT INTERCEPTOR REHABILITATION
REV.NO.	DESCRIPTION	DATE	INT.		NOTES AND KEY PLANS
	WARWICK SEWER A	UTHORITY		DWG. NO. 2 OF 13 FILE NO. 1960	GORDON R. ARCHIBALD, CIVIL AND ENVIRONMENTAL ENGINEERS 200 MAIN STREET, PAWTUCKET, RHODE ISLAND

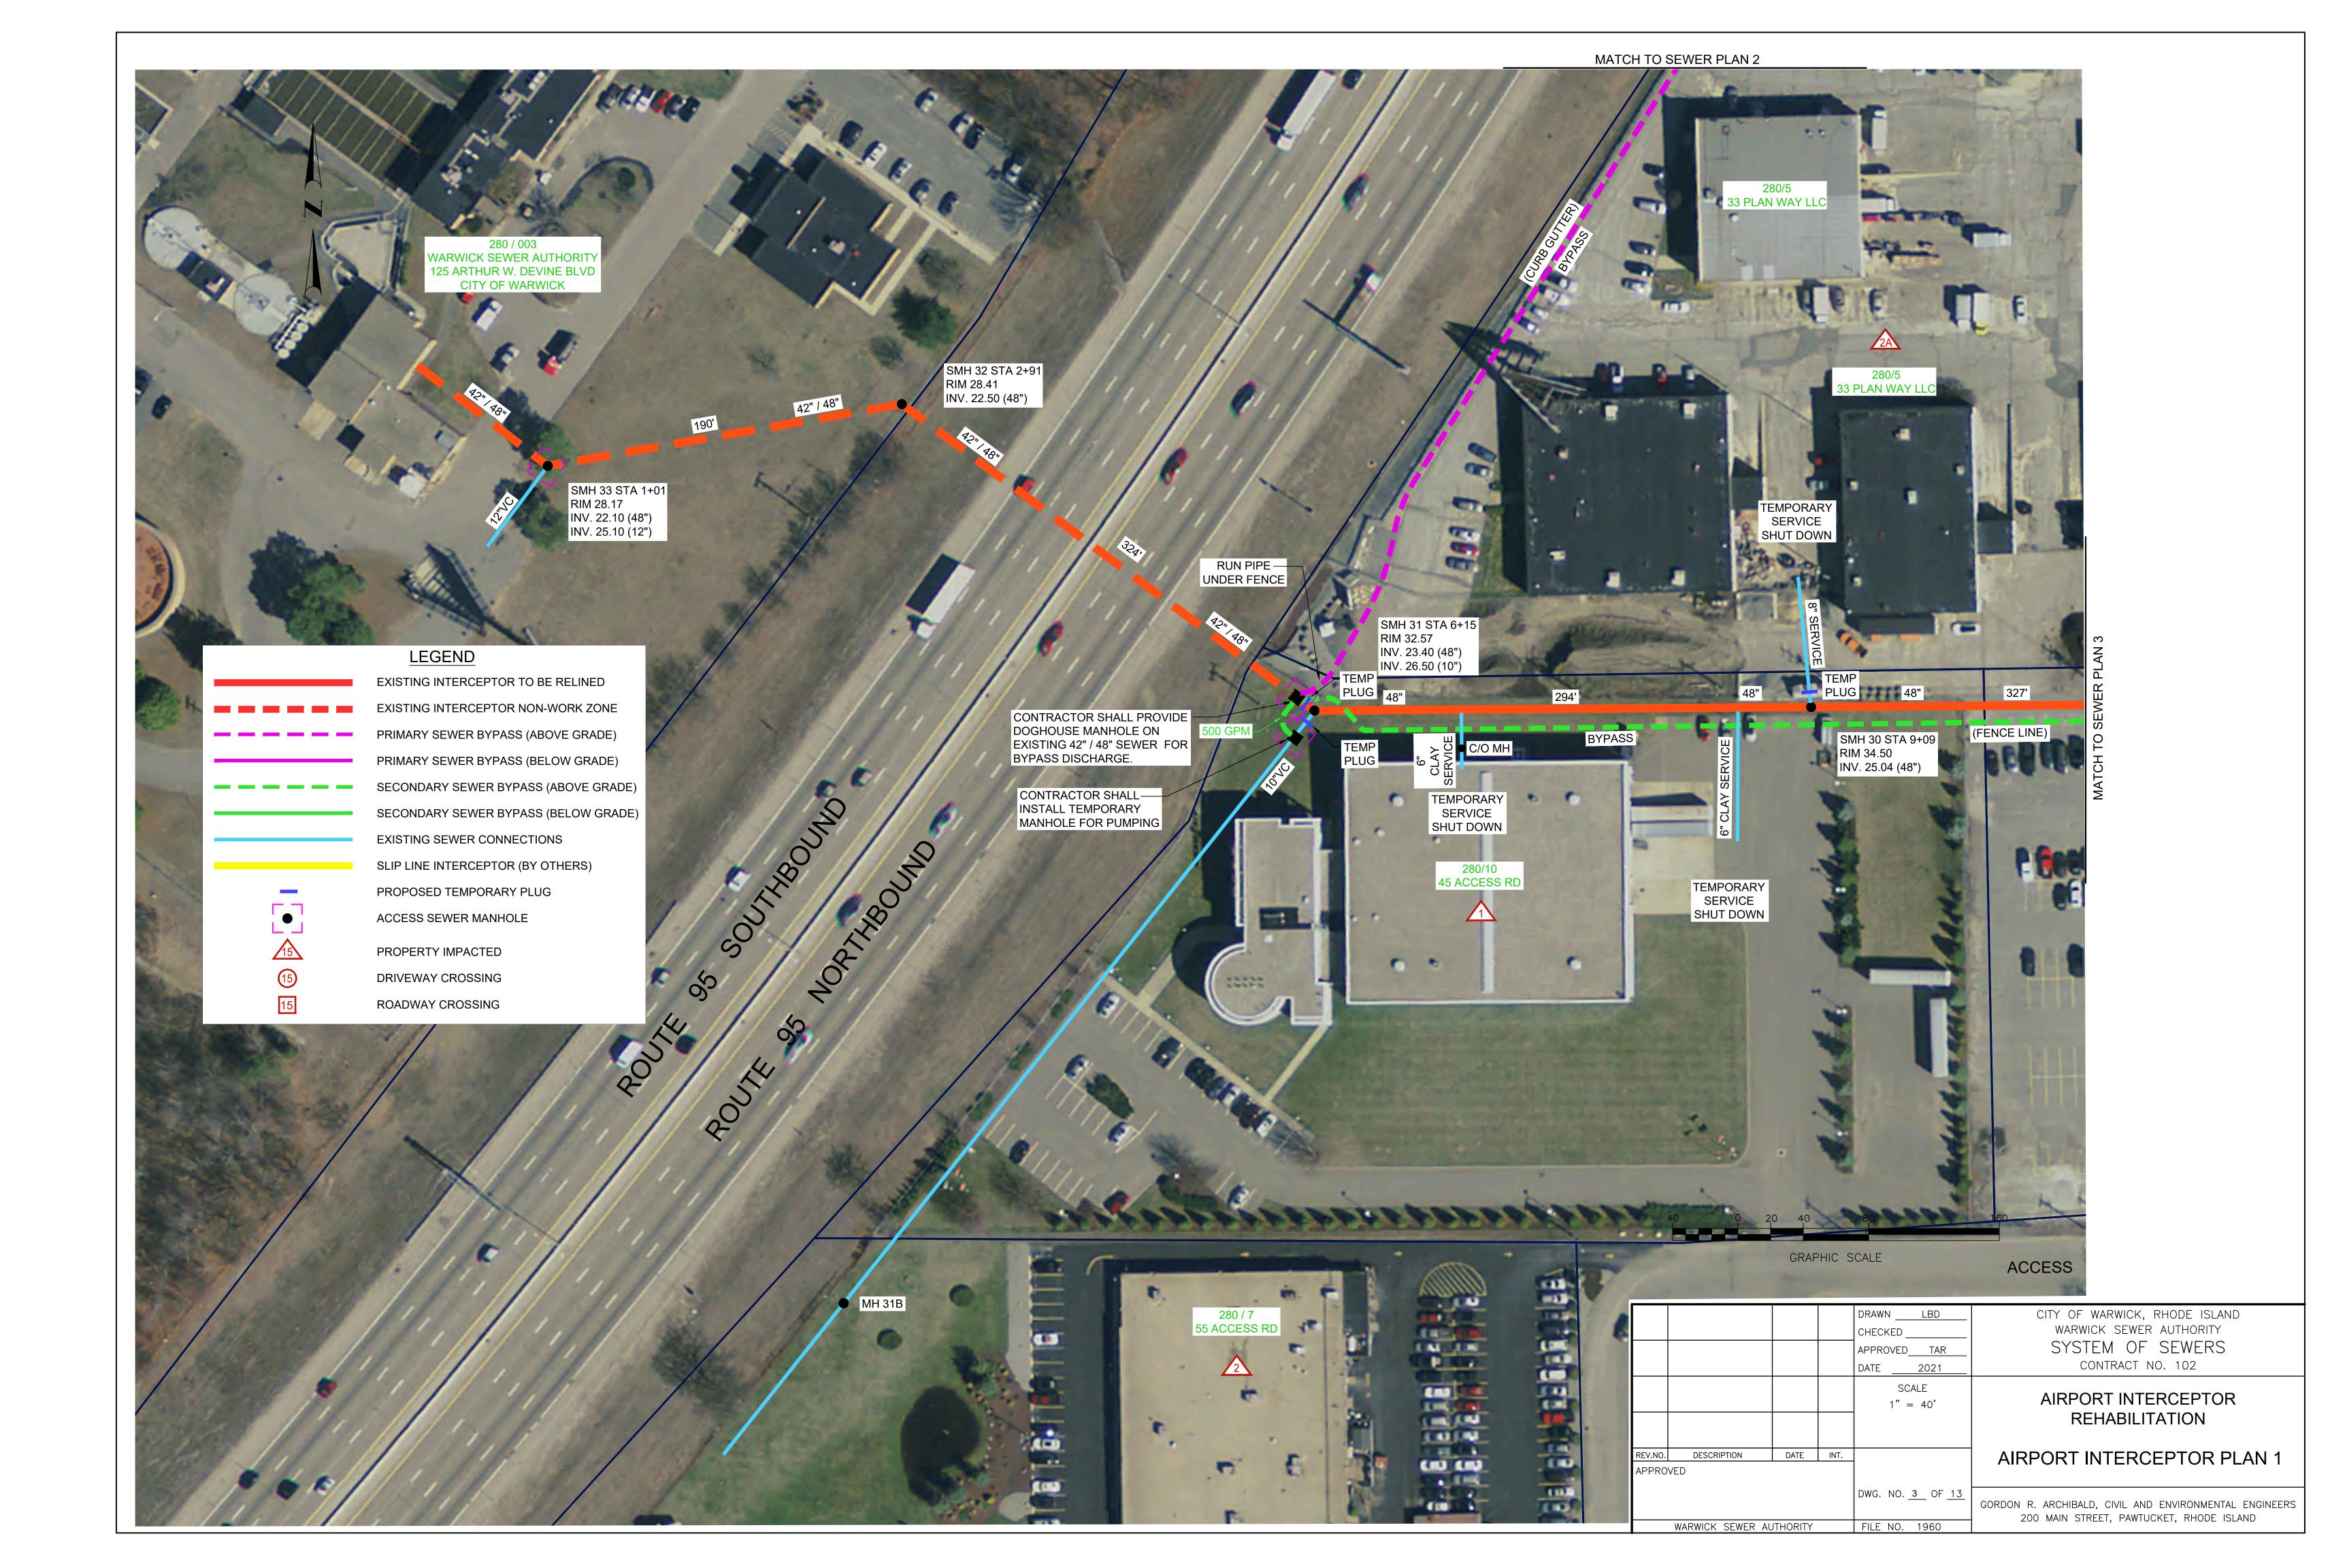





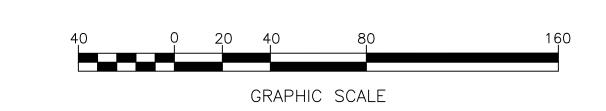



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				SCALE 1" = 40'	AIRPORT INTERCEPTOR REHABILITATION
EV.NO. PPRO	DESCRIPTION VED	DATE	INT.		AIRPORT INTERCEPTOR PLAN 2
	WARWICK SEWER A	UTHORITY		DWG. NO. 4 OF 13 FILE NO. 1960	GORDON R. ARCHIBALD, CIVIL AND ENVIRONMENTAL ENGINEERS 200 MAIN STREET, PAWTUCKET, RHODE ISLAND

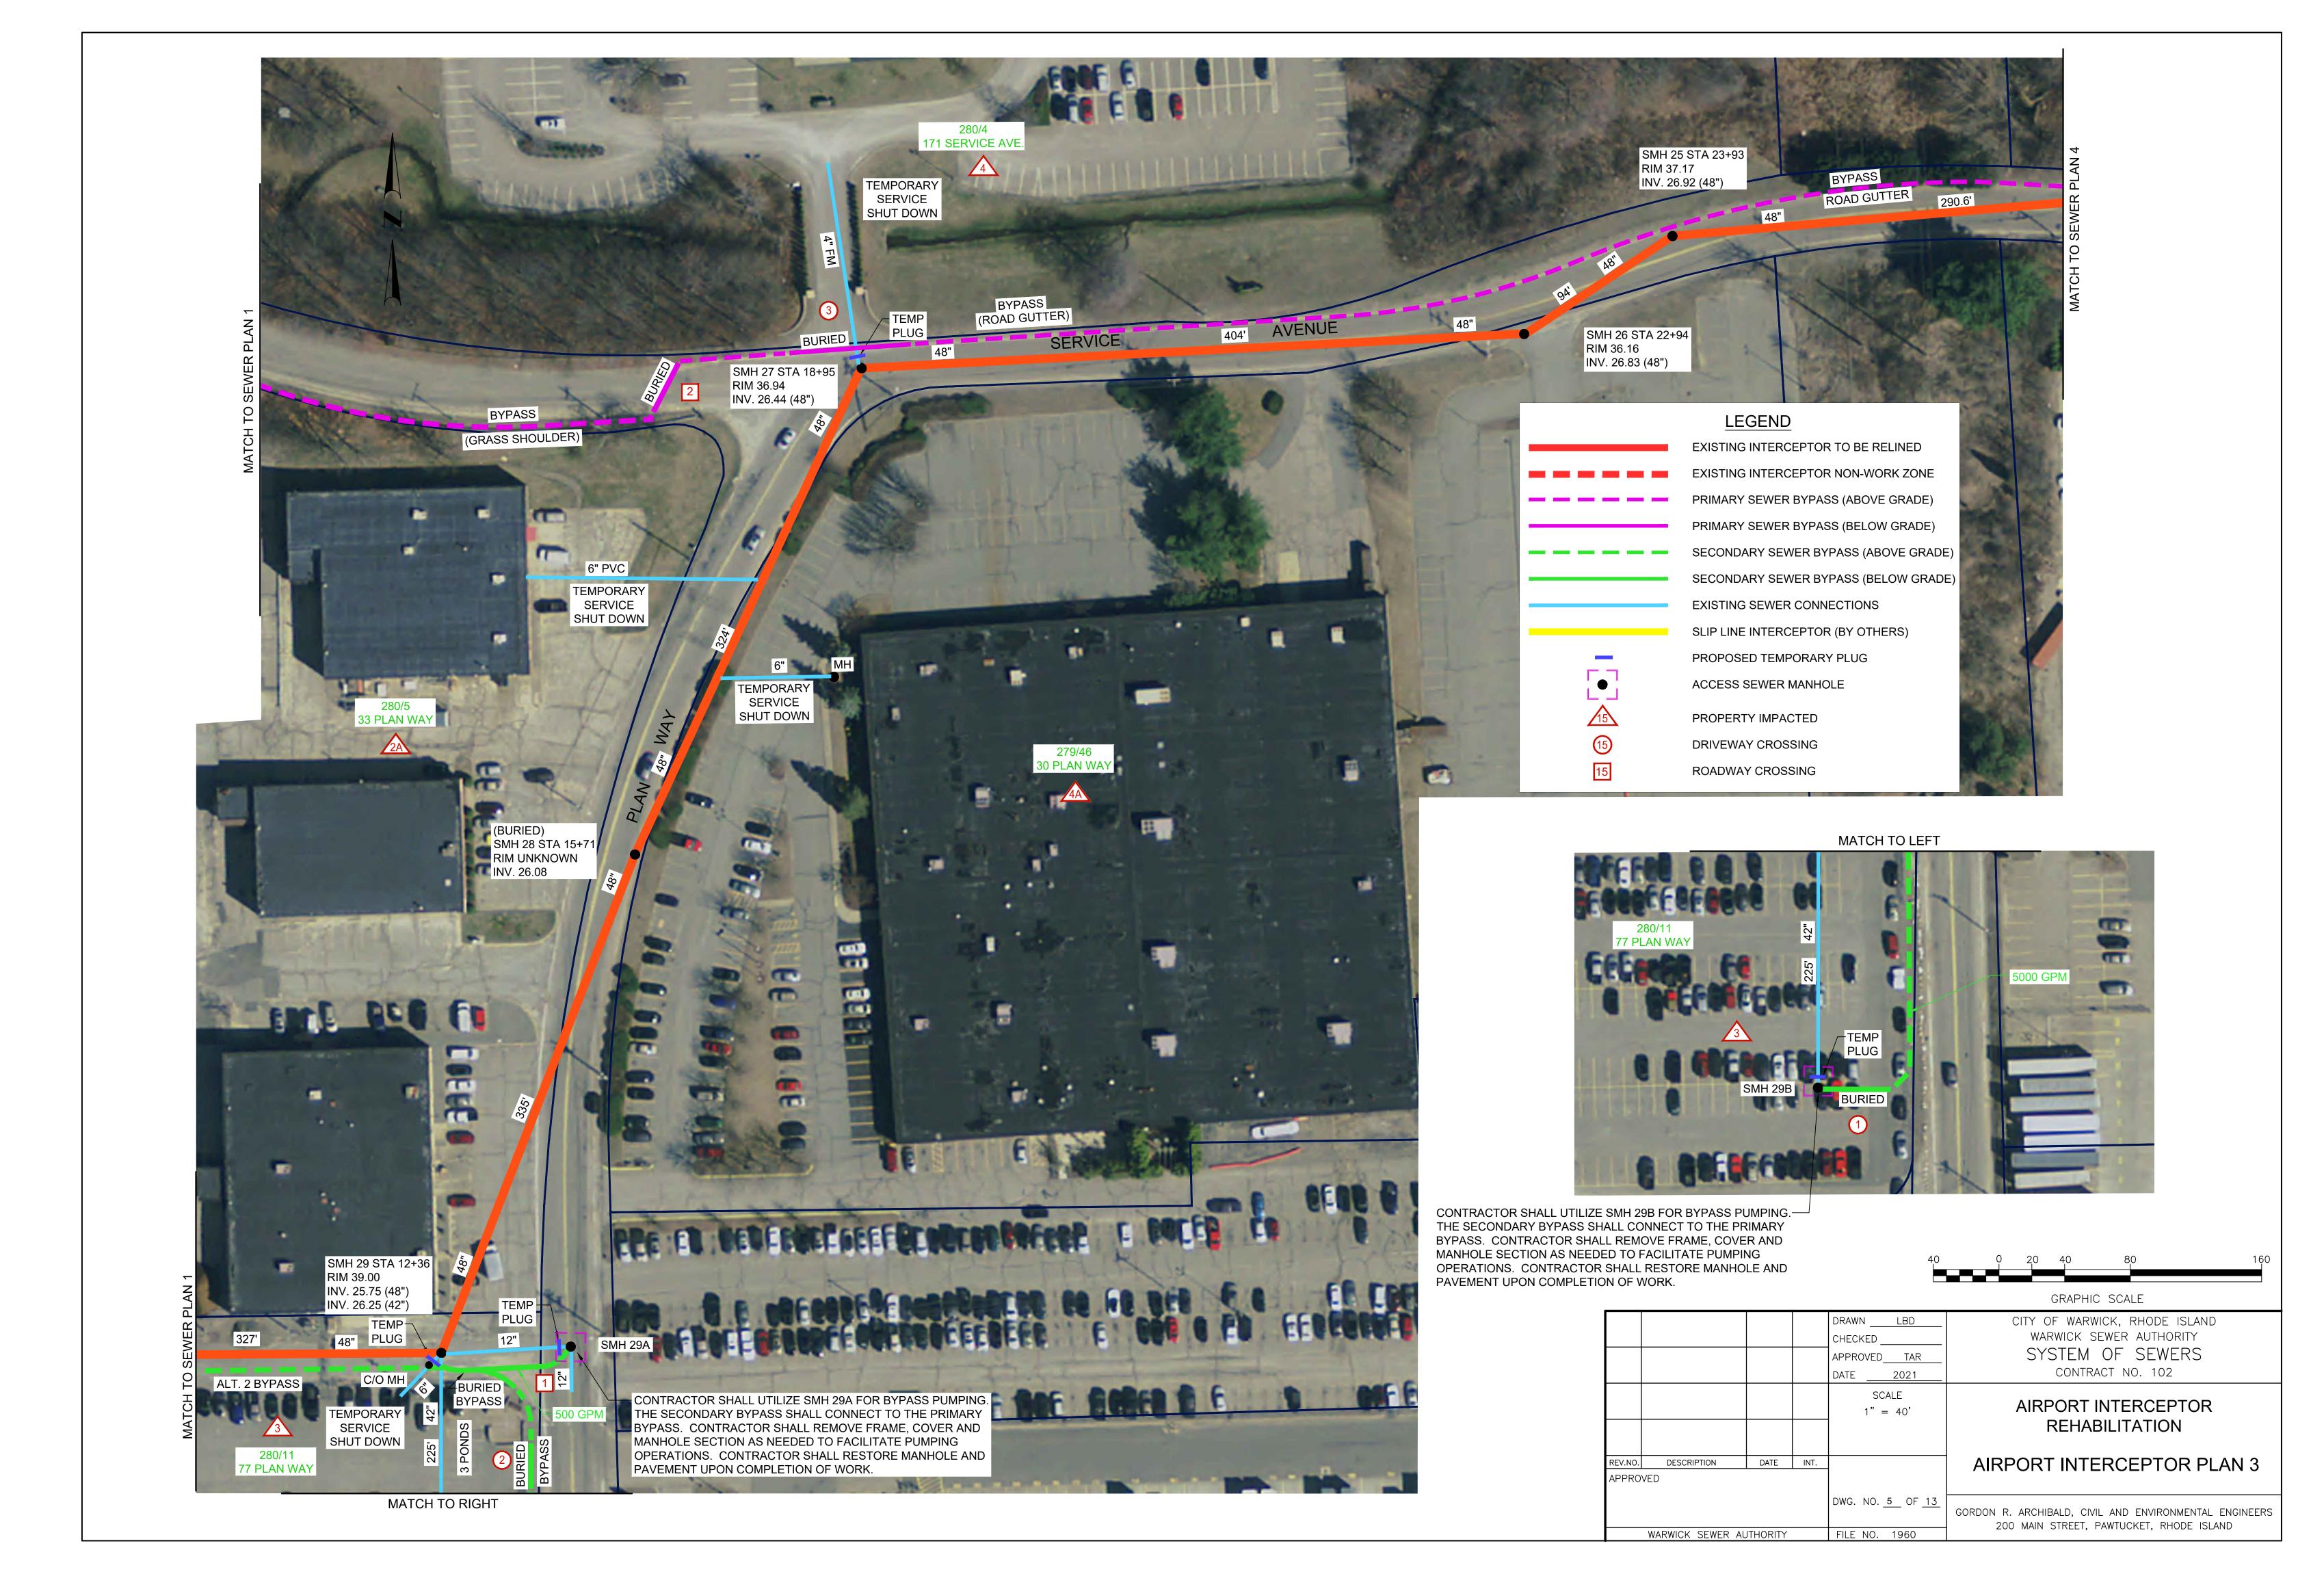

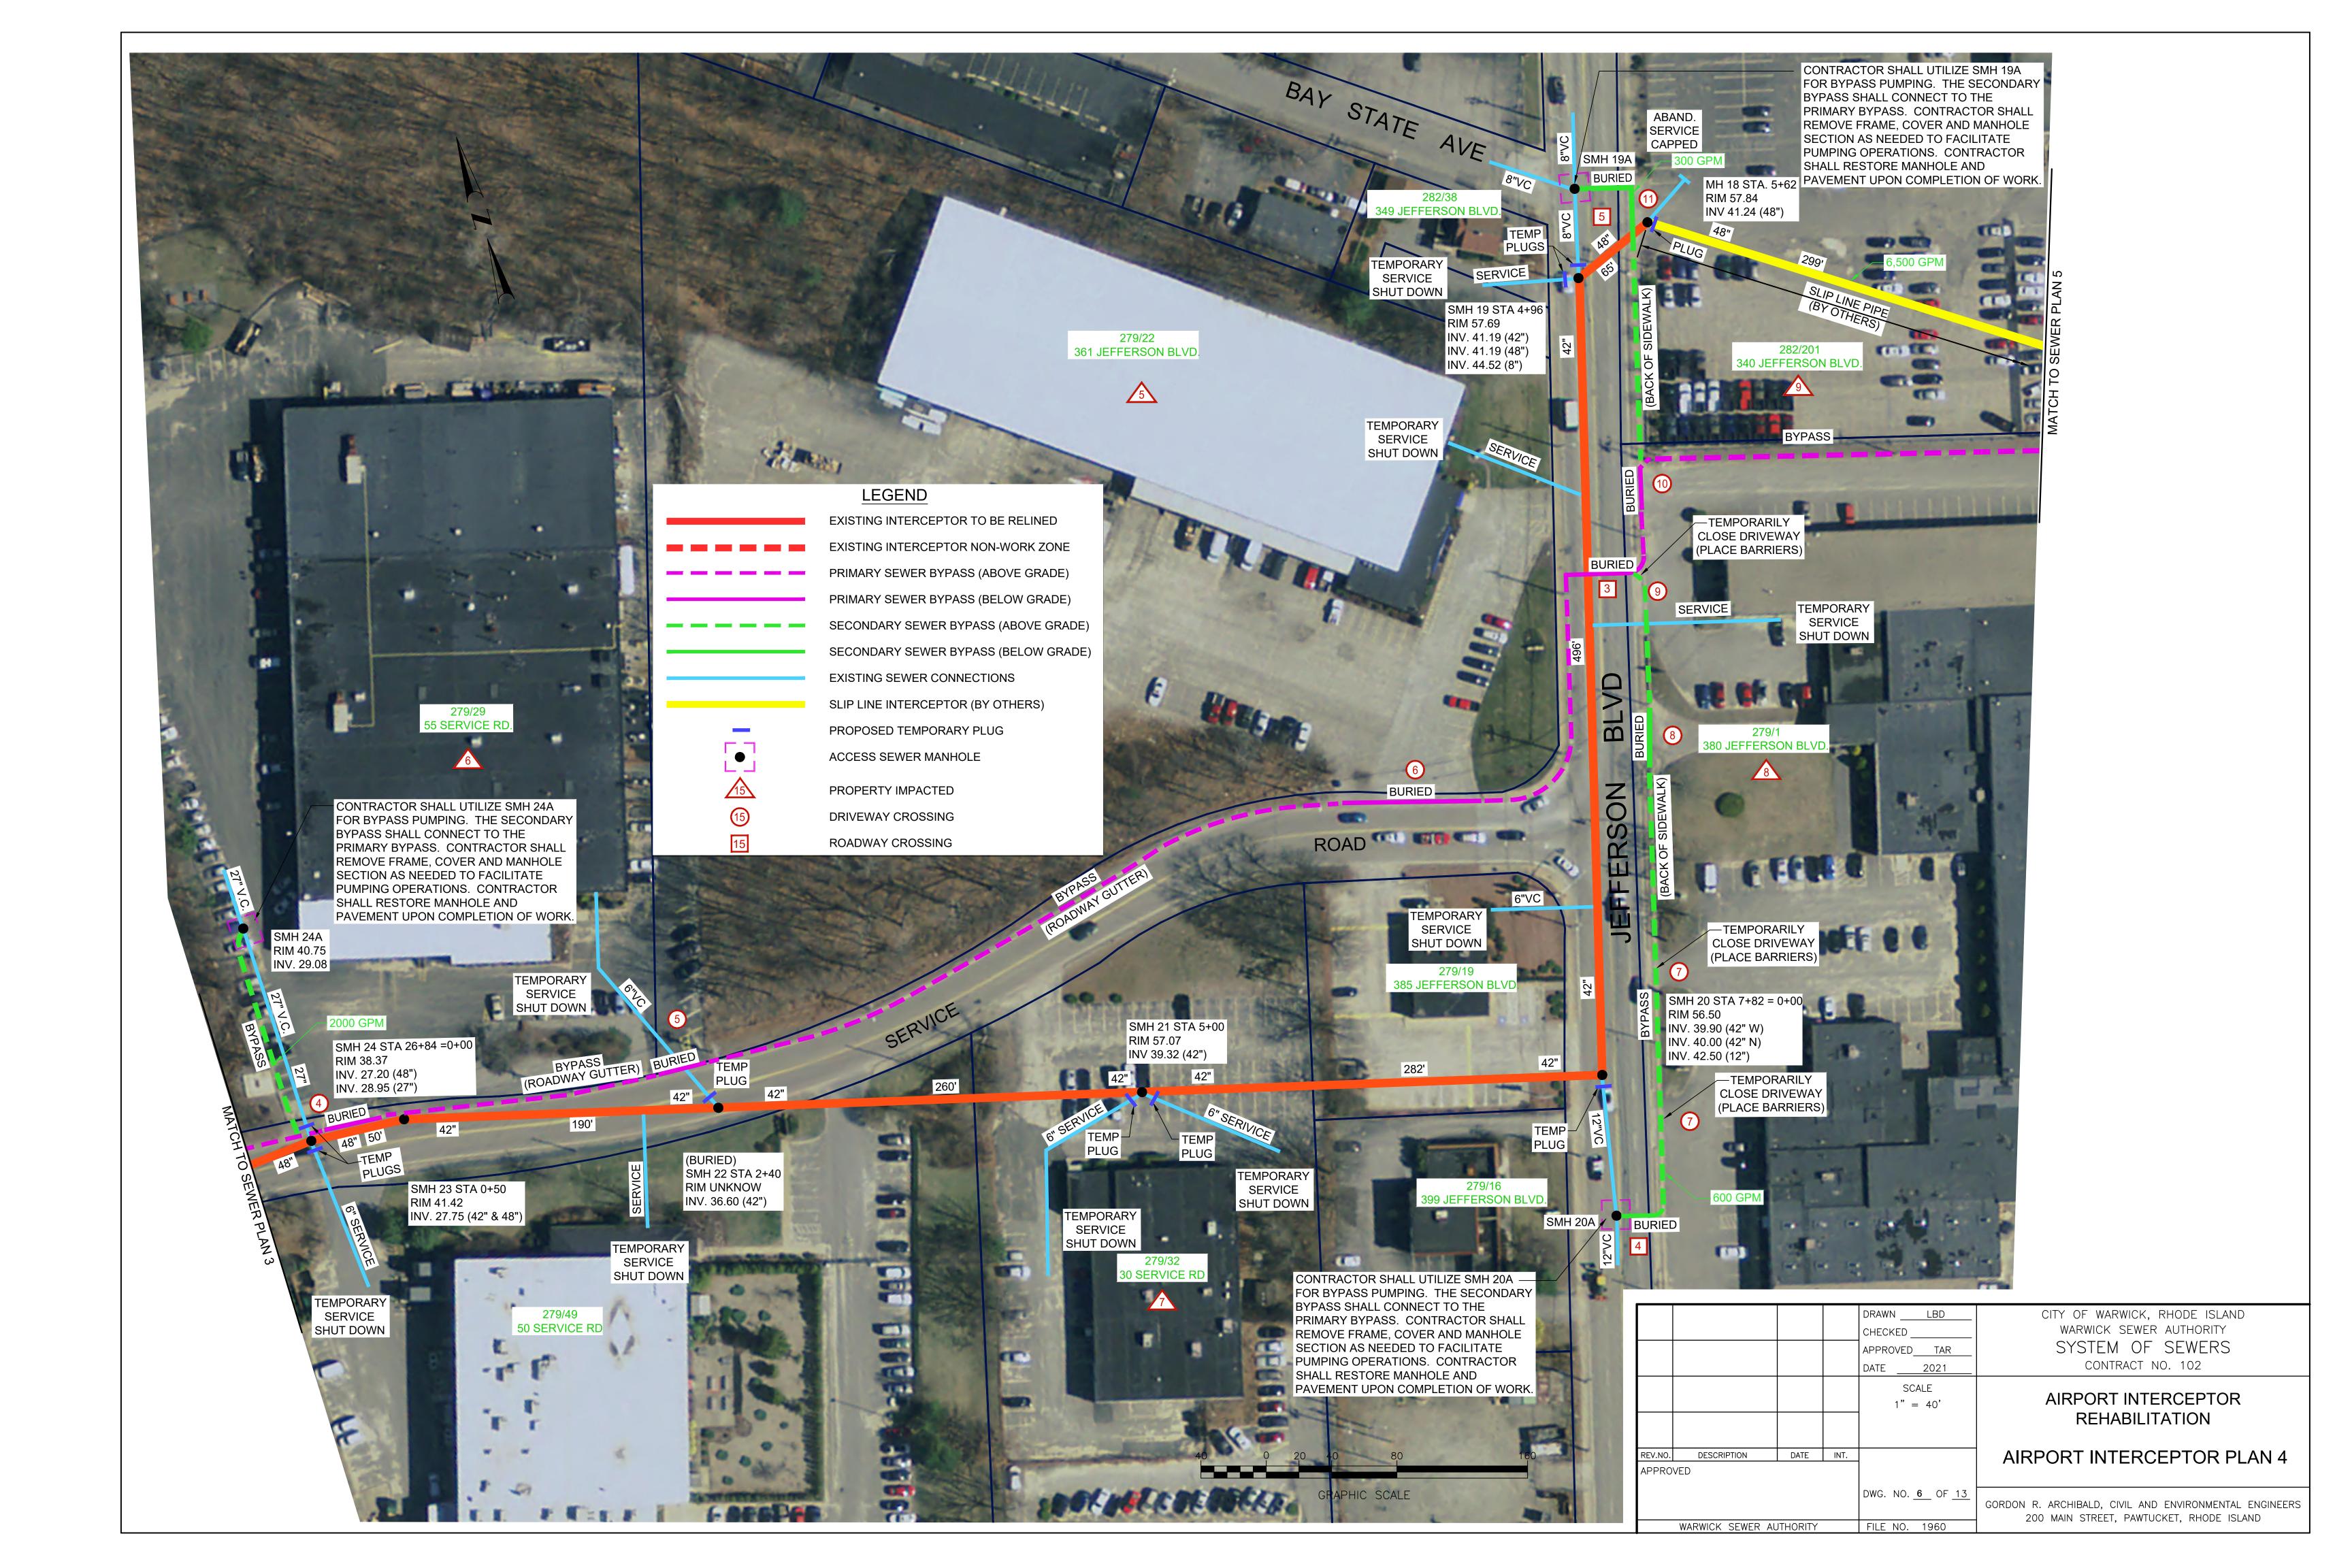

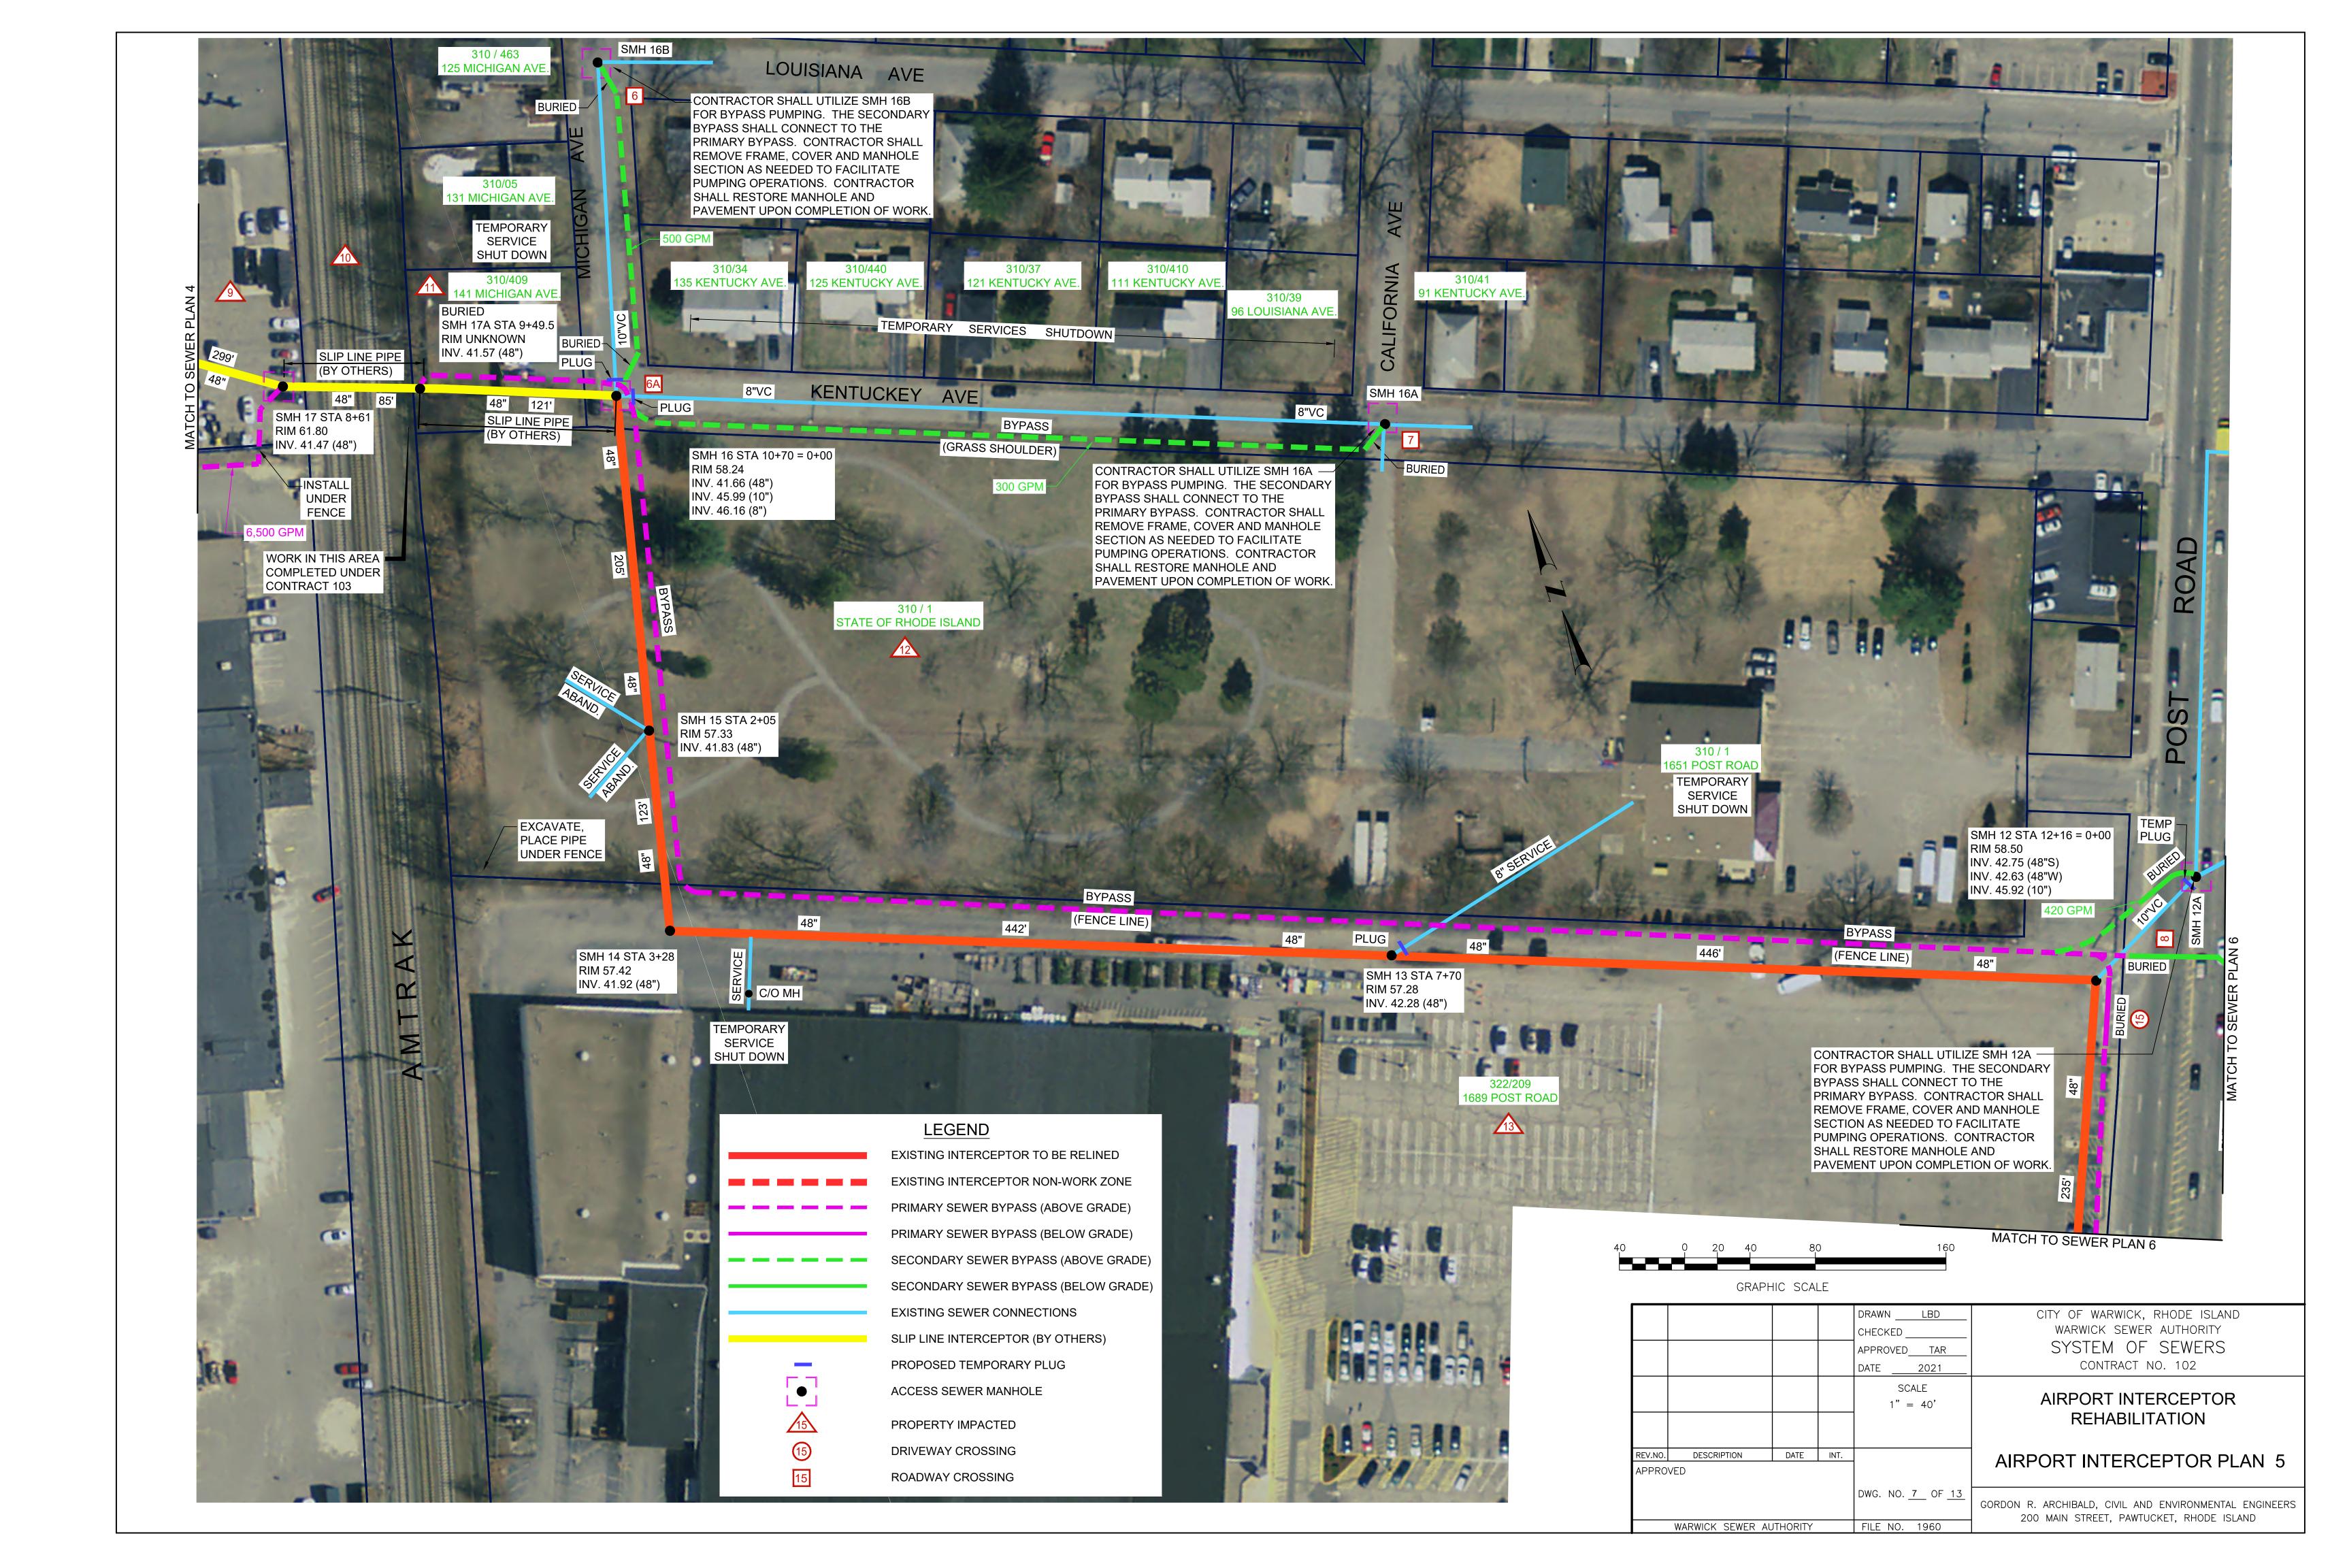

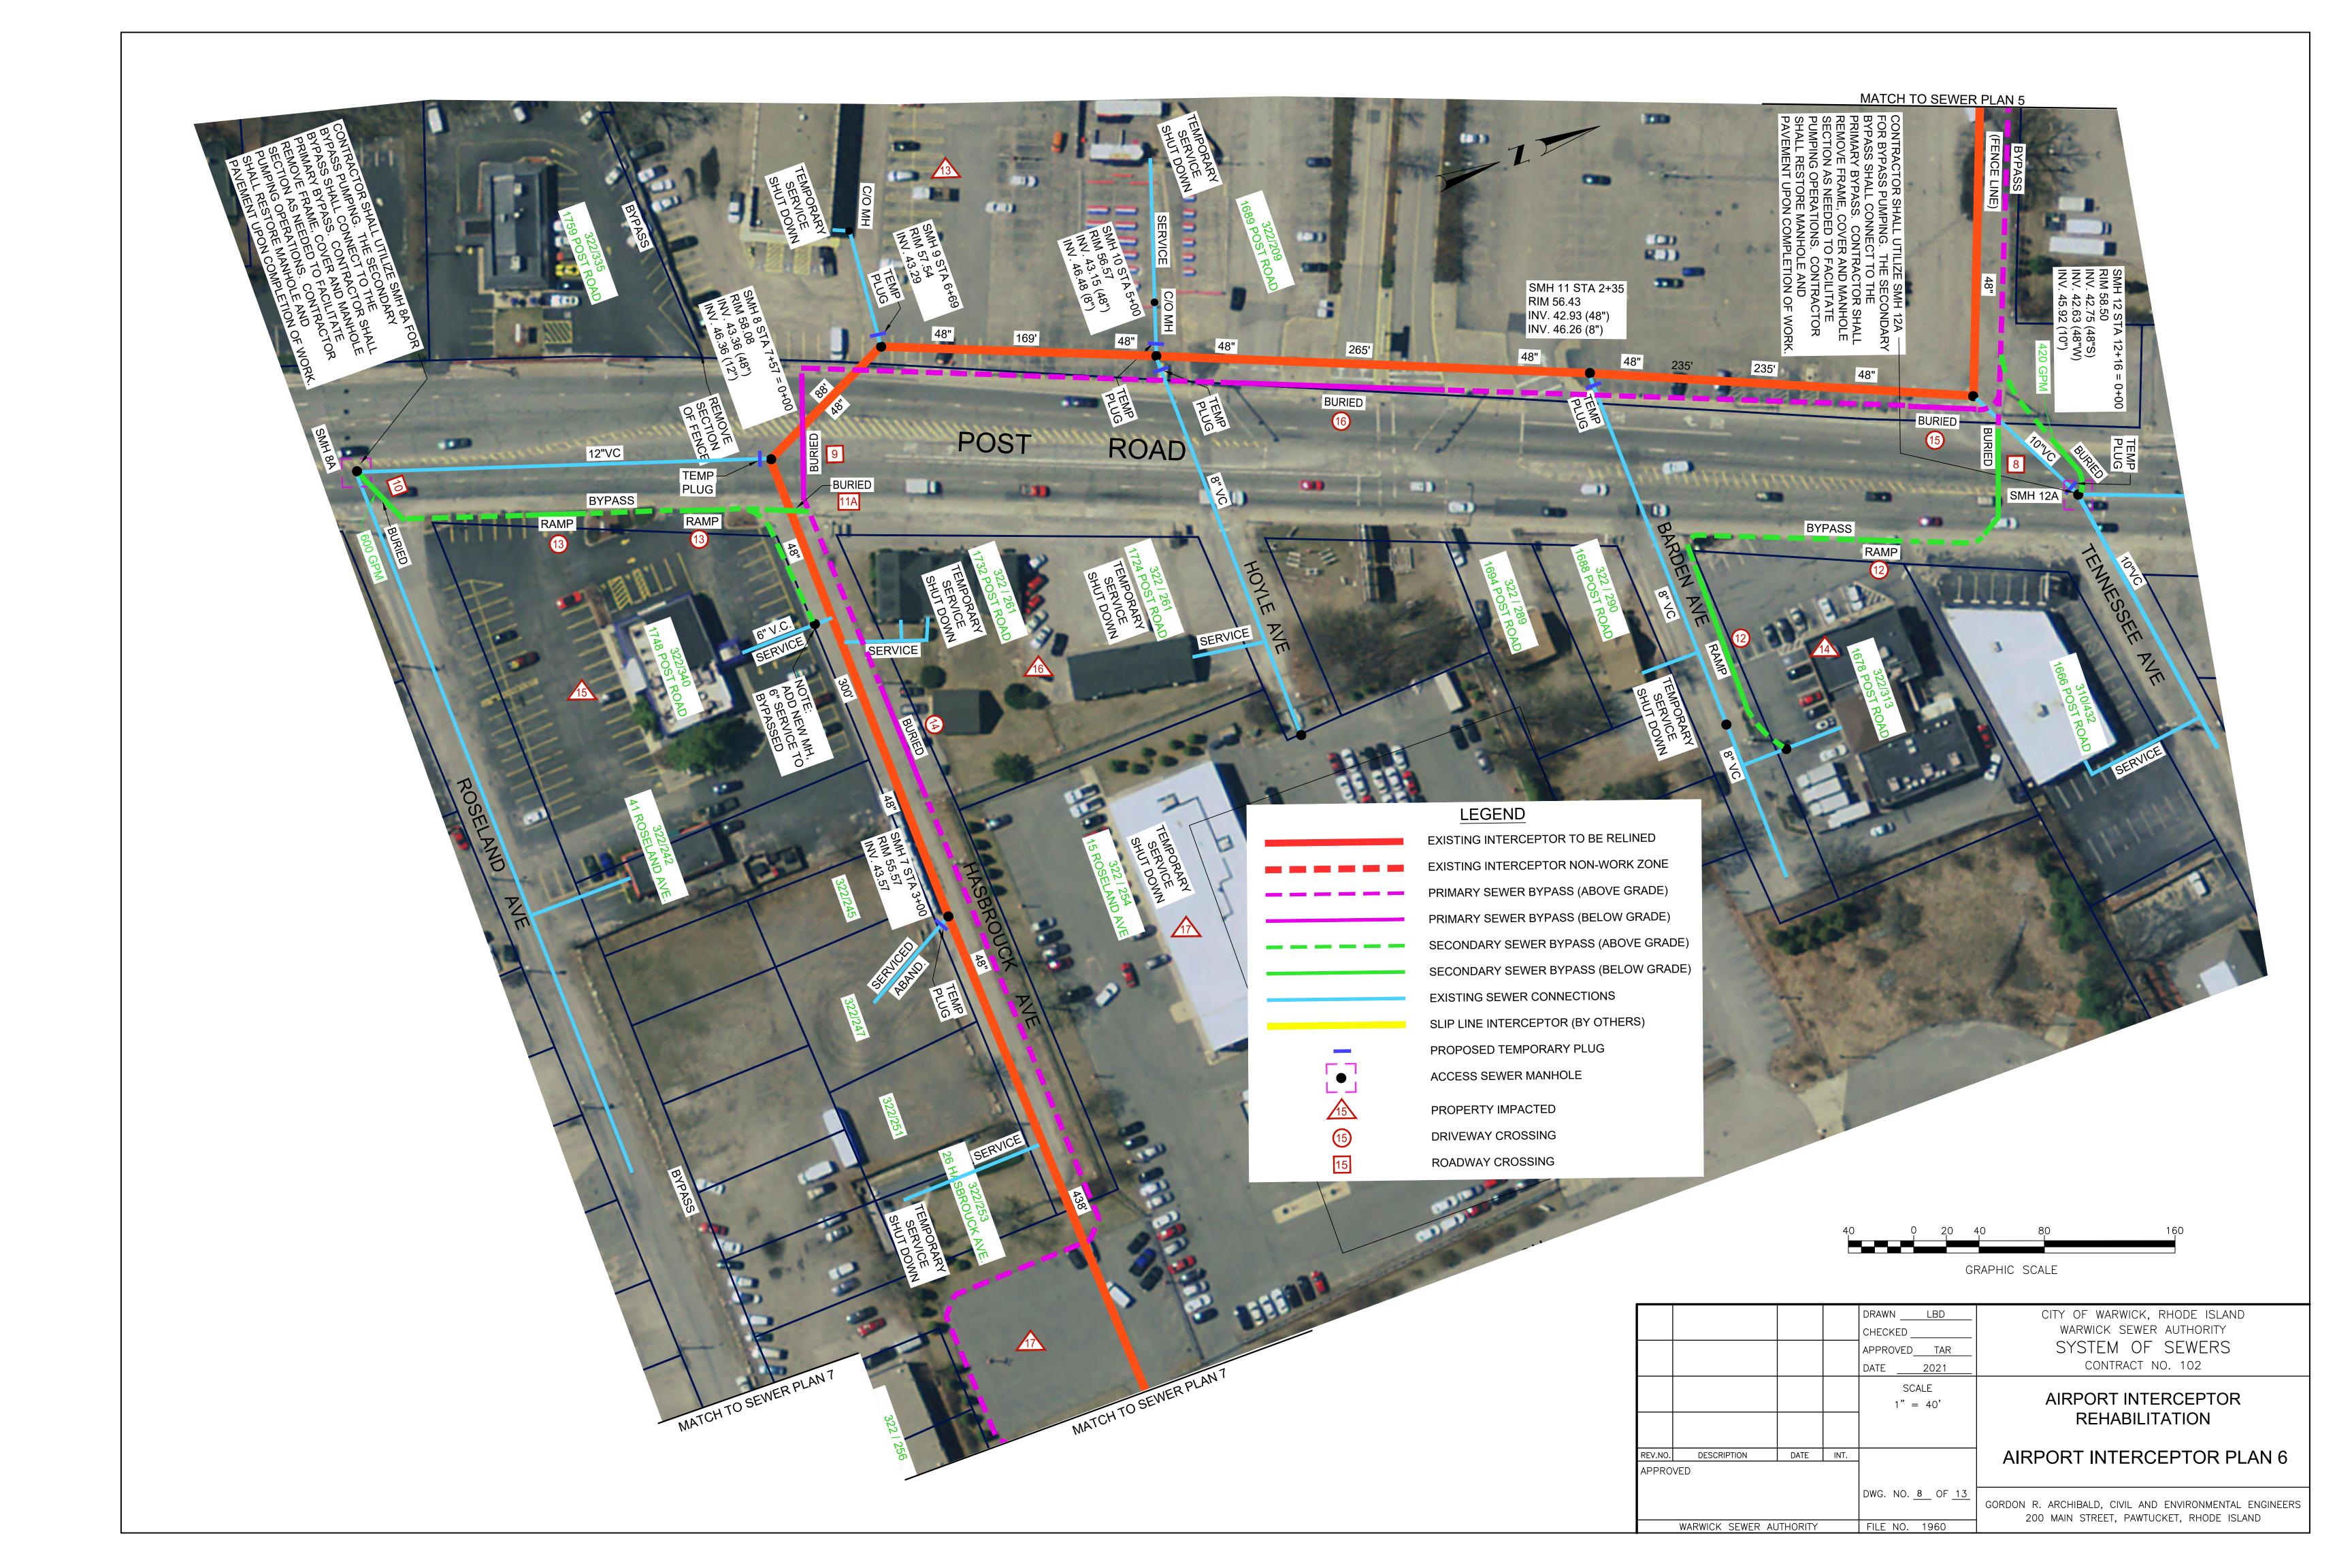


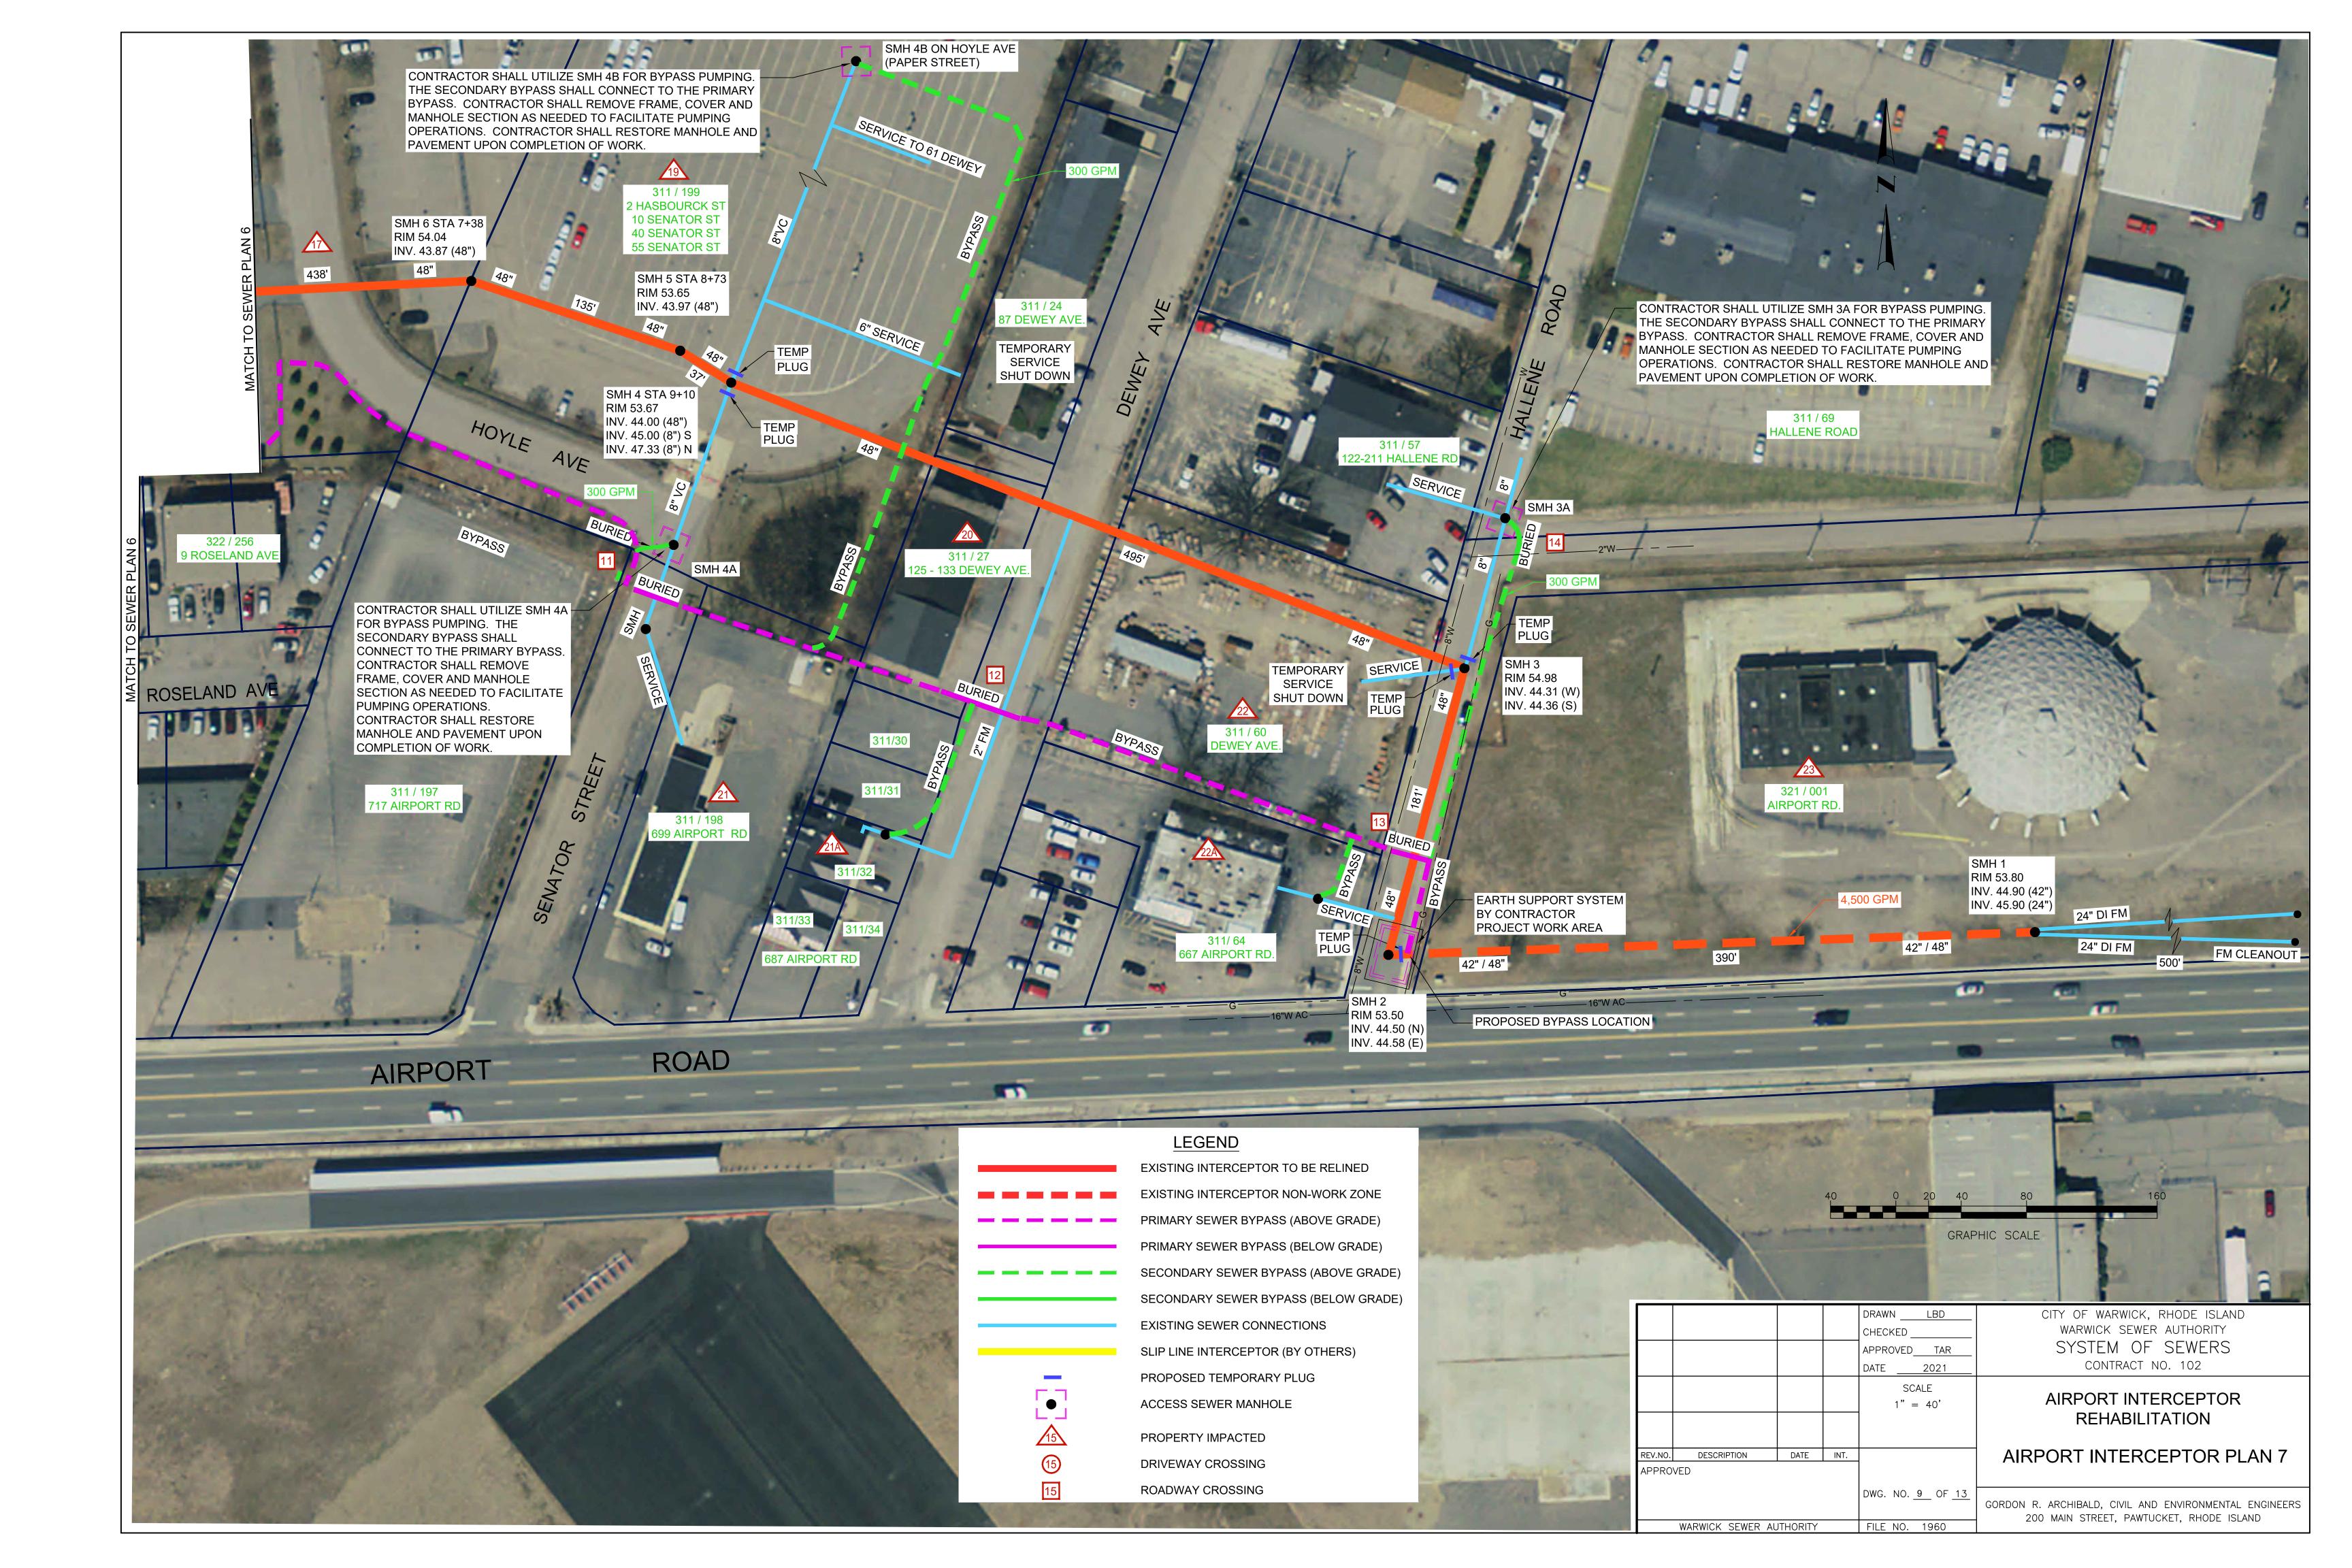



			PROPERTIES IMPACTED BY AIRPORT IN	TERCEPTOR A
NO.	PROPERTY ADDRESS	PROP. ID	ТҮРЕ	OWNER
1	45 ACCESS ROAD	280/010	BYPASS / DOG HOUSE INSTALLATION	VIESSMANN MANUFACTURING COMPANY (US) INC
2	55 ACCESS ROAD	280/007	ACCESS SEWER MANHOLE	FIFTY FIVE ACCESS ROAD LLC
2A	33 PLAN WAY	280/005	BYPASS	33 PLAN WAY LLC
3	77 PLAN WAY	280/011	BYPASS/ACCESS SEWER MANHOLE	UNITED PARCEL SERVICES INC
4	171 SERVICE ROAD	280/004	BYPASS	SERVICE AVE REALTY LLC
4A	30 PLAN WAY	279/046	ACCESS SEWER MANHOLE	MOANALUA ASSOCIATES
5	361 JEFFERSON BLVD	279/022	BYPASS	UNITED REALTY CORP
6	55 SERVICE ROAD	279/029	BYPASS/ACCESS SEWER MANHOLE	A T WALL REALTY COMPANY
7	30 SERVICE ROAD	279/032	ACCESS SEWER MANHOLE	V6 REALTY LLC
8	380 JEFFERSON BLVD	279/001	BYPASS	LINCOLN THOMAS DEVELOPMENT LLC
9	340 JEFFERSON BLVD	282/201	BYPASS/DOG HOUSE INSTALLATION	BAR RI LLC
10	AMTRAK	UNKNOWN	SLIP LINE PIPE	AMTRAK
11	141 MICHIGAN AVENUE	310/409	BYPASS/DOG HOUSE INSTALLATION	MULLER, AMBER M
12	PARK	310/001	BYPASS/STORAGE AREA	STATE OF RHODE ISLAND
13	1689 POST ROAD	322/209	BYPASS	MIMS REALTY LLC/ANN & HOPE OF RI INC.
14	1678 POST ROAD	322/313	BYPASS/ACCESS SEWER MANHOLE	BARDEN AVENUE LLC
15	1748 POST ROAD	322/340	BYPASS/ACCESS SEWER MANHOLE	JANCO CENTRAL INC.
16	1732 POST ROAD	322/261	BYPASS	MANZI FAMILY L/P
17	15 ROSELAND	322/254	BYPASS	STATE OF RHODE ISLAND
19	2 HASBOURCK, 10, 40, & 55 SENATOR STREET	311/199	BYPASS/ACCESS SEWER MANHOLE	AVIS RENT A CAR SYSTEMS INC., HERTZ CORPORATION, BUDGET RENT-A-CAR SYSTEM, INC., STATE OF RHODE ISLAND
20	125/133 DEWEY STREET	311/027	BYPASS	RE COOGAN HEATING INC
21	699 AIRPORT ROAD	311/098	BYPASS	MANCINI ELSIE TRUST
21A	687 AIRPORT ROAD	311/32	BYPASS/ACCESS SEWER MANHOLE	685 AIRPORT ROAD LLC
22	DEWEY AVENUE	311/060	BYPASS	DEWEY AVENUE LLC
22A	667 AIRPORT ROAD	311/064	BYPASS/ ACCESS SEWER MANHOLE	CONCORD REALTY CORP
23	AIRPORT ROAD	321/001	BYPASS/ACCESS SEWER MANHOLE	DEWEY AVENUE LLC

	AIRPORT INTERCEPTOR - DRIVEWAY CROSSING IMPACTS (X)								
NO.	PROPERTY ADDRESS	PROP. ID	TYPE	OWNER	TREATMENT	REASON			
1	77 PLAN WAY	280/011	DRIVEWAY- 1	UNITED PARCEL SERVICES	BURIED	HIGH VOLUME			
2	77 PLAN WAY	280/011	DRIVEWAY -2	UNITED PARCEL SERVICES	BURIED	HIGH VOLUME			
3	171 SERVICE ROAD	280/004	DRIVEWAY	SERVICE AVE REALTY LLC	BURIED	HIGH VOLUME/TRUCK TRAFFIC			
4	55 SERVICE ROAD	279/029	DRIVEWAY - 1	A T WALL REALTY COMPANY	BURIED	HIGH VOLUME/TRUCK TRAFFIC			
5	55 SERVICE ROAD	279/029	DRIVEWAY - 2	A T WALL REALTY COMPANY	BURIED	HIGH VOLUME/TRUCK TRAFFIC			
6	361 JEFFERSON BLVD	279/022	DRIVEWAY	UNITED REALTY CORP	BURIED	HIGH VOLUME/TRUCK TRAFFIC			
7	380 JEFFERSON BLVD	279/001	DRIVEWAY - 1	LINCOLN THOMAS DEVELOPMENT LLC	CLOSED	CLOSED DRIVEWAY/BARRIER			
8	380 JEFFERSON BLVD	279/001	DRIVEWAY - 2	LINCOLN THOMAS DEVELOPMENT LLC	BURIED	TRUCK TRAFFIC			
9	380 JEFFERSON BLVD	279/001	DRIVEWAY - 3	LINCOLN THOMAS DEVELOPMENT LLC	CLOSED	CLOSED DRIVEWAY/BARRIER			
10	380 JEFFERSON BLVD	279/001	DRIVEWAY - 4	LINCOLN THOMAS DEVELOPMENT LLC	BURIED	TRUCK TRAFFIC			
11	340 JEFFERSON BLVD	282/201	DRIVEWAY	BAR RI LLC	BURIED	TRUCK TRAFFIC			
12	1678 POST ROAD	322/313	DRIVEWAY-1 & 2	BARDEN AVENUE LLC	RAMPED	HIGH VOLUME			
13	1748 POST ROAD	322/340	DRIVEWAY- 1 & 2	JANCO CENTRAL INC.	RAMPED	HIGH VOLUME			
14	1732 POST ROAD	322/261	DRIVEWAY	MANZI FAMILY L/P	BURIED	BUSINESS			
15	1689 POST ROAD	322/209	DRIVEWAY- 1	MIMS REALTY LLC/ANN & HOPE OF RI INC.	BURIED	BUSINESS			
16	1689 POST ROAD	322/209	DRIVEWAY - 2	MIMS REALTY LLC/ANN & HOPE OF RI INC.	BURIED	BUSINESS			

AIRPORT ROAD INTERCEPTOR - ROADWAY CROSSINGS X							
NO.	LOCATION	REFERENCE	TREATMENT	REASON			
1	PLAN WAY	SMH No. 29A	BURIED	HIGH VOLUME/TRUCK TRAFFIC			
2	SERVICE ROAD	PLAN WAY	BURIED	HIGH VOLUME/TRUCK TRAFFIC			
3	JEFFERSON BLVD	SERVICE ROAD	BURIED	HIGH VOLUME/TRUCK TRAFFIC			
4	JEFFERSON BLVD	SMH No. 20A	BURIED	HIGH VOLUME/TRUCK TRAFFIC			
5	JEFFERSON BLVD	SMH No. 19A	BURIED	HIGH VOLUME/TRUCK TRAFFIC			
6	MICHIGAN AVENUE	SMH No. 16B	BURIED	CITY STREET			
6A	MICHIGAN AVENUE	SMH No. 16	BURIED	CITY STREET			
7	KENTUCKY AVENUE	SMH No. 16A	BURIED	CITY STREET			
8	POST ROAD	SMH No. 12A	BURIED	HIGH VOLUME/TRUCK TRAFFIC			
9	POST ROAD	1759 POST ROAD	BURIED	HIGH VOLUME/TRUCK TRAFFIC			
10	POST ROAD	SMH No. 8A	BURIED	HIGH VOLUME/TRUCK TRAFFIC			
11	SENATOR STREET	SMH No. 4A	BURIED	CITY STREET			
11A	HASBROUCK AVENUE	SMH NO. 8	BURIED	CITY STREET			
12	DEWEY STREET	125/133 DEWEY STREET	BURIED	CITY STREET			
13	HALLENE ROAD	SMH No. 3	BURIED	CITY STREET			
14	HALLENE ROAD	SMH No. 3A	BURIED	CITY STREET			

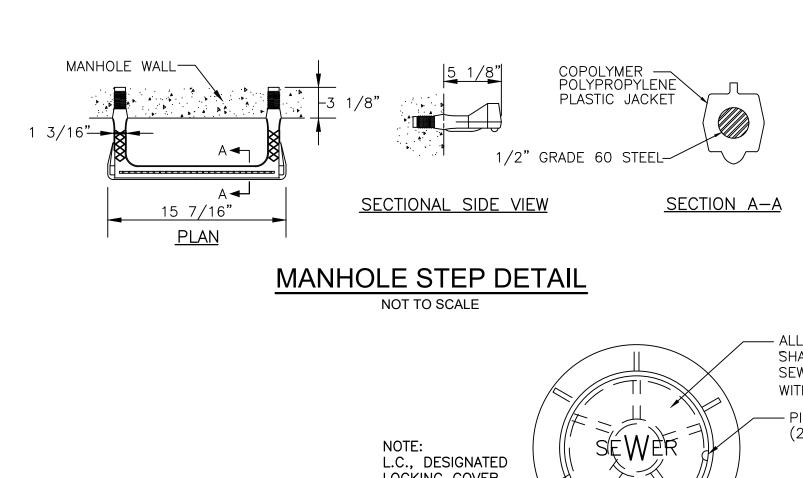

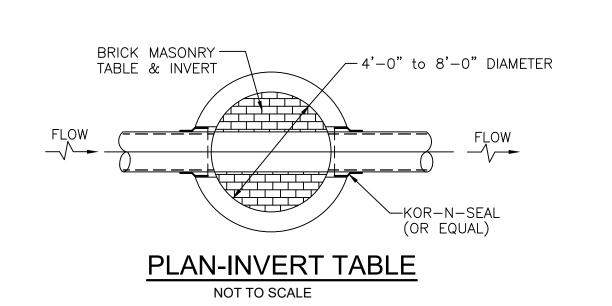

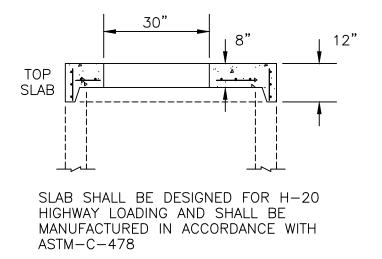


FLAT SLAB TOP DETAIL NOT TO SCALE

- PRECAST CONCRETE

— 6" MIN. SELECT MATERIAL


BASE SECTION

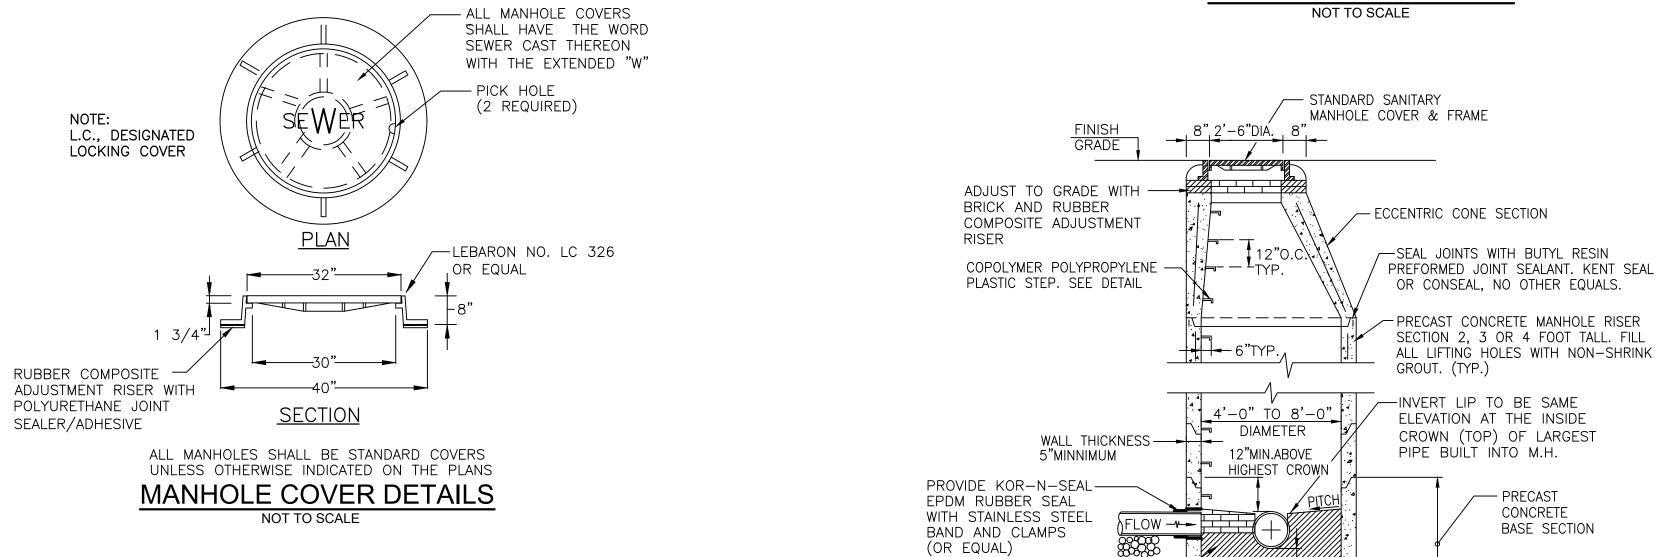

SANITARY SEWER MANHOLE DETAIL NOT TO SCALE


				DRAWN LBD CHECKED APPROVED TAR DATE 2021	CITY OF WARWICK, RHODE ISLAND WARWICK SEWER AUTHORITY SYSTEM OF SEWERS CONTRACT NO. 102
				SCALE AS NOTED	AIRPORT INTERCEPTOR REHABILITATION
REV.NO.	DESCRIPTION VED	DATE	INT.		DETAILS - 1
	WARWICK SEWER AL	UTHORITY		DWG. NO. <u>10</u> OF <u>13</u> FILE NO. 1960	GORDON R. ARCHIBALD, CIVIL AND ENVIRONMENTAL ENGINEERS 200 MAIN STREET, PAWTUCKET, RHODE ISLAND

BRICK MASONRY TABLE -AND INVERT

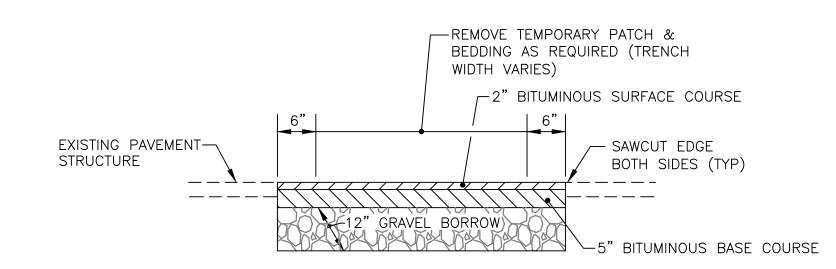

PERMANENT PAVEMENT RESTORATION (STATE ROADS)


NOT TO SCALE

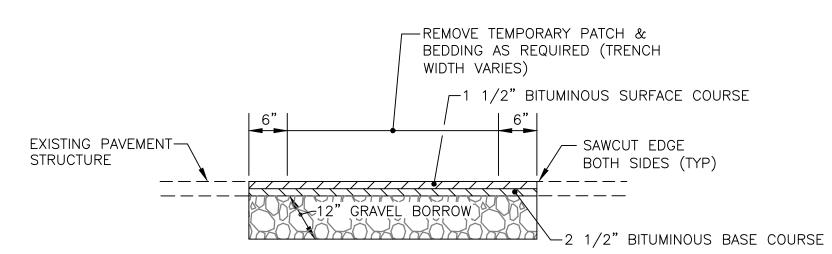

PERMANENT PAVEMENT RESTORATION


(CITY STREETS)

NOT TO SCALE

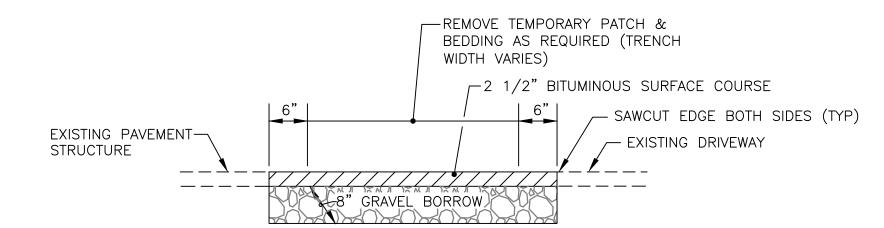


PERMANENT PAVEMENT RESTORATION (DRIVEWAYS)


NOT TO SCALE

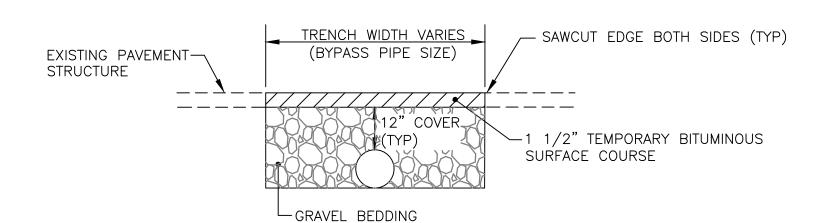

BYPASS PIPE TRENCH DETAIL NOT TO SCALE

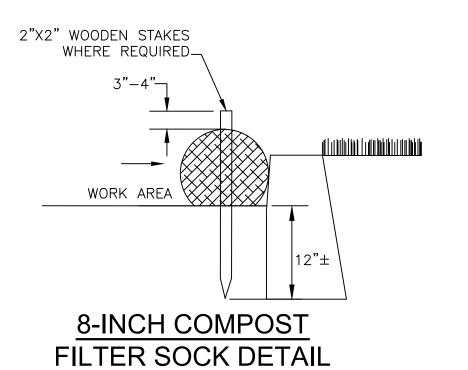

NOT TO SCALE

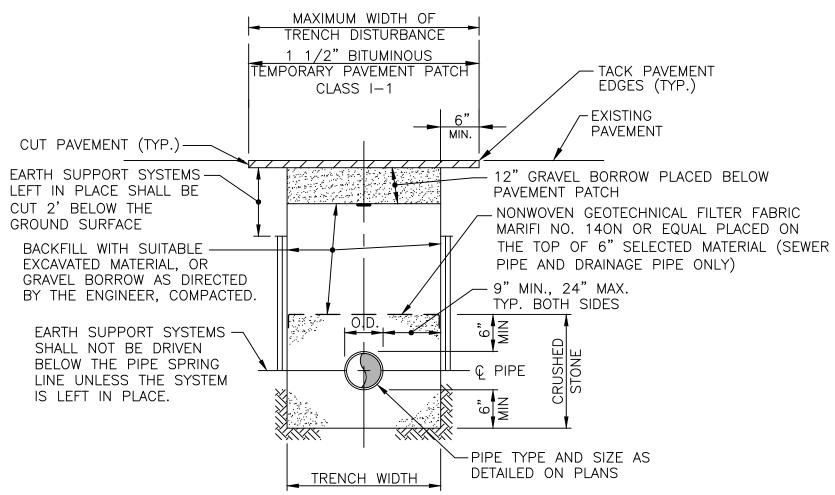


TYPICAL TRENCH DETAIL FOR SEWER

NOT TO SCALE

NOTES;

- 1. THE HORIZONTAL LIMIT FOR ROCK EXCAVATION IN TRENCHES SHALL BE 27" BEYOND THE O.D. OF THE PIPE. THE VERTICAL LIMIT SHALL BE 6" BELOW THE O.D. OF THE PIPE. CONTRACTOR TO TAKE ALL ROCK QUANTITIES INDEPENDENT OF THE ENGINEER AND CONFIRM THESE QUANTITIES ON A WEEKLY BASIS WITH THE ENGINEER FOR APPROVAL. ALL APPROVED CALCULATIONS AND QUANTITIES SHALL BE SUBMITTED TO THE WSA FOR REVIEW.
- 2. CONTRACTOR SHALL ADJUST THE WIDTH OF SAW CUT OF EXISTING PAVEMENT BASED ON ACTUAL EQUIPMENT AND EARTH SUPPORT SYSTEM USED. MAXIMUM WIDTH OF DISTURBANCE SHALL BE WIDTH OF EARTH SUPPORT SYSTEM PLUS 1'-O".
- 3. BEDDING MATERIAL FOR SEWER PIPE SHALL BE CRUSHED STONE.
- 4. CONTRACTOR SHALL PROTECT ALL UTILITIES FROM DAMAGE AND IS RESPONSIBLE FOR REPAIR OF ALL UTILITIES DAMAGED OUTSIDE THE LIMIT OF DISTURBANCE.

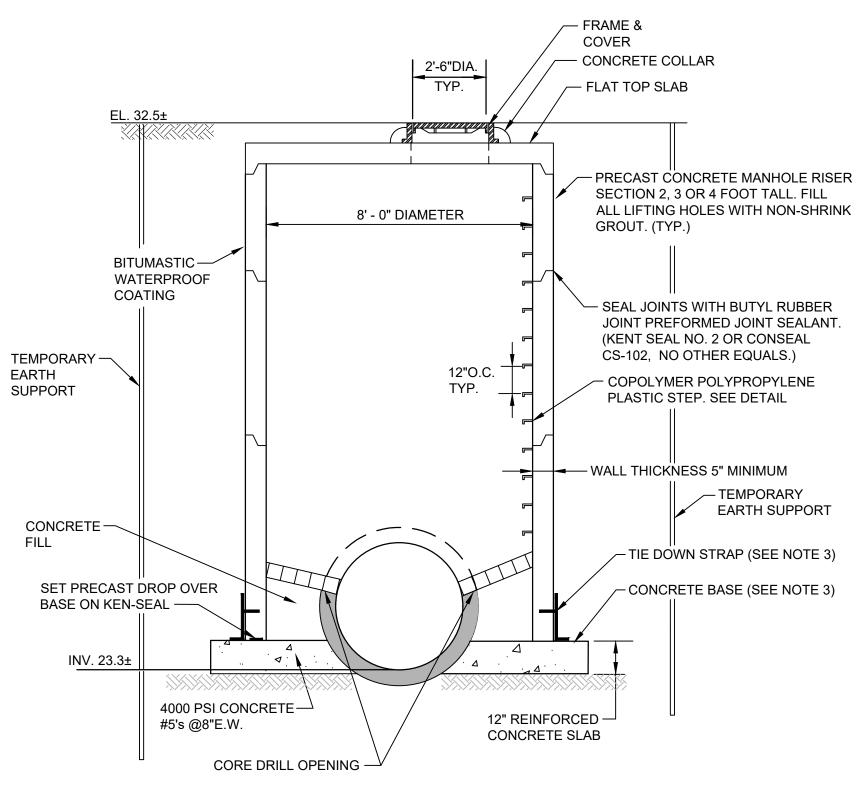


NOTES:

- 1. ALL JOINTS SHALL BE TONGUE AND GROOVE WITH BUTYL RUBBER JOINT PREFORMED SEALANT.
- 2. ALL LIFTING HOLES OR IDENTS ARE TO BE SEALED WITH NON-SHRINKING (HYDRAULIC CEMENT) GROUT.
- CONCRETE FLOATATION RESISTANT BASE SHALL BE PROVIDED IF REQUIRED BY DESIGN. THE SLAB SHALL BE ATTACHED TO THE PRECAST MANHOLE WITH A MINIMUM OF 4 EQUALLY SPACED STAINLESS STEEL (SS) TIE DOWN STRAP ANCHORS. STAINLESS STEEL TIE DOWN STRAP ANCHORS SHALL BE A ½" X 4" TYPE 316 SS BENT PLATE (MIN) ATTACHED TO THE MH WITH 2 ½" DI. SS THROUGH BOLTS (MIN).

DOGHOUSE AND PUMP MANHOLE DETAIL


NOT TO SCALE

			BYPASS FLOW S	SUMMARY CHART				
	APPROXIMATE SMH NO. 2 SMH NO. 3A SMH NO. 3A SMH NO. 4B SMH							
PUMP BYPASS	BYPASS LOCATION	BYPASS START AND END	PLAN SHEET		INFLOW			SURFACE ELEVATION
PRIMARY	SMH NO. 2	SMH NO. 2/ DISCHARGE SMH 17A	7	42	39	0.0007	4,500	59
SECONDARY	SMH NO. 3A	SMH NO. 3A / PRIMARY BYPASS	7	8	45	0.004	300	55
SECONDARY	SMH NO. 4B	SMH NO. 4B / PRIMARY BYPASS	7	8	48	0.004	300	54
SECONDARY	SMH NO. 4A	SMH NO. 4A / PRIMARY BYPASS	7	8	46	0.004	300	54
SECONDARY	SMH NO. 8A	SMH NO. 8A / PRIMARY BYPASS	6	12	47	0.0022	600	58
SECONDARY	SMH NO. 12A	SMH NO. 12A / PRIMARY BYPASS	6	10	46	0.0028	420	57
SECONDARY	SMH NO. 16A	SMH NO. 17A / DISCHARGE	5	8	47	0.004	300	59
SECONDARY	SMH NO. 16B	SMH NO. 16 / SEC. BYPASS	5	10	46	0.0028	500	58
		FLOW AT DISCHARGE SMH NO. 17A					6,500	
PRIMARY	SMH NO. 17	SMH NO. 17 / DISCHARGE SMH NO. 31	5	48/42	41	0.0012	6,500	28
SECONDARY	SMH NO. 19A	SMH NO. 19A / PRIMARY BYPASS	4	8	45	0.0012	300	58
SECONDARY	SMH NO. 20A	SMH NO. 20A / PRIMARY BYPASS	4	12	43	0.0022	600	57
SECONDARY	SMH NO. 24A	SMH NO. 24A / PRIMARY BYPASS	4	27	29	0.0045	2,000	38
		FLOW AT DOGHOUSE SMH NO. 31			·		8,500	
SECONDARY	SMH NO. 29A	SMH NO. 29A / SEC. BYPASS	3	12	27	0.0022	500	39
SECONDARY	SMH NO. 29B	SECONDARY BYPASS / SERVICE RD	3	42	26	0.0004	5,000	40
		FLOW AT DOGHOUSE SMH NO. 31					5,500	
SECONDARY	SMH NO. 31B	SMH NO. 31 / SEC. BYPASS	1	10	27	0.0028	500	33
		FLOW AT DOGHOUSE SMH NO. 31					500	
					DISCHARGE AT DOGH	DUSE SMH NO. 31	12,000	

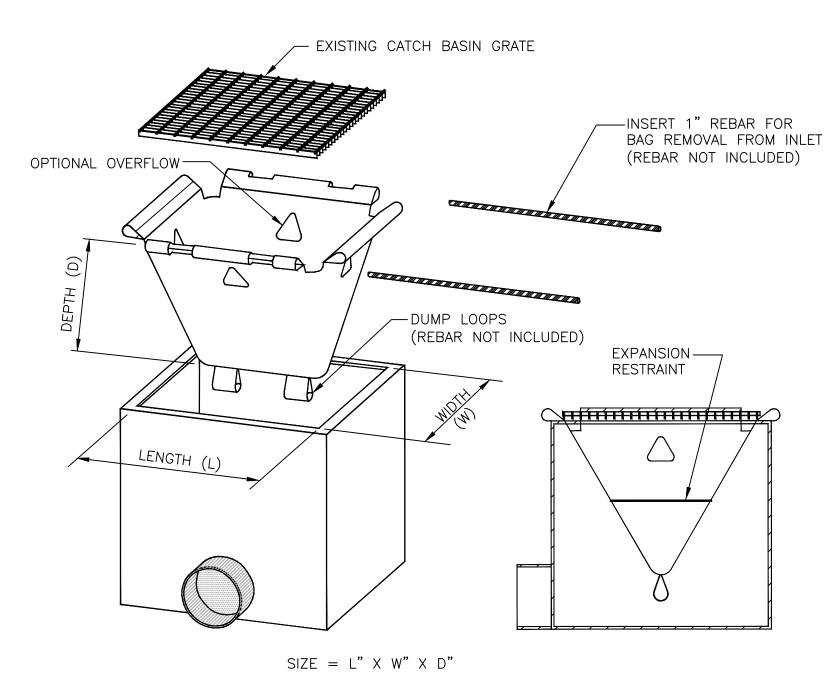

CATCH BASIN PROTECTION DETAIL

				DRAWNLBD	CITY OF WARWICK, RHODE ISLAND WARWICK SEWER AUTHORITY SYSTEM OF SEWERS CONTRACT NO. 102
				SCALE AS NOTED	AIRPORT INTERCEPTOR REHABILITATION
REV.NO.	DESCRIPTION	DATE	INT.		DETAILS - 2
APPRO	VED				
	WARWICK SEWER A	LITUODITY		DWG. NO. <u>11</u> OF <u>13</u> FILE NO. 1960	GORDON R. ARCHIBALD, CIVIL AND ENVIRONMENTAL ENGINEER 200 MAIN STREET, PAWTUCKET, RHODE ISLAND
	WARWICK SEWER A	OHIOMHI		TILL NO. 1900	

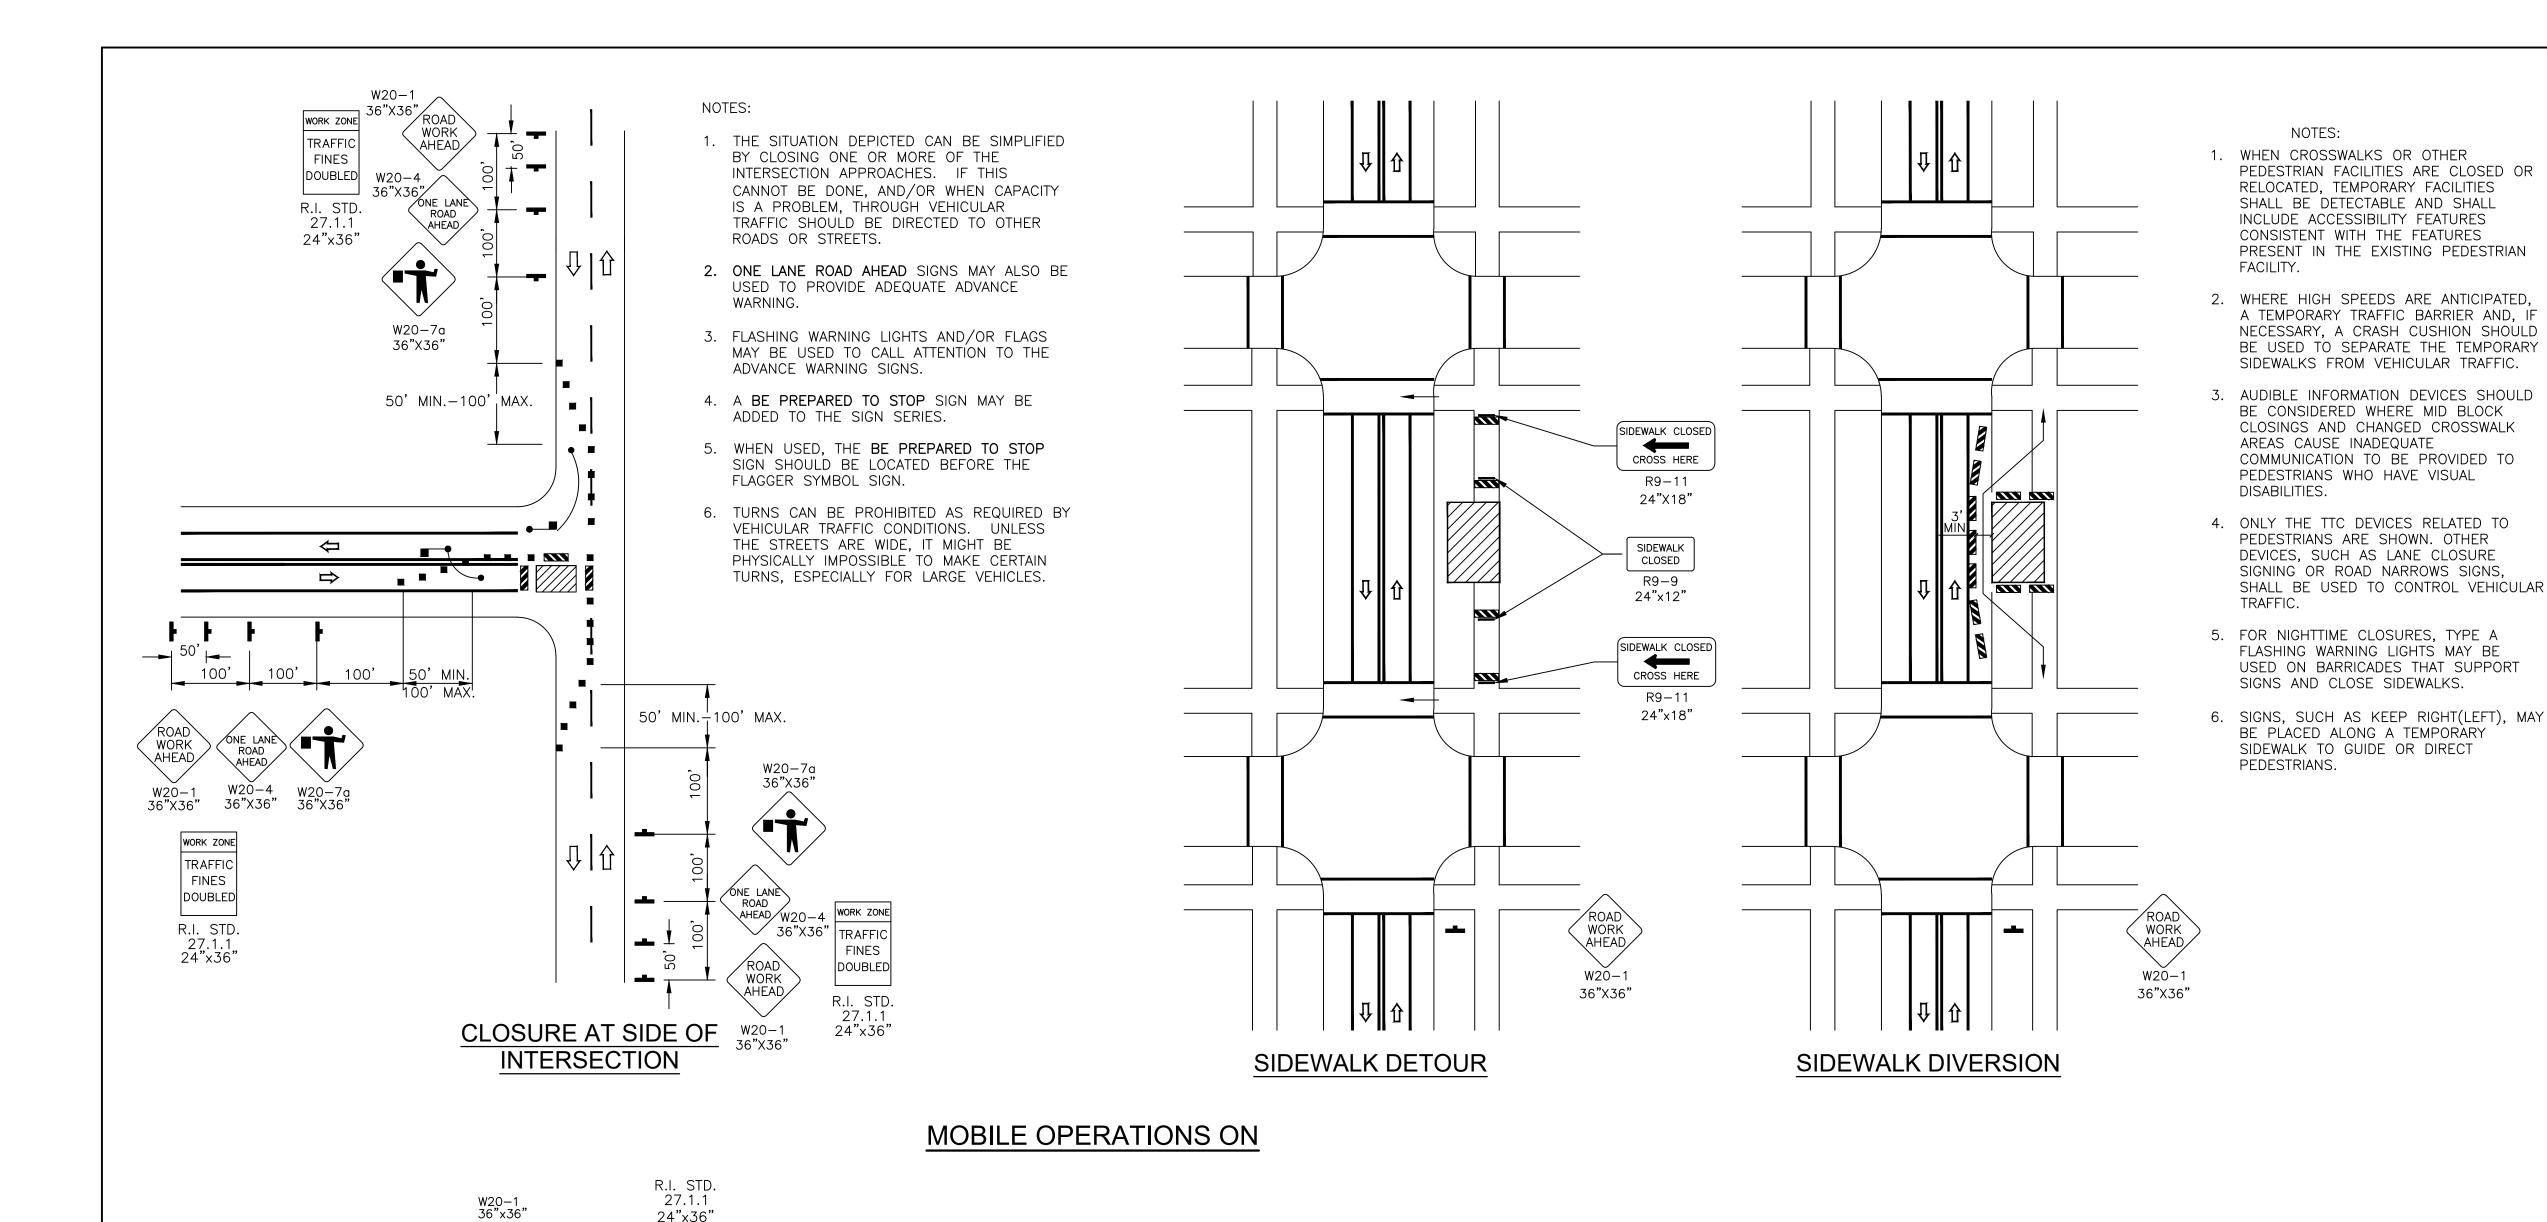

NOTES:

- 1. ALL TEMPORARY TRAFFIC CONTROL SET-UPS AND DEVICES AND THEIR INSTALLATION, MAINTENANCE, AND REMOVAL SHALL CONFORM TO THE LATEST EDITION OF "THE MANUAL ON UNIFORM TRAFFIC CONTROL DEVICES" (MUTCD) WITH ALL REVISIONS, AND THE LATEST EDITION OF THE "RIDOT STANDARD SPECIFICATIONS FOR ROAD AND BRIDGE CONSTRUCTION" WITH ALL REVISIONS
- 2. ALL TEMPORARY TRAFFIC CONTROL DEVICES SHALL BE IN PLACE PRIOR TO THE START OF WORK.
- 3. ALL TEMPORARY TRAFFIC CONTROL DEVICES SHALL BE REMOVED AS SOON AS PRACTICAL WHEN THEY ARE NO LONGER NEEDED. WHEN WORK IS SUSPENDED FOR SHORT PERIODS OF TIME, TEMPORARY TRAFFIC CONTROL DEVICES THAT ARE NO LONGER APPROPRIATE SHALL BE REMOVED OR
- 4. DISTANCES ARE A GUIDE AND MAY BE ADJUSTED IN THE FIELD BY THE
- 5. WHERE A SIDE STREET OR RAMP INTERSECTS THE WORK ZONE, ADDITIONAL TEMPORARY TRAFFIC CONTROL DEVICES SHALL BE INSTALLED IN ACCORDANCE WITH PART 6 OF THE MUTCD.
- 6. THE CONTRACTOR SHALL INSTALL AND MAINTAIN A RHODE ISLAND STANDARD 26.2.0 BARRICADE WITH APPROPRIATE MARKINGS AT EACH LOCATION WHERE ADJUSTMENT TO UTILITY STRUCTURES HAVE BEEN MADE UNTIL RESURFACING WORK HAS BEEN PERFORMED. OTHER TYPES OF PROTECTIVE DEVICES MAY BE USED IF APPROVED BY THE ENGINEER.
- 7. R.I. STD. 26.1.0 CONES SHALL BE USED WHEN TRAFFIC CONTROL SET-UP IS UTILIZED ONLY DURING WORKING HOURS AND IS SUBSEQUENTLY REMOVED AT THE END OF THE WORKDAY. R.I. STD. 26.2.0 SHALL BE USED WHEN A TRAFFIC CONTROL SET-UP WILL REMAIN BEYOND WORKING HOURS WHEN NO WORKERS ARE PRESENT ..
- 8. THE SIZES OF ALL DIAMOND SHAPED ADVANCE WARNING SIGNS SHALL BE 36"X36", UNLESS OTHERWISE NOTED.
- 9. MAXIMUM SPACING OF THE CHANNELIZATION DEVICES IN A TAPER IS EQUAL IN FEET TO THE SPEED LIMIT IN MPH. MAXIMUM SPACING OF CHANNELIZATION DEVICES IN A TANGENT SECTION IS EQUAL IN FEET TO TWO TIMES THE SPEED LIMIT IN MPH.
- 10. IF THE WORK SPACE EXTENDS ACROSS A CROSSWALK, THE CROSSWALK SHOULD BE CLOSED USING THE INFORMATION AND DEVICES SHOWN IN SIDEWALK DETOUR.


LEGEND

- CHANNELIZING DEVICE TRAFFIC CONE (R.I. STD. 26.1.0)
 - DRUM BARRICADE (R.I. STD. 26.2.0)
- SIGN ON PORTABLE SIGN SUPPORT TYPE III BARRICADE
- FLASHING ARROW BOARD
- TRAFFIC PERSON
- WORK SPACE
- DIRECTION OF TRAVEL
- WORK VEHICLE
- TRUCK-MOUNTED ATTENUATOR



ARROW PANEL

CONE S	SPACING
TAPER	TANGENT
25'	50'

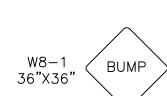

TYPICAL PROJECT LIMIT DETAIL

ROADWAY

MISCELLANEOUS USE SIGNS

				DRAWNLBD	
				CHECKED	
				APPROVEDTAR	
				DATE <u>2021</u>	
				SCALE	
				AS NOTED	
REV.NO.	DESCRIPTION	DATE	INT.		N
APPROVE	D				
				DWG. NO. <u>12</u> OF <u>13</u>	

FILE NO. 1960

WARWICK SEWER AUTHORITY

PROJECT WORK LIMIT

200'

ROAD WORK

G20-2

AIRPORT INTERCEPTOR **REHABILITATION** AINTANANCE AND PROTECTION

GORDON R. ARCHIBALD, CIVIL AND ENVIRONMENTAL ENGINEERS 200 MAIN STREET, PAWTUCKET, RHODE ISLAND

OF TRAFFIC PLAN 1

CITY OF WARWICK, RHODE ISLAND

WARWICK SEWER AUTHORITY

SYSTEM OF SEWERS

CONTRACT NO. 102

NOTES:

24"x36"

WORK ZONE

TRAFFIC FINES DOUBLED

TWO-WAY TRAFFIC TAPER

50' MIN. -100' MAX

LANE CLOSURE ON TWO

LANE ROAD USING FLAGGERS

R.I. STD.

27.1.1

24"x36"

WORK ZONE

TRAFFIC

FINES

DOUBLED

ONE LANE ROAD AHEAD

- 1. FOR LOW-VOLUME APPLICATIONS, WITH SHORT WORK ZONES ON STRAIGHT ROADWAYS WHERE THE FLAGGER IS VISIBLE TO ROAD USERS FROM BOTH DIRECTIONS, A SINGLE FLAGGER, POSITIONED TO BE VISIBLE TO ROAD USERS APROACHING FROM BOTH DIRECTIONS MAY BE USED.
- CHANNELIZING DEVICES ARE TO BE EXTENDED TO A POINT WHERE THEY ARE VISIBLE TO APPROACHING TRAFFIC.
- THE BUFFER SPACE SHOULD BE EXTENDED IF NECCESSARY SO THAT THE 100' MAX. TWO-WAY TRAFFIC TAPER IS PLACED BEFORE A HORIZONTAL (OR CREST VERTICAL) CURVE TO PROVIDE ADEQUATE SIGHT DISTANCE FOR THE FLAGGER AND A QUEUE OF STOPPED VEHICLES.
- 4. MAXIMUM SPACING OF CHANNELIZATION DEVICES IN THE 100' MAX. TWO-WAY TRAFFIC TAPERS IS 25 FEET. MAXIMUM SPACING OF CHANNELIZATION DEVICES IN A TANGENT SECTION IS EQUAL IN FEET TO TWO TIMES THE SPEED LIMIT IN MPH.
- MINIMUM LANE WIDTH IS TO BE 10 FEET UNLESS OTHERWISE SHOWN. MINIMUM LANE WIDTH TO BE MEASURED FROM THE EDGE OF CHANNELIZATION DEVICES OR TEMPORARY

WORK VEHICLE (optional) POLICE — CRUISER SET-UP TO BE MODIFIED ACCORDINGLY FOR WORK IN OPPOSITE LANE. BUFFER SPACE (optional) POLICE OFFICER TO DIRECT TRAFFIC AS REQUIRED. ADDITIONAL OFFICERS MAY BE USED AS NECESSARY. 36"X36" 27.1.1 24"x36" WORK ZONE FINES DOUBLED ROAD WORK AHEAD

LANE CLOSURE ON A

SIDE STREET

